

# RECONSTRUCTION OF ANTONIA CHARGUALAF HOUSE,




## Historic District of Inarajan, Municipality of Inarajan, Guam

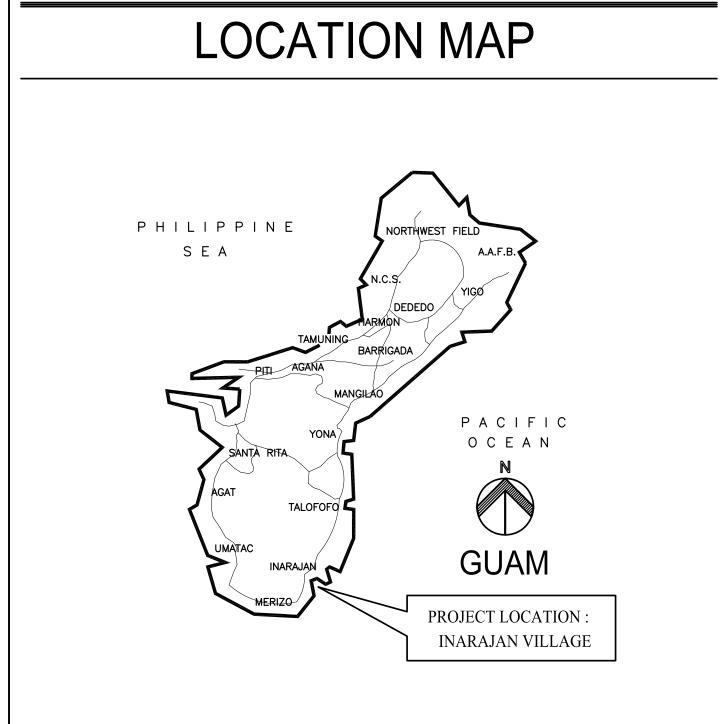

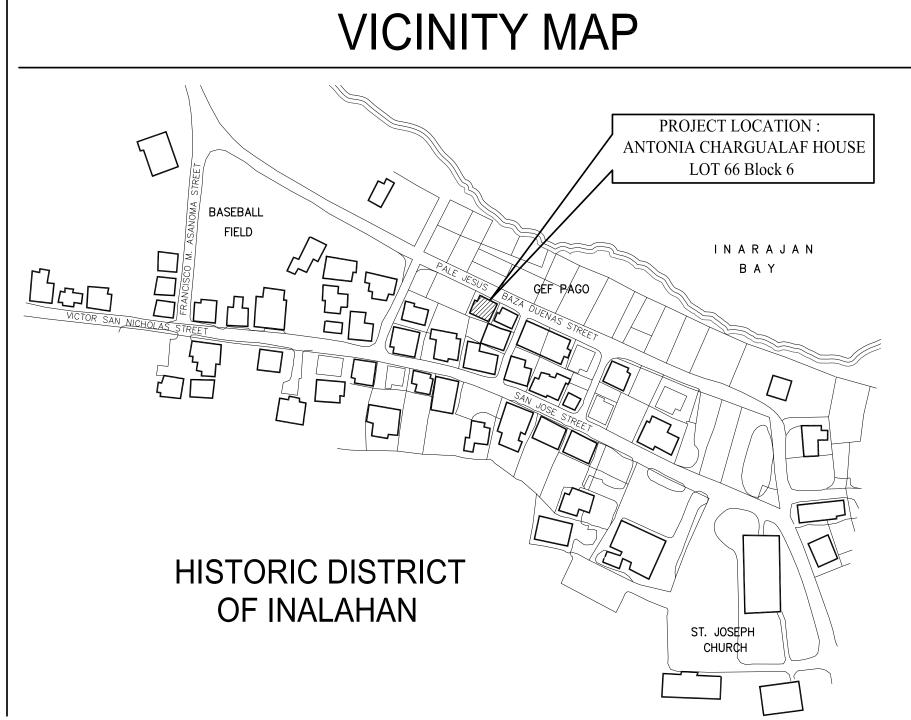

	LEGEND  SYMBOL DESCRIPTION  NEWLY ISSUED DRAWING  REVISED DRAWING	NOV 2014		H 40	NOV 2014			DATE	NOV 2014	
DWG SHEET NO	DRAWING NAME	DATE OF ISSUE	DWG SHEET NO	DRAWING NAME	DATE OF ISSUE	DWG SHEET NO	DRAWING NAME	REVISION	DATE OF ISSUE	
T-1	COVER SHEET	0	A5.2	CEILING DETAILS	0	S.3.1	TYPICAL COLUMN & COLUMN FOOTING DETAILS		0	
T-2	GENERAL NOTES	0	A6.1	FINISH SCHEDULE/INTERIOR ELEVATIONS	0	S.4.1	TYPICAL WALL & WALL FOOTING DETAILS		0	
	TOPOGRAPHIC SURVEY MAP	0	A6.2	INTERIOR ELEVATIONS/PARTITION SCHEDULE	0	S5.1	TYPICAL BEAM SECTIONS		0	
			A7.1	DOOR SCHEDULE	0	S5.2	TYPICAL BEAM ELEVATIONS		0	
			A7.2	WDW SCHEDULE	0	M1.0	GENERAL NOTES/LEGEND & ABBREVIATIONS/ EQUIPMENT SCHEDULE		0	
HP-1	EXIST ARCHITECTURAL FLOOR PLAN @ LOWER LEVEL	0	A7.3	SHUTTER SCHEDULE/HARDWARE SCHEDULE	0	M2.0	MECHANICAL PLAN @ BODEGA/GROUND LEVEL MECHANICAL PLAN @ UPPER LEVEL		0	
HP-2	EXIST ARCHITECTURAL FLOOR PLAN @ UPPER LEVEL	0	A8.1	CABINETWORK	0	M3.0	MISCELLANEOUS DETAILS		0	
HP-3	EXIST ARCHITECTURAL BLDG ELEVATION	0				P1.0	GENERAL NOTES/LEGEND & ABBREVIATIONS/ EQUIPMENT SCHEDULE/PLUMBING PLANS		0	
A0.1	SITE PLAN	0	S0.1	STRUCTURAL DESIGN CRITERIA/GENERAL NOTES/ TYPICAL DETAILS	0	P2.0	PLUMBING PLANS		0	
A0.2	PLANTING PLAN	0	S0.2	TYPICAL DETAILS	0	P3.0	PLUMBING ISOMETRICS		0	
A1.1	GROUND LEVEL DEMO PLAN	0	S0.3	TYPICAL DETAILS	0	P4.0	MISCELLANEOUS DETAILS		0	
A1.2	UPPER LEVEL DEMO PLAN	0	S1.1	FOUNDATION PLAN	0	E1.0	GENERAL NOTES & DIAGRAMS		0	
A2.1	GROUND/UPPER LEVEL FLOOR PLAN	0	S1.2	UPPER LEVEL FRAMING PLAN	0	E1.1	PANELS & LEGEND		0	
A2.2	ROOF PLAN	0	S1.3	LOWER ROOF FRAMING PLAN, UPPER ROOF FRAMING PLAN	0	E1.2	SITE PLAN & DETAILS		0	
A3.1	BLDG ELEVATIONS	0	S2.1	SECTION	0	E2.0	FIRST FLOOR POWER PLAN		0	
A4.1	BLDG SECTIONS	0	S2.2	SECTIONS	0	E2.1	SECOND FLOOR POWER PLAN		0	
A4.2	BLDG SECTIONS	0	S2.3	SECTION	0	E3.0	FIRST FLOOR LIGHTING PLAN		0	
A5.1	GROUND/ UPPER LEVEL REFLECT CLG PLAN	0	S2.4	SECTIONS	0	E3.1	SECOND FLOOR LIGHTING PLAN		0	

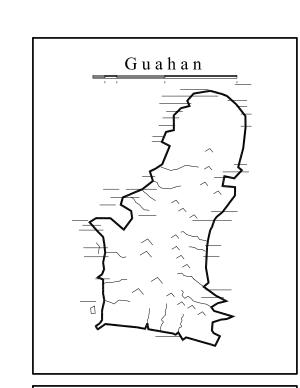

#### GUAM PRESERVATION TRUST

INANGOKKON INADAHI GUAHAN

OJECT TITLE:

RECONSTRUCTION of

ANTONIA C. CHARGUALAF HOUSE,

> HISTORIC DISTRICT OF INARAJAN, INARAJAN, GUAM

Provido •Tan•Jones
architects inc.



PTJA PROJECT NO: GPT.02

THIS WORK WAS DONE BY ME OR UNDER MY DIRECT SUPERVISION EXPIRATION DATE: APR, 2015

DRAWING NAME:

COVER SHEET

DRAWN: DT DATE: NOVEMBER 201


CHECKED: LP SCALE: AS NOTE:

REVISIONS:

DESCRIPTION DATE

DRAWING SHEET NO:

T-1

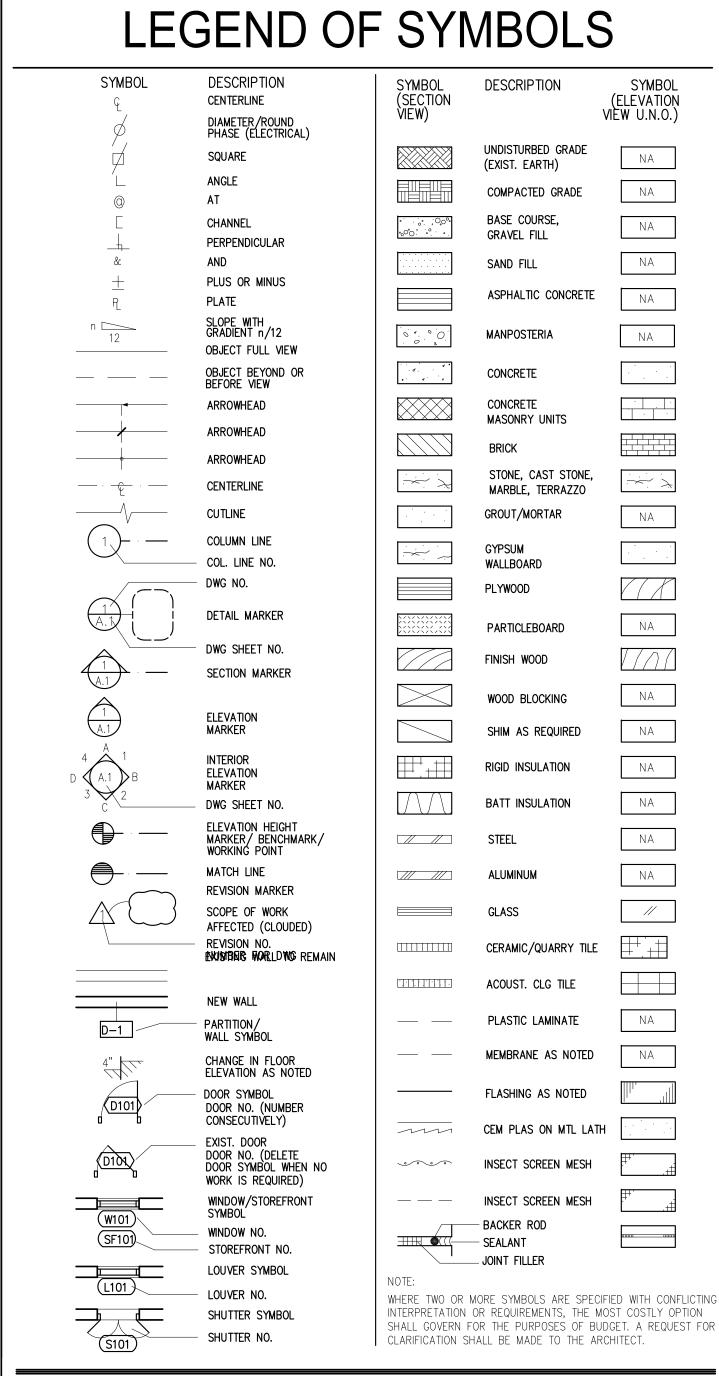

## **ABBREVIATIONS**

SYMBOL	DESCRIPTION	SYMBOL	DESCRIPTION	SYMBOL	DESCRIPTION
ABV	ABOVE	CONC	CONCRETE	FD	FLOOR DRAIN
AC	AIR CONDITIONING	CONF	CONFERENCE	FDTN	FOUNDATION
ACOUST	ACOUSTICAL	CORR	CORRIDOR	FE	FIRE EXTINGUISHER
ACT	ACOUSTICAL CEILING TILE	COORD	COORDINATE	FEC	FIRE EXTINGUISHER CABIN
ADA	AMERICANS WITH	CONT	CONTINUOUS	FFE	FURNISHINGS, FIXTURE
	DISABILITIES ACT	CONSTR	CONSTRUCTION		AND EQUIPMENT
ADAAG	AMERICANS WITH DISABILITY	CONTR	CONTRACTOR	FHC	FIRE HOSE CABINET
	ACT ACCESSIBILITY GUIDELINES	CPT	CARPET	FHEC	FIRE HOSE AND
	ADDITIONAL ALTERNATE	CSWK	CASEWORK		EXTINGUISHER CABINET
ADJ	ADJACENT	CT	CERAMIC TILE	FIN	FINISH
AFF ALUM	ABOVE FINISH FLOOR ALUMINUM	D	DRYER	FIXT	FIXTURE
ALOM	ANODIZED	DEPT	DEPARTMENT	FLASH	FLASHING
AP	ACCESS PANEL	DET	DETAIL	FLUOR	FLUORESCENT
APPROX	APPROXIMATE	DIA	DIAMETER	FLR	FLOOR
ARCH	ARCHITECTURAL	DIM	DIMENSION	FOY	FOYER
ARCH'T	ARCHITECT	DN	DOWN	FP	FIRE PROTECTION
AUTO	AUTOMATIC	DO	DITTO	FR	FRAME
BAL	BALANCE	DR	DOOR	FS	FLOOR SINK
BAL	BALCONY	DS	DOWNSPOUT	FURR	FURRING
BETW	BETWEEN	DWG	DRAWING	FT	FOOT (FEET)
BEY'D	BEYOND	DWR	DRAWER	FTG	FOOTING
BIT	BITUMINOUS	EA	EACH	GA	GAUGE
BLDG	BUILDING	ELEC	ELECTRICAL	GALV	GALVANIZED
BLW	BELOW	ENGR	ENGINEER	GC	GENERAL CONTRACTOR
BOC	BOTTOM OF CURB	EWC	ELECTRIC WATER COOLER	Gl	GALVANIZED IRON
BOT	BOTTOM	EWH	ELECTRIC WATER HEATER	GL	GLASS
BSMT	BASEMENT	EL	ELEVATION	GYP	GYPSUM
CAB	CABINET	ELAS	ELASTOMERIC	GWB	GYPSUM WALLBOARD
CB	CATCH BASIN	ELEV	ELEVATION	HB	HOSE BIBB
CEM	CEMENT	ELEV	ELEVATOR	HDWR	HARDWARE
CG	CORNER GUARD	EJ	EXPANSION JOINT	HDWD	HARDWOOD
CH	CEILING HEIGHT	EQ	EQUAL	HGT	HEIGHT
CI	CAST IRON	EQUIP	EQUIPMENT	HOL HORIZ	HOLLOW HORIZONTAL
CJ	CONSTRUCTION JOINT	EXIST	EXISTING	HORIZ HP	HIGH POINT
CL	CENTERLINE	(E)	EXISTING	HT	HARD TILE
CLG	CEILING	EXP	EXPANSION	HVAC	HEATING, VENTILATING,
CAULK	CAULKING	EXP	EXPOSED		AIR-CONDITIONING
CLOS	CLOSET	EXT	EXTERIOR	INSUL	INSULATION
CLR	CLEAR	(F)	FUTURE	INV EL	INVERT ELEVATION
CMU	CONCRETE MASONRY UNIT	FA	FIRE ALARM	JAN	JANITOR
CO	CLEAN OUT	FAC	FACILITY	JT	JOINT
COL	COLUMN	FCU	FAN COIL UNIT	KIT	KITCHEN

LAV LAVATORY PL PLASTIC LAMINATE SF SOLIA	STRUCTURAL SQUARE FEET SURFACE
LS LAUNDRY SINK LVR LOUVER  HACH MACH MACH MACHINE MANUF MANUFACTURER PULMB PLUMBING MAT'L MATERIAL PRESS PRESSURE MET METAL METAL METAL METAL MECH MECHANICAL MED MEDICINE/ MEDICAL MEMB MEMBRANE MEZZ MEZZANINE MEXZ MEZZANINE MEXZ MEXZANINE MEXZ MEXZANINE MEXAD MASONRY OPENING MR MIRROR	SUSPENDED TREAD TONGUE AND GROOVE TONGUE AND GROOVE TONGUE AND GROOVE TO BE DETERMINED TELEPHONE THICK, THICKNESS THROUGH TOP OF CURB TOP OF WALL TOILET PAPER DISPENSER TYPICAL JUNIFORM BUILDING CODE JRINAL JTILITY VINYL BASE VERTICAL VESTIBULE VERIFY IN FIELD VENT THROUGH ROOF VINYL TILE WASHER/WASTE/WIDE MITH MITHOUT WATER CLOSET WALL COVERING WINDOW WOOD WALL OPENING VORKING POINT VASTE RECEPTACLE VELDED WIRE FABRIC

### GENERAL NOTES

#### A GENERAL REQUIREMENTS

THE DRAWINGS ARE BASED ON THE FOLLOWING DOCUMENTS PROVIDED BY THE OWNER:

a) PROPERTY MAP ( SEE GENERAL NOTES FOR SITEWORK)

- ALL IDEAS, DESIGNS, ARRANGEMENTS AND PLANS INDICATED OR REPRESENTED BY THESE DRAWINGS
  ARE OWNED BY, AND THE PROPERTY OF THE ARCHITECT AND WERE CREATED, EVOLVED AND
  DEVELOPED FOR USE ON, AND IN CONNECTION WITH, THE SPECIFIED PROJECT ONLY. NONE OF SUCH IDEAS,
  DESIGNS ARRANGEMENTS OR PLANS SHALL BE USED BY OR DISCLOSED TO ANY PERSON, FIRM
  OR CORPORATION FOR ANY PURPOSE WHATSOEVER WITHOUT THE WRITTEN PERMISSION OF THE ARCHITECT
  ANY USE OF REPRODUCTION OF THESE DOCUMENTS EITHER IN PART OR IN WHOLE, WITHOUT THE
  WRITTEN PERMISSION OF THE ARCHITECT IS PROHIBITED.
- 3. COMPLY WITH THE MOST STRINGENT REQUIREMENT OF THE CONTRACT DOCUMENTS AND ALL LATEST AND APPLICABLE LOCAL AND FEDERAL CODES HAVING JURISDICTION, INCLUDING BUT NOT LIMITED TO THE
  - a) INTERNATIONAL RESIDENTAL CODE (2009 OR LATEST EDITION HAVING JURISDICTION)b) INTERNATION EXIST BLDG CODE (2009 OR LATEST EDITION HAVING JURISDICTION)
  - c) GOVERNMENT OF GUAM CODE, TITLE XVIII ZONING LAW
    d) INTERNATIONAL FIRE CODE (LATEST EDITION HAVING JURISDICTION)
  - d) INTERNATIONAL FIRE CODE (LATEST EDITION HAVING
     e) OTHER AUTHORITIES HAVING JURISDICTION :
  - NATIONAL PARK SERVICE: NATIONAL REGISTER OF HISTORIC PLACES
    NATIONAL PARK SERVICE: STANDARDS FOR RECONSTRUCTION
- DEPT OF PARK/RECREATION: STATE HISTORIC PRESERVATION OFFICER (SHPO)

  IF ANY CONFLICT AND/OR IRREGULARITIES ARE FOUND, THE ARCHITECT SHALL BE NOTIFIED

  IMMEDIATELY BEFORE PROCEEDING WITH THE PARTICULAR WORK INVOLVED.
- 4. THE WORK AS SHOWN IN THE DRAWINGS ARE FOR THE INTENT OF SPECIFYING THE DESIGN INTENT AND AESTHETIC APPEARANCE ONLY. THE DESIGN AND AESTHETIC APPEARANCE SHALL GOVERN EXCEPT WHEN EXCEEDED BY THE MOST STRINGENT REQUIREMENTS OF THE CONTRACT DOCUMENTS, GOVERNING LAWS AND REQUIREMENTS OF APPLICABLE GOVERNING AGENCIES. THE CONTRACTOR SHALL BE SOLELY RESPONSIBLE FOR AND HAVE CONTROL OVER ALL CONSTRUCTION MEANS, METHODS, TECHNIQUES, SEQUENCES AND PROCEDURES AND FOR COORDINATING ALL PORTIONS OF THE WORK TO MEET THE MOST STRINGENT REQUIREMENTS OF THE CONTRACT DOCUMENTS.
- 5. VERIFY ALL EXISTING CONDITIONS AND DIMENSIONS BEFORE COMMENCING WITH THE WORK. IF ANY CONFLICTS AND/OR IRREGULARITIES ARE FOUND, THE ARCHITECT SHALL BE NOTIFIED IMMEDIATELY BEFORE PROCEEDING WITH THE PARTICULAR WORK INVOLVED. IF ANY CONFLICTS AND/OR IRREGULARITIES ARE FOUND, THE CONTRACTOR SHALL RESOLVE THE CONFLICT WITH A SOLUTION THAT DOES NOT COMPROMISE THE DESIGN INTENT AND AESTHETIC APPEARANCE PER THE ARCHITECT'S APPROVAL, AND WITHOUT ANY MODIFICATION TO THE CONTRACT.
- 6. COORDINATE ALL ARCHITECTURAL, CIVIL, STRUCTURAL, MECHANICAL, PLUMBING, ELECTRICAL AND OTHER CONSULTANT'S DRAWINGS BEFORE COMMENCING WITH THE WORK. IF ANY CONFLICTS AND/OR IRREGULARITIES ARE FOUND, THE CONTRACTOR SHALL RESOLVE THE CONFLICT WITH A SOLUTION THAT DOES NOT COMPROMISE THE DESIGN INTENT AND AESTHETIC APPEARANCE PER THE ARCHITECT'S APPROVAL, AND WITHOUT ANY MODIFICATION TO THE CONTRACT.
- SUBJECT TO COMPLIANCE WITH OTHER REQUIREMENTS, ALL DIMENSIONS SHOWN IN THE DRAWINGS ARE FOR THE PURPOSES OF CONVEYING DESIGN INTENT AND FOR AESTHETIC APPEARANCE OF THE PROJECT ONLY. THE CONTRACTOR SHALL COORDINATE THESE DIMENSIONS WITH FIELD CONDITIONS, METHODS AND TECHNIQUES OF CONSTRUCTION, EXACT SIZES OF MATERIALS, EQUIPMENT AND TOOLS, REQUIREMENTS OF PERFORMANCE CRITERIAS, AND OTHER REQUIREMENTS SO AS TO AVOID CONFLICTS. IF ANY CONFLICTS OR IRREGULARITIES ARE FOUND, THE CONTRACTOR SHALL RESOLVE THE CONFLICT WITH A SOLUTION THAT DOES NOT COMPROMISE THE DESIGN INTENT AND AESTHETIC APPEARANCE PER THE ARCHITECT'S APPROVAL, AND WITHOUT ANY MODIFICATION TO THE CONTRACT.
- DIMENSIONS FOR MASONRY, WOOD AND GYPSUM DRYWALL SHOWN ON THE DRAWINGS ARE NOMINAL DIMENSIONS FOR THE PURPOSES OF AESTHETIC APPEARANCE ONLY. VERIFY ALL ACTUAL DIMENSIONS BEFORE COMMENCING WITH THE WORK. IF ANY CONFLICTS AND/OR IRREGULARITIES ARE FOUND, NOTIFY THE ARCHITECT IMMEDIATELY BEFORE PROCEEDING WITH THE PARTICULAR WORK INVOLVED.
- DO NOT SCALE DRAWINGS. APPLICABLE BLDG CODE REQUIREMENTS SHALL GOVERN OVER CALLED-OUT DIMENSIONS AND SCALED DRAWINGS.
- 9. TYPICAL NOTES AND TYPICAL DETAILS SHOWN SHALL APPLY THROUGHOUT THE DRAWINGS FOR SIMILAR CONDITIONS UNLESS NOTED OTHERWISE. MODIFY TYPICAL DETAILS AND SUPPLY MATERIAL AND LABOR AS REQUIRED TO MEET UNIQUE AND/OR FIELD CONDITIONS OF THE WORK.
- 10. PATCH ALL EXPOSED AREAS THAT RESULT DIRECTLY FROM DEMOLITION WORK. THESE AREAS SHALL BE FINISHED TO MATCH ADJACENT FINISHES.
- PROVIDE ARCHITECTURAL, MECH, PLUMB, AND ELEC ROUGH-INS AND STUB-OUTS WHERE NECESSARY, AND OVERALL COORDINATION FOR CONSTRUCTION

	HEDULES FOR THE FOLLOWING W	
ITEM	DESCRIPTION	ACTION BY:
1.	AIR-CONDITIONING SYSTEM	SEE ADDITIVE ALTERNATES
2.	APPLIANCES: WASHER/DRYER	BY OWNER (OWNER TO COMPLY W/ PHYSICAL CONSTRAINTS NOTED)
	REFRIGERATOR	
	SLIDE-IN RANGE	•

PROVIDE ARCHITECTURAL, MECH, PLUMB AND ELEC ROUGH-INS AND STUB-OUTS WHERE NECESSARY, AND OVERALL COORDINATION FOR CONSTRUCTION SCHEDULE, AND ASSEMBLE AND INSTALL THE FOLLOWING "OWNER-FURNISH CONTRACTOR-INSTALL (OFCI)" ITEMS: "OFCI" WORK

ITEM	DESCRIPTION	FURNISHED FROM:				
1.	SALVAGED/REFURBISHED ITEMS TO BE REINSTALLED	SEE DEMOLIITON PLAN				

WHEN REQUESTED, THE CONTRACTOR SHALL ASSIST IN PROVIDING QUANTITY TAKE—OFFS OF "OFCI" MATERIALS OR TO VERIFY QUANTITIES PROVIDED BY THE OWNER. THE CONTRACTOR SHALL ACCOUNT FOR BREAKAGE AND WASTAGE AS WELL AS WORKMANSHIP OF THE WORKERS.

VERIFY/COORDINATE TYPE AND QUANTITIES OF "OFCI" ITEMS TO BE FURNISHED. ALL OTHER ITEMS AND/OR ACCESSORIES (E.G. GLUES, ADHESIVE, FASTENERS, MORTAR, GROUT, ETC. WHICH IS NOT PART OF THE "OFCI" PACKAGE BUT NECESSARY FOR THE COMPLETE INSTALLATION OF THE "OFCI" ITEMS SHALL BE PROVIDED BY THE CONTRACTOR. WHERE THE "OFCI" ITEMS DO NOT FIT, THE CONTRACTOR SHALL MODIFY THE "OFCI" ITEMS TO FIT. WHERE THE "OFCI" ITEMS IS DELIVERED AS A KIT OF "PARTS", THE CONTRACTOR SHALL ASSEMBLE THE PARTS ACCORDING TO THE MANUF'S INSTRUCTIONS. "OFCI" ITEMS SHALL BE DELIVERED TO THE JOBSITE IN CONTAINERS OR AS ARRANGED BY THE OWNER THE CONTRACTOR SHALL UNLOAD THE "OFCI" ITEMS AT THE JOBSITE AS PART OF THE WORK.

- 13. UPON RECEIPT OF OFCI ITEMS, CHECK IMMEDIATELY FOR DEFECTS AND DAMAGE. WHEN DEFECTS ARE FOUND, DOCUMENT THE DAMAGE BY TAKING PHOTOGRAPHS WITH AUTOMATIC TIME/DATE STAMP, AND NOTIFY THE ARCHITECT. IF NO DAMAGE AND/OR DEFECTS ARE FOUND, A WRITTEN RECEIPT INDICATING THE GOOD CONDITION OF THE ITEMS SHALL BE ISSUED TO THE DELIVERY PERSON WITH A COPY TO THE ARCHITECT. IF NOTIFICATION OF DAMAGED AND/OR DEFECTIVE GOODS ARE NOT RECEIVED BY THE ARCHITECT AFTER 1 WORKING DAY UPON THE CONTRACTOR'S RECEIPT OF THE ITEMS, THE ITEMS SHALL BE CONSIDERED DELIVERED TO THE CONTRACTOR IN GOOD CONDITION. THE CONTRACTOR BECOMES RESPONSIBLE FOR THE CONDITION AND PROTECTION OF THE ITEM.
- 14. ONE SET OF REPRODUCIBLE SHALL BE LOANED TO THE CONTRACTOR FOR USE OF COPYING FOR BUILDING PERMIT AND CONSTRUCTION. ALL ADDITIONAL COPIES OF THE DRAWINGS, INCLUDING THE BLUEPRINTS, AS-BUILT DOCUMENTATION, ETC. SHALL BE PROVIDED AT THE CONTRACTOR'S EXPENSE.
- 15. SUBMIT A CONSTRUCTION SCHEDULE BEFORE THE SCHEDULED SUBMITTAL OF INITIAL APPLICATION FOR PAYMENT. THE CONSTRUCTION SCHEDULE SHALL INCLUDE THE FOLLOWING:

  A) THE DATE OF SUBSTANTIAL COMPLETION NO LATER THAN THE NUMBER OF DAYS INDICATED ON
  - PROCEED.THE SCHEDULE SHALL SHOW THE CRITICAL PATH IN A HIGHLIGHTED MANNER.

    B) THE SCHEDULE OF WORK TO BE PERFORMED BY VARIOUS TRADES.

CONTRACTOR'S BID FORMS FROM THE DATE OF COMMENCEMENT STIPULATED IN THE NOTICE TO

- C) OFCI ITEMS AND WORK BY "OTHERS" INCLUDE DELIVERY DATES FOR THESE ITEMS FOR HANDOVER TO THE CONTRACTOR.
- AS SCHEDULED, THE CONTRACTOR SHALL BE RESPONSIBLE FOR ALL ADDITIONAL COSTS TO DELIVER THESE ITEMS ON ISLAND AND FOR KEEPING THE PROJECT ON SCHEDULE WITHOUT ANY EXTENSION.

  E) ANY REQUEST FOR TIME EXTENSION SHALL BE FILED WITHIN 21 CALENDAR DAYS OF THE COMMENCEMENT OF THE SPECIFIC TASK. OTHERWISE, THE CONTRACTOR SHALL WAIVER HIS RIGHT FOR A TIME EXTENSION FOR THAT SPECIFIC TASK. ANY REQUEST FOR TIME EXTENSION SHALL ONLY BE CONSIDERED IF THE

CONTRACTOR SHOWS THAT THE TASK INVOLVED IS ON THE CRITICAL PATH SCHEDULE OF THE PROJECT, AND

D) THE DELIVERY SCHEDULE FOR ALL OFF-ISLAND ITEMS. IF THE ITEMS WOULD NOT ARRIVE ON ISLAND

- THAT THE TIME EXTENSION IS NOT THE BASIS FOR ANY CHANGES TO THE CONTRACT SUM.

  16. SUBMIT THE SCHEDULE OF VALUES (PER UNIT CONSTRUCTION COST) AND A COPY OF THE CERTIFICATE OF RELEVANT INSURANCE POLICIES TO THE ARCHITECT BEFORE THE DATE SCHEDULED FOR SUBMITTAL OF THE INITIAL APPLICATION FOR PAYMENT. PAYMENT APPLICATION FORM AIA DOCUMENT G702 AND CONTINUATION SHEETS G703 SHALL BE USED WITH EACH APPLICATION AS DIRECTED BY THE ARCHITECT. THE CONTRACTOR SHALL SUBMIT WAIVERS OF LIEN FROM EVERY ENTITY WHO MAY FILE A LIEN RELATED TO THE WORK COVERED BY THE PAYMENT AND CONTRACT AS PART OF THE APPLICATION FOR PAYMENT.
- 17. SUBSTITUTION: SUBMIT ALL REQUEST FOR SUBSTITUTION TO THE ARCHITECT FOR APPROVAL WITHIN 30 DAYS AFTER THE CONTRACT AWARD. CERTIFY THAT PROPOSED SUBSTITUTION IS EQUAL—TO—OR—BETTER IN EVERY ASPECT TO THAT REQUIRED BY THE CONTRACT DOCUMENTS, AND THAT IT WILL PERFORM SUCCESSFULLY IN THE APPLICATION INDICATED. THE CONTRACTOR SHALL ALSO WAIVER HIS RIGHTS TO CLAIMS FOR ADDITIONAL PAYMENT OR TIME WHEN THE PROPOSED SUBSTITUTION FAILS TO PERFORM AND HAVE TO BE REPLACED.
- 8. ALLOW THREE WEEKS FOR INITIAL REVIEW OF SUBMITTALS AND TWO WEEKS FOR REPROCESSING EACH SUBMITTAL. IF EACH SUBMITTAL IS DELAYED FOR COORDINATION WITH OTHER SUBMITTALS. THE ARCHITECT RESERVE THE RIGHT TO WITHHOLD ACTION ON A SUBMITTAL REQUIRING COORDINATION UNTIL RELATED SUBMITTALS ARE RECEIVED.

  ALLOW TWO WEEKS FOR INITIAL REVIEW OF THE CONTRACTOR'S REQUEST FOR CLARIFICATION. THE ARCHITECT RESERVES THE RIGHT TO WITHHOLD ACTION ON A CLARIFICATION REQUEST REQUIRING COORDINATION UNTIL RELATED COORDINATION ITEMS ARE RECEIVED.
- 9. ALL CLAIMS FOR CHANGE ORDERS SHALL BE FILED WITHIN 14 CALENDAR DAYS AFTER THE INITIAL OCCURRENCE OF THE EVENT GIVING RISE TO SUCH A CLAIM. ALL ADDITIONAL CLAIMS ARISING FROM THE SAME EVENT AFTER THE INITIAL CLAIM HAS BEEN FILED SHALL NOT BE CONSIDERED UNLESS FILED TOGETHER WITH THE INITIAL CLAIM.

  WORK CARRIED OUT WITHOUT ANY FORMAL AND WRITTEN EXECUTION OF CHANGE ORDER WILL INDICATE THE CONTRACTOR'S ACKNOWLEDGMENT THAT THERE WILL BE NO CHANGE IN THE CONTRACT SUM AND/OR CONTRACT TIME.
- 20. BEFORE REQUESTING INSPECTION FOR CERTIFICATES FOR SUBSTANTIAL COMPLETION, THE CONTRACTOR SHALL COMPLETE THE FOLLOWING:
- A) IN THE APPLICATION FOR PAYMENT THAT COINCIDES WITH THE DATE SUBSTANTIAL COMPLETION IS CLAIMED, SHOW 100 PERCENT COMPLETION FOR THE PORTION OF THE WORK CLAIMED SUBSTANTIALLY COMPLETE.

   B) SUBMIT SPECIFIC WARRANTIES, MAINTENANCE, FINAL CERTIFICATES, AS—BUILT DRAWINGS AND SIMILAR DOCUMENTS.

   CONTRACTOR OF THE PROJECT PROJECT PROJECT OF STATEMENT CHOICE.
- C) SUBMIT MAINTENANCE MANUALS, FINAL PROJECT PHOTOGRAPHS, DAMAGE OR SETTLEMENT SURVEY, AND SIMILAR RECORD INFORMATION.
- D) CHANGE-OVER PERMANENT LOCKS AND SUBMIT KEYS TO THE OWNER.
- E) COMPLETE START-UP TESTING OF ALL SYSTEMS, COMPLETE AIR-BALANCING OF AIR CONDITIONING SYSTEM AND PROVIDE OPERATING AND MAINTENANCE INSTRUCTIONS TO OWNER'S PERSONNEL.F) REMOVE TEMPORARY FACILITIES FROM THE SITE, ALONG WITH CONSTRUCTION TOOLS, MOCKUPS, AND SIMILAR ELEMENTS.
- G) COMPLETE FINAL CLEAN UP TO ACHIEVE A "BROOM AND MOP CLEAN" BUILDING. TOUCH-UP AND REPAIR
  AND RESTORE MARRED EXPOSED FINISHES.
   H) PREPARE ARCH., MECH., AND ELEC. RECORD DRAWINGS SHOWING "AS-BUILT" CONDITIONS AND SURRENDER
- H) PREPARE ARCH., MECH., AND ELEC. RECORD DRAWINGS SHOWING "AS-BUILT" CONDITIONS AND SURRENDER THE REPRODUCIBLE ORIGINALS TO THE ARCHITECT.
   I) SURRENDER ALL EXCESS MATERIALS THAT ARE NOT USED DURING THE CONSTRUCTION AND/OR INSTALLATION
- TO THE OWNER.

  J) OBTAIN ALL PERMITS INCLUDING OCCUPANCY PERMIT.

  K) PROVIDE CONTRACTOR'S PUNCH LIST OF INCOMPLETE WORK EXCEPTIONS TO ARCHITECT'S CERTIFICATE OF SUBSTANTIAL COMPLETION.
- L) OBTAIN AND PUBLISH (IN PDN NEWSPAPER) CERTIFICATE OF COMPLETION FROM GOVERNING AUTHORITIES, AND TO COOPERATE WITH THE OWNER TO CLEAR ALL POTENTIAL LIENS.
- 21. TEMPORARY FACILITIES: PROVIDE TEMPORARY CONSTRUCTION WALLS AND DOORS TO CONCEAL CONSTRUCTION ACTIVITIES FROM THE PUBLIC AND STAFF AS DIRECTED BY THE OWNER FOR EACH PHASE OF THE WORK. TEMPORARY FACILITIES SUCH AS PAINTED PLYWOOD WALLS, ETC. SHALL BE PROVIDED TO THE OWNER AS DIRECTED BY THE OWNER FOR TEMPORARY USAGE.

  COORD SCHEDULE OF DAILY WORK W/ OWNER TO MITIGATE SOUND POLLUTION TO THE NEIGHBORS BEFORE 8.00 AM AND AFTER 5.00 PM. WHEN DIRECTED, SCHEDULE ALL DISRUPTIVE WORK TO OCCUR DURING HOURS ACCEPTABLE TO THE OWNER AND NEIGHBORS.
- THE REVIEW OF SUBMITTALS IS FOR CONFORMANCE WITH DESIGN INTENT AND AESTHETIC APPEARANCE ONLY.
  THE CONTRACTOR SHALL BE RESPONSIBLE FOR THE VERIFICATION AND COORDINATION OF ALL DIMENSIONS FOR
  THE PROJECT, FOR INFORMATION THAT PERTAIN TO THE FABRICATION PROCESS AND/OR TO THE TECHNIQUES OF
  CONSTRUCTION, FOR COORDINATION OF THE WORK WITH ALL TRADES, AND FOR COMPLIANCE WITH OTHER
  REQUIREMENTS OF THE CONTRACT. THE REVIEW DOES NOT RELIEVE THE CONTRACTOR IN ANY WAY FROM THESE
  RESPONSIBILITIES.
- THE REVIEW OF SUBMITTALS DOES NOT RELIEVE THE CONTRACTOR OF ANY RESPONSIBILITIES FOR ANY DEVIATION FROM THE CONTRACT UNLESS THE CONTRACTOR HAS NOTIFIED THE ARCHITECT IN WRITING OF SUCH A DEVIATION AT THE TIME OF THE SUBMITTAL SUBMISSION AND HAVE RECEIVED A WRITTEN APPROVAL FOR THE SPECIFIC DEVIATION.

  THE REVIEW OF SUBMITTALS DOES NOT RELIEVE THE CONTRACTOR OF ANY RESPONSIBILITIES FOR ANY ERRORS AND OMISSIONS IN THE SUBMITTALS TO ENSURE A COMPLETE DELIVERY OF MATERIALS AND THE COMPLETE
- AS-BUILT DRAWINGS: KEEP A CLEAN COPY OF THE CONTRACT DOCUMENTS AT THE JOB SITE AND MARK ALLOCATIONS OF HIDDEN UTILITIES. MARK ALL ITEMS AND DIMENSIONS WHICH DIFFER FROM THE CONTRACT DOCUMENTS FOR A PERMANENT RECORD. DELIVER THIS MARKED UP SET TO THE ARCHITECT AT THE END OF CONSTRUCTION. THE ARCHITECT SHALL THEN VERIFY THAT ALL REQUIRED INFORMATION IS SHOWN. MAKE ANY CHANGES OR ADDITIONS AS DIRECTED. THE FINAL APPROVED SET SHALL THEN BE TURNED OVER TO THE OWNER BY THE ARCHITECT FOR THE OWNER'S RECORDS.
- 24. WARRANTIES: BIND ALL WARRANTIES INTO ONE 3-RING BINDER WITH POCKETS IN FRONT AND BACK COVER FOR LOOSE CARDS WHICH MUST BE FILLED OUT AND RETURNED TO MANUFACTURER BY THE OWNER. AT HIS OPTION, THE CONTRACTOR MAY PLACE THESE CARDS WITH 3-HOLE CLEAR PLASTIC FOLDERS INSERTED INTO BINDER. THIS BINDER SHALL INCLUDE CLEANING INSTRUCTIONS FOR ALL INSTALLED ITEMS AND SHALL ALSO HAVE A SEPARATE SHEET IN THE FRONT WHICH LISTS THE ADDRESS AND PHONE NUMBERS OF ALL SUBCONTRACTORS AND SUPPLIERS WHO MAY NEED TO BE CONTACTED FOR WARRANTY SERVICE.
  - THE CONTRACTOR AND THEIR SUBCONTRACTORS SHALL STATE IN WRITTEN AND SEPARATE WARRANTIES THAT THE ENTIRE PROJECT IS WARRANTED BY THE CONTRACTOR AND THE SUBCONTRACTOR TO BE FREE OF DEFECTS FOR THE LONGER PERIOD OF EITHER 365 CALENDAR DAYS FROM THE DATE OF SUBSTANTIAL COMPLETION OR THE PERIOD AS INDICATED IN THE SUPPLIER'S STANDARD WARRANTY FOR THE SPECIFIC PRODUCT. ANY REPAIR OR REPLACEMENT WORK SHALL AUTOMATICALLY REINSTATE THE WARRANTY PERIOD COVERING THE FOR AN ADDITIONAL PERIOD OF NOT LESS THAN THE INITIAL WARRANTY PERIOD.

THE WARRANTY SHALL FURTHER STATE THAT ALL LABOR AND WORKMANSHIP SHALL BE WARRANTED FOR A PERIOD OF 2 YEARS AFTER SUBSTANTIAL COMPLETION. ANY REPAIR MADE UNDER THE WORKMANSHIP WARRANTY SHALL AUTOMATICALLY REINSTATE THE PERIOD COVERING THAT WORK FOR AN ADDITIONAL 2 YEARS.

THE WARRANTY DOES NOT RELIEVE THE CONTRACTOR OF HIS OBLIGATION TO COMPLETE THE WORK IN FULL COMPLIANCE WITH THE CONTRACT.

#### . QUALITY ASSURANCE

- THE CONTRACTOR, AND/OR THE SUBCONTRACTOR SHALL HAVE NOT LESS THAN THREE YEARS OF SUCCESSFUL EXPERIENCE IN THE INSTALLATION OF THE WORK SIMILAR TO THE WORK SPECIFIED. THE CONTRACTOR AND/OR THE SUBCONTRACTOR SHALL BE ACCEPTABLE TO THE PRIMARY SOURCE MANUFACTURER OF THE WORK. WHERE REQUIRED BY THE MANUFACTURER AND/OR ARCHITECT, THE CONTRACTOR, SUBCONTRACTOR AND/OR APPLICATOR SHALL BECOME CERTIFIED OR LICENSED BY MANUFACTURER.
- INSPECTIONS: ARRANGE WITH THE MANUFACTURER TO INSPECT THE WORK FOR COMPLIANCE WITH MANUFACTURER'S RECOMMENDATIONS AS REQUIRED BY THE MANUFACTURER. IN ADDITION, COMPLY W/ APPLICABLE GOVERNING AUTHORITIES (GOV GUAM, ETC.) TO INSPECT THE WORK AT EACH STAGE OF THE WORK.
- 3. SUBMIT A LIST OF SUBCONTRACTORS, SURETY COMPANY AND SPECIALTY SUPPLIER FOR THE SPECIFIED WORK SHOWN. THE CONTRACTOR SHALL ALSO SUBMIT LETTER OF INTENT FROM EACH OF THEIR SUBCONTRACTOR THAT THEY WILL BE DIRECTLY INVOLVED IN THE INSTALLATION OF THE WORK.
- 4. PERMITS: THE CONTRACTOR SHALL OBTAIN BUILDING PERMIT AND PROVIDE REQUIRED FEES, DOCUMENTATIONS
  AND PROCESSING FEES TO OBTAIN OTHER REQUIRED GOVERNMENT PERMITS OR CERTIFICATIONS (INCLUDING BUT NOT
  LIMITED TO BUILDING PERMIT, CERTIFICATE OF OCCUPANCY, FIRE SPRINKLER/FIRE ALARM CERTIFICATION (IF ANY),
  HIGHWAY ENROACHMENT PERMIT, UTILITY HOOKUP, GPA TRANSFORMER FEE/ TRFX HOOKUP FEE (IF ANY), ENVIRONMENTAL
  IMPACT STATEMENT/ EROSION CONTROL PLAN (IF ANY), DPR HISTORIC REVIEW BOARD, TIPPING FEES FOR DISPOSAL
  OF WASTE/DEBRIS, CERTIFICATE OF COMPLETION, ETC) AT CONTRACTOR'S EXPENSE. ARRANGE WITH AUTHORITIES
  HAVING JURISDICTION TO INSPECT THE WORK FOR COMPLIANCE WITH GOVERNING REGULATIONS AND OTHER REQUIREMENTS.

- WORKMANSHIP: WORKMANSHIP SHALL BE FIRST CLASS AND SHALL MATCH THE BEST QUALITY OF PREVIOUSLY BUILT WORK BY THE CONTRACTOR IN ALL ASPECTS. THE WORK SHALL BE PLUMB, TRUE, EVEN, UNIFORM AND FREE OF DEFECTS. UNLESS NOTED OTHERWISE, ALL JOINTS SHALL BE MINIMIZED TO THE MAXIMUM EXTENT POSSIBLE. TOLERANCES OF JOINTS AND LINES FOR FINISHING WORK SHALL BE NO GREATER THAN 1/4" IN 10'-0". TIGHTNESS OF ALL FINISH JOINTS, CORNERS AND CONNECTIONS SHALL BE ACHIEVED SUCH AS NOT TO PERMIT THE PASSAGE OF LIQUID IN ENSURING A WEATHERPROOF BUILDING ENCLOSURE. THE BUILDING EXTERIOR ENCLOSURE SYSTEM SHALL BE WEATHERPROOFED AND NOT PERMIT PASSAGE OF RAIN, AND WINDS UNDER ORDINARY CIRCUMSTANCES (WHEN DOORS/WINDOWS ARE CLOSED) EXCEPT DURING TYPHOONS, TORNADOES, TSUNAMIS, FIRES AND OTHER NATURAL CALAMITIES.
- 6. COMPLY WITH THE REQUIREMENTS OF THE INTERNATIONAL RESIDENTIAL CODE (ICC), AMERICAN SOCIETY FOR TESTING MATERIALS, UNDERWRITER'S LABORATORIES INC., ETC, FOR THE SPECIFIC ASSEMBLY FOR ALL FIRE-RATED ASSEMBLIES AND OTHER PERFORMANCES INDICATED IN THE DRAWINGS AND ELSEWHERE IN THE CONTRACT DOCUMENTS.
- TESTING: SUBJECT TO COMPLIANCE WITH OTHER REQUIRMENTS, PERFORM TESTING TO INCLUDE BUT NOT
- LIMITED TO THE FOLLOWING: a. CONCRETE MIX: SLUMP TEST
  b. CONCRETE/ GROUT MIX: COMPRESSIVE OR CYLINDER TEST
  c. STATIC PRESSURE/ LEAK DETECTION TEST COLD/HOT WATER
  d. 10 FOOT GRAVITY LEAK DETECTION TEST SEWER
  - e. CIRCUIT TESTING ELECTRICAL SYSTEMS

    f. BACTERIOLOGICAL AND LEAD ANALYTICAL TEST— ALL PORTABLE PIPING SYSTEM
    g. AS REQUIRED BY GOVERNING AUTHORITIES
    h. AS NOTED IN THE DWGS /SPECIFICATIONS

BASED ON THE TEST REPORTS, IF THE WORK DO NOT MEET THE MOST STRINGENT REQUIREMENTS OF THE DOCUMENTS, THE CONTRACTOR SHALL PERFORM REMEDIAL WORK UNTIL THE DESIRED RESULTS ARE OBTAINED.

#### WHERE SPECIALTY WORK IS INVOLVED, A ONE SOURCE SUPPLIER AND/OR MANUFACTURER IS REQUIRED TO ENSURE THE PROPER COORDINATION AND FITTING OF THE PARTS.

AND TURNOVER TO THE OWNER SHALL BE NEW AND FREE OF ANY DEFECTS.

#### 1. UNLESS NOTED OTHERWISE, ALL MATERIALS TO BE PERMANENTLY INCORPORATED INTO THE PROJECT

- ALL AND/OR ANY MATERIALS SHALL CONTAIN NO MORE THAN THE MINIMUM LEVELS OF LEAD, ASBESTOS, MERCURY AND OTHER HAZARDOUS MATERIALS PERMISSIBLE BY THE AUTHORITIES HAVING JURISDICTION. DISPOSE ALL AND/OR ANY MATERIALS CONTAINING MORE THAN PERMISSIBLE LEVELS IN COMPLIANCE
- WITH AUTHORITIES HAVING JURISDICTION.

  3. ALL WOOD/PLYWOOD MATERIALS TO BE INCORPORATED INTO THE PROJECT SHALL BE PRESSURE—TREATED W/ TERMITE RETARDANT PRESERVATIVES UNLESS LOCATED IN A VISIBLE OR EXPOSED LOCATION REQUIRING A "FINISHED" APPEARANCE. IN THESE VISIBLE OR EXPOSED LOCATIONS, PROVIDE A CLEAR TERMITE TREATMENT (BOTH SHOP AND FIELD APPLIED) SIMILAR TO "TIMBOR". EXCEPTIONS ARE THE FOLLOWING
- 4. ALL MATERIALS TO BE INCORPORATED INTO THE PROJECT, INCLUDING WOOD, PLYWOOD, SISAL, WALL COVERINGS, OTHER FINISH MATERIALS, ETC. SHALL COMPLY WITH THE FIRE—RESISTIVE/FLAME SPREAD REQUIREMENTS OF

### THE CONSTRUCTION TYPE PER THE UBC. ALL FIRE-RATED MATERIALS SHALL BE MARKED WITH UL OR SIM LABELS. D. DELIVERY AND STORAGE

WOOD SPECIÈS: IFIT/MERBAU (INTSIA BEJUGA), IPE, REDWOOD ALL HEARTS.

- MATERIALS SHALL BE DELIVERED TO THE SITE IN GOOD CONDITION AND IN ORIGINAL SEALED CONTAINERS THAT PLAINLY SHOW THE DESIGNATE NAME, MODEL NUMBERS, DATE OF MANUFACTURE, MANUFACTURER'S DIRECTION, AND NAME OF MANUFACTURER. THEY SHALL BE STORED OFF THE GROUND TO PROVIDE PROPER VENTILATION, DRAINAGE AND PROTECTION. THEY SHALL BE STORED UNDER COVER IN WEATHERPROOF ENCLOSURES AND SHALL BE PROTECTED AGAINST RAIN, EXTREME CHANGES IN TEMPERATURE AND HUMIDITY, DAMAGE, DAMPNESS AND VANDALISM. THEY SHALL NOT BE STORED IN A BUILDING UNDER CONSTRUCTION UNTIL CONCRETE, MASONRY WORK AND PLASTER ARE DRY. ALL AND/OR ANY PROTECTIVE ELEMENTS SUCH AS KRAFT PAPER, ETC., THAT CAN STAIN, DISCOLOR AND/OR CAUSE "RAINBOWING" IN THE MATERIALS SHOULD BE REMOVED AND REPLACED. ANY UNIT EITHER DEFECTIVE FROM THE FACTORY AND/OR DAMAGED DURING DELIVERY AND/OR STORAGE, SHALL BE REPLACED BY THE CONTRACTOR AT THE CONTRACTOR'S EXPENSE.
- 2. ALL INFLAMMABLE AND OTHER POTENTIALLY HAZARDOUS MATERIALS SHALL BE KEPT AWAY FROM FIRE, SPARKS, SMOKING AND OTHER HAZARDOUS SOURCES AND IN COMPLIANCE WITH AUTHORITIES HAVING JURISDICTION. ALL FLAMMABLE MATERIALS SHALL ALSO BE SEPARATED FROM THE REST OF THE NON-FLAMMABLE MATERIALS.
- 3. UNUSED MATERIALS: UNLESS NOTED OTHERWISE, DELIVER ALL UNUSED MATERIALS LEFTOVER FROM INSTALLATION TO THE OWNER FOR MAINTENANCE PURPOSES. IF THE UNUSED MATERIALS ARE NOT ACCEPTABLE TO THE OWNER, DISPOSE THEM IN A LAWFUL MANNER.
- 4. EXTRA STOCK: DELIVER NO LESS THAN 10% EXTRA STOCK WHICH INCLUDES UNUSED MATERIALS, TO THE OWNER FOR FUTURE REPAIRS AND MAINTENANCE. THE EXTRA STOCK SHALL MATCH THE INSTALLED MATERIALS AND SHALL BE IN APPROXIMATELY THE SAME PROPORTIONALS AS THE COLORS AND FINISHES OF THE INSTALLED MATERIALS. LABEL AND LIST THE NAMES, TYPES AND QUANTITIES OF THE EXTRA STOCK.

#### E INSTALLATION:

MATERIALS

- JOB CONDITION: COMPLY WITH THE MOST STRINGENT REQUIREMENTS OF MANUFACTURER'S INSTALLATION GUIDELINES, THE INDUSTRY'S STANDARD AND THE AUTHORITIES HAVING JURISDICTION FOR ENVIRONMENTAL CONDITIONS BEFORE, DURING AND AFTER INSTALLATION.
- 2. EXAMINATION: EXAMINE THE JOBSITE AS WELL AS ALL MATERIALS TO BE USED FOR COMPLIANCE WITH THE MOST STRINGENT REQUIREMENTS OF THIS CONTRACT DOCUMENT, MANUFACTURER'S RECOMMENDATIONS AND THE AUTHORITIES HAVING JURISDICTION. DO NOT PROCEED WITH THE INSTALLATION UNTIL UNSATISFACTORY CONDITIONS HAVE BEEN CORRECTED.
- 3. PREPARATION: COMPLY WITH THE MANUFACTURER'S INSTRUCTIONS FOR PREPARATION OF SURFACES AND SUBSTRATES. COORDINATE THE WORK PRIOR TO COMMENCEMENT. SURFACES SHALL BE PLUMB AND TRUE, CLEAN, EVEN, SMOOTH, DRY AND FREE FROM OILS AND OTHER DEFECTS AND PROJECTIONS WHICH MIGHT AFFECT THE APPLICATION. DO NOT PROCEED WITH THE INSTALLATION UNTIL UNSATISFACTORY CONDITIONS HAVE BEEN CORRECTED.
- 4. COORDINATE ALL MOUNTING HEIGHTS AND LOCATIONS OF DEVICES AND OTHER ELEMENTS PRIOR TO INSTALLTION. REFER ALL QUESTIONABLE MOUNTING HEIGHTS AND LOCATION TO THE ARCHITECT FOR FINAL DECISION. ANY AND/OR ALL DEVICES AND OTHER ELEMENTS WITH QUESTIONABLE MOUNTING HEIGHTS AND LOCATIONS SHALL BE RELOCATED WITHIN 10 FEET WITHOUT ANY ADDITIONAL COST. INSTALLATION: COMPLY WITH THE MOST STRINGENT REQUIREMENTS OF THE MAUNFACTURER'S
- INSTRUCTION FOR INSTALLTION, THE CONTRACT DOCUMENTS OR AUTHORITIES HAVING JURISDICTION.

  5. PROVIDE OTHER MATERIALS AND LABOR, NOT SPECIFIED BUT REQUIRED FOR THE COMPLETE
  AND PROPER INSTALLATION FOR THE GIVEN WORK, INCLUDING BUT NOT LIMITED TO OFCI ITEMS,
  PER MANUFACTURER'S RECOMMENDATIONS AND ARCHITECT'S APPROVAL AT THE CONTRACTOR'S EXPENSE.
  PROVIDE SHIMS, EXPANSION SHIELDS AND WOOD BLOCKING AS REQUIRED FOR PLUMB, LEVEL AND

COMPLETE INSTALLATION. PROVIDE GRINDING, LEVELING AND REFINISHING AND SANDING AS

#### F. PROTECTIONS.

- PROVIDE TEMPORARY PROTECTIVE BOARD, MEMBRANES AND/OR OTHER APPROPRIATE PROTECTIVE ELEMENTS TO ENSURE PROTECTION OF THE WORKS AND OTHER ADJACENT AREAS BEFORE, DURING AND AFTER DEMOLITION AND/OR NEW CONSTRUCTION WORK. ANY AND/OR ALL DAMAGE TO THE WORKS AND/OR OTHER ADJACENT AREAS DURING CONSTRUCTION FOR ANY REASONS, SHALL BE REPLACED BY THE CONTRACTOR.
- 2. PROTECT ALL MATERIALS INCLUDING BUT NOT LIMITED TO OFCI ITEMS, FROM DAMAGE, DAMPNESS, VANDALISM, THEFT, CONTAMINATIONS, NORMAL WEAR AND TEAR DURING STORAGE. ANY AND/OR ALL DAMAGE TO THE MATERIALS FOR ANY REASONS, SHALL BE REPLACED BY THE CONTRACTOR AT HIS EXPENSCE.
- 3. PROVIDE FIRE—FIGHTING APPARATUS AT THE SITE WITHIN EASY ACCESS TO ANY LOCATION ON THE SITE, INCLUDING BUT NOT LIMITED TO STAGING AREAS, WASTE CONTAINERS AND AREAS CONTAINING INFLAMMABLE MATERIALS. COMPLY WITH THE REQUIREMENTS OF AUTHORITIES HAVING JURISDICTION AND THE FIRE DEPARTMENT.
- 4. PROVIDE TEMPORARY PROTECTION, MEMBRANES AND/OR OTHER APPROPRIATE PROTECTIVE ELEMENTS TO MAINTAIN SATISFACTORY JOB CONDITIONS, TO PREVENT THE SURFACE RUNOFF OF THE FINES, AND/OR TO PROMOTE PROPER CURING. DO NOT PROCEED UNTIL THE WORK IS FULLY DRIED AND/OR CURED. ANY DAMAGE TO THE WORK AS A RESULT OF NOT PROTECTING THE WORK OR ALLOWING THE WORK TO CURE PROPERLY SHALL BE REPAIRED OR REPLACED BY THE CONTRACTOR AT HIS EXPENSE.
- 5. SECURE JOB SITE AS WELL AS REMOVE ALL LOOSE MATERIALS/ DEBRIS WHEN ANY TYPHOON CONDITION IS FORECASTED TO ARRIVE IN 24 HOURS.

  ANY DAMAGE TO SURROUNDING AREAS RESULTING FROM THE CONTRACTOR'S NEGLIGENCE AND/OR
- FAILURE TO SECURE THE JOB SITE AND REMOVE LOOSE MATERIALS/ DEBRIS SHALL BE REPAIRED AND/OR RESTORED TO ITS ORIGINAL CONDITION AT THE CONTRACTOR'S EXPENSE.

  6. REMOVE TEMPORARY PROTECTION INSTALLED FOR THE PROTECTION OF WORK PRIOR TO THE
- COMMENCEMENT OF FINAL CLEANING.

  G. C L E A N I N G
- 1. DISPOSAL OF WASTE MATERIALS: ON A DAILY BASIS, WASTE MATERIALS AND OTHER DEBRIS SHALL BE STORED IN CONTAINERS LOCATED AWAY FROM EXIST NEIGHBORS AND IN COMPLIANCE WITH AUTHORITIES HAVING JURISDICTION. DO NOT BURN OR BURY WASTE MATERIALS/DEBRIS ON OWNER'S PROPERTY. DO NOT DISCHARGE VOLATILE, HARMFUL, DANGEROUS MATERIALS AND WASTE OILS INTO THE DRAINAGE OR SEWER SYSTEM. WHEN CONTAINERS ARE FULL, DISPOSE OF WASTE AND DEBRIS IN A LAWFUL MANNER.
- UNACCEPTABLE BY OWNER, DISPOSE OR RECYCLE SURPLUS MATERIALS IN A LAWFUL MANNER.

  CLEANUP JOB SITE ON A DAILY BASIS AND DISPOSE SOLID WASTE MATERIALS AT AN ASSIGNED AREA FOR COLLECTION DURING ALL PHASE OF CONSTRUCTION. COORDINATE CLEANUP WITH


SURPLUS MATERIALS: SURRENDER USABLE SURPLUS MATERIALS TO OWNER. IF DEEM UNUSABLE AND/OR

- ALL TRADES AND SUBCONTRACTORS ON THE SITE.

  4. THE FINISHED AREAS SHALL BE CLEANED WITH AN APPROVED CLEANING SOLUTION BY THE MANUFACTURER FOR THE SURFACE TO BE CLEANED. PROTECT ALL SURFACES AND WORK OF OTHER
- TRADES FROM DAMAGE FROM THE EFFECTS OF THE CLEANING SOLUTION. FINISHED AREAS SHALL BE MAINTAINED CLEAN AND NEAT AT ALL TIMES.

  FINAL CLEANING SHALL BE COMPLETED NOT MORE THAN 2 DAYS PRIOR TO THE DATE SCHEDULED FOR

INSPECTION TO DETERMINE THE DATE OF SUBSTANTIAL COMPLETION.

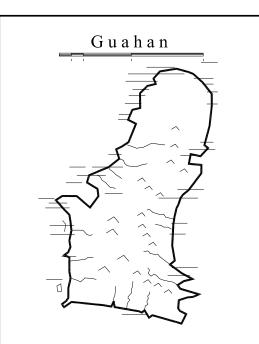

#### GUAM PRESERVATION TRUST

INANGOKKON INADAHI GUÅHAN P.O. BOX 3036, HAGATNA, GUAM 96932

PROJECT TITLE:

RECONSTRUCTION
of
ANTONIA C.
CHARGUALAF

HOUSE,
HISTORIC
DISTRICT OF
INARAJAN,

INARAJAN, GUAM

DPR TRACKING NO: RC 2014 0373

Provido •Tan•Jones
architects inc.



TEL: 671 646 1361 FAX: 671 646 2767

PTJA PROJECT NO: GPT.02

THIS WORK WAS DONE BY ME OR UNDER MY DIRECT SUPERVISION

EXPIRATION DATE: APR, 2015

DRAWING NAME:

GENERAL NOTES


DRAWN: DT DATE: NOV 2014

CHECKED: LP SCALE: AS NOTED

REVISIONS:
DESCRIPTION DATE

DRAWING SHEET NO:

T-2

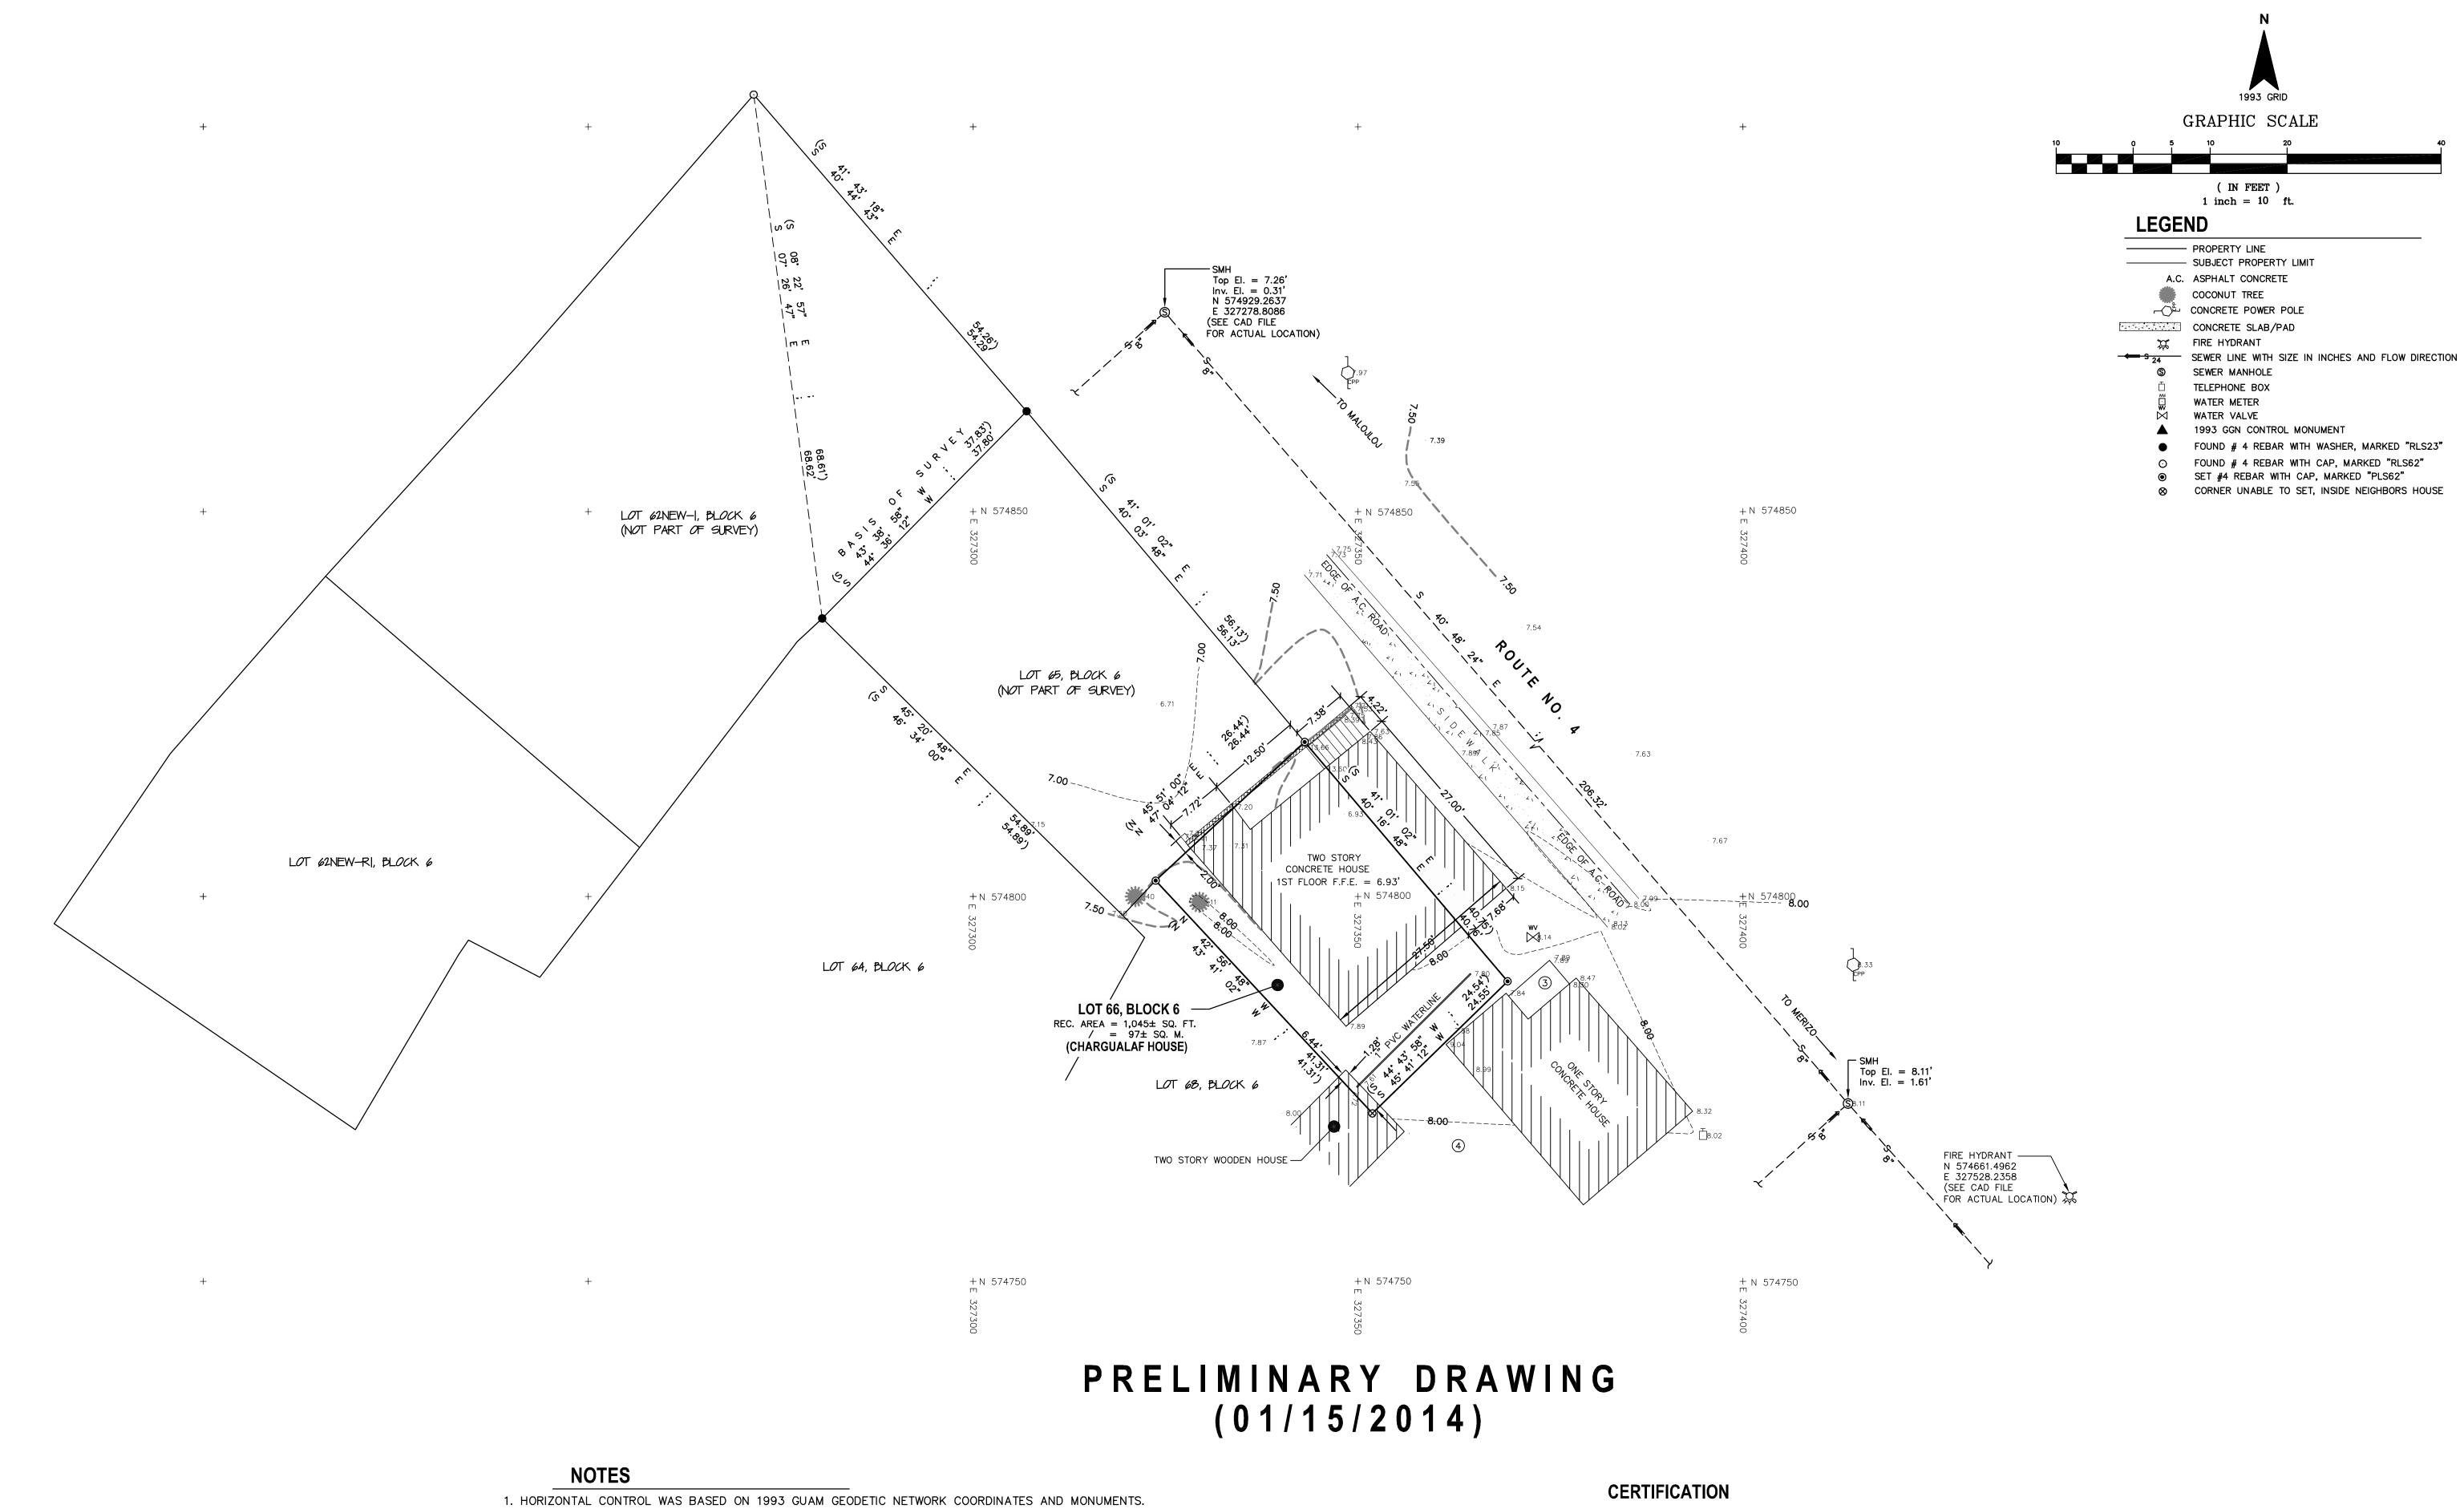

- 2. VERTICAL CONTROL WAS BASED ON MEAN SEA LEVEL DATUM.
- BENCHMARK: GGN 2530, ELEV. = 6.56'
- 3. ALL DISTANCES AND ELEVATIONS SHOWN ARE IN FEET & DECIMALS THEREOF. 4. FIELD WORK WAS PERFORMED IN DECEMBER, 2013.
- 5. LOCATIONS OF COVERED SLABS, A.C. PAVEMENTS, PIPES, AND OTHER UNDERGROUND STRUCTURES ARE DRAWN BASED ON VISIBLE FIXTURES ON THE GROUND AND/OR AVAILABLE DRAWINGS AND THEREFORE ARE ONLY APPROXIMATE IN NATURE.
- 6. THIS TOPOGRAPHIC SURVEY MAP WAS PREPARED FOR THE IMMEDIATE USE BY THE CLIENT. DUE TO TIME AND CHANGING SITE CONDITIONS, EXPRESS OR IMPLIED GUARANTEES FOR THIS TOPOGRAPHIC SURVEY MAP ARE NOT TRANSFERABLE TO THIRD OR SUBSEQUENT PARTIES. THIRD OR SUBSEQUENT PARTIES ARE REQUIRED TO MAKE PRUDENT CHECKS PRIOR TO USE OF THIS TOPOGRAPHIC SURVEY MAP. THE UNDERSIGNED LAND SURVEYOR RECOMMENDS ENGAGING A PROFESSIONAL LAND SURVEYOR TO LAY OUT BUILDINGS AND IMPROVEMENTS PRIOR TO CONSTRUCTION TO VERIFY PROPERTY LINES AND BENCHMARKS.

I, PRUDENCIO R. BALAGTAS, HEREBY CERTIFY THAT THIS MAP WAS PREPARED BY ME OR UNDER MY DIRECT SUPERVISION THAT IT IS BASED ON A FIELD SURVEY MADE IN OCTOBER, 2013, IN CONFORMANCE WITH ALL APPLICABLE LAWS AND REGULATIONS.

DATE

PRUDENCIO R. BALAGTAS

PROFESSIONAL LAND SURVEYOR # 62



TOPOGRAPHIC SURVEY MAP OF LOT 66, BLOCK 6 MUNICIPALITY OF INARAJAN, GUAM

PRUDENCIO R. BALAGTAS & ASSOC., INC.

PRUDENCIO R. BALAGTAS, P.L.S. #62

LAND SURVEYING—TOPOGRAPHIC—GPS—ALTA/ACSM P.O. BOX 6216, TAMUNING, GU 96931 637—2042 (VOICE) 637—2041 (FAX) DWG.# surveyor@kuentos.guam.net PROJ.

DWG.#: PRB2013523-01topo1.dwg PROJ.#: 2013-523ft (RJBL & SBL)

## CONCRETE PAVED FLOOR (W/ THICK OVERGROWTH) KITCHEN 04. 0 0 0 138 1/2" 67 1/2" CONCRETE PAVED FLOOR (W/ THICK OVERGROWTH) 3'-0" 2'-8" 3'-3" 3'-0" 6'-3" 0.4.0 CONCRETE PAVED FLOOR REINF FINE MAMPOSTERIA/ CONC MIX COLUMN (E) CONC JAMB - Buried TREAD 10" 45 1/2" 6"

#### LEGEND


SYMBOL


CMU WALL


REINFORCED CONC WALL

CAST—IN—PLACE REINFORCED FINE MAMPOSTERIA/CONC MIX

DESCRIPTION

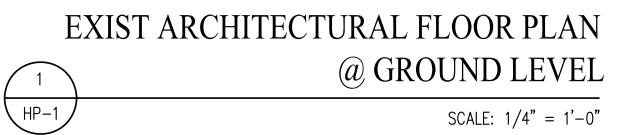

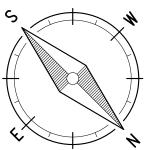

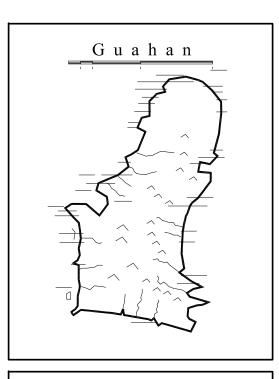

GUAM PRESERVATION TRUST

INANGOKKON INADAHI GUAHAN P.O. BOX 3036, HAGATNA, GUAM 96932

PROJECT TITLE:

RECONSTRUCTION

ANTONIA C. CHARGUALAF HOUSE,

> HISTORIC DISTRICT OF INARAJAN,

INARAJAN, GUAM DPR TRACKING NO: RC 2014 0373

DESIGN CONSULTANT:

Provido Tan Jones



PTJA PROJECT NO: GPT.02

THIS WORK WAS DONE BY ME OR UNDER MY DIRECT SUPERVISION EXPIRATION DATE: APR, 2015

DRAWING NAME:

EXIST ARCH'L FLOOR PLAN

BODEGA/ GROUND LEVEL

DRAWN: DT DATE: NOV 2104

CHECKED: LP SCALE: AS NOTED

REVISIONS:

DESCRIPTION

DRAWING SHEET NO:

HP-1



Side Elevation Chargualaf House (right side of photograph)



Meno House (Left side) & Chargualaf House (Right side) with Original Roadway



Porch /Stairway




Current View showing Elevated Roadway Improvements & Elevated Sidewalk




Buried Stair Tread @ bottom of stair




Exposed Concrete Slab buried under Elevated Grade at adjacent Meno House (Chargulaf house in the background)

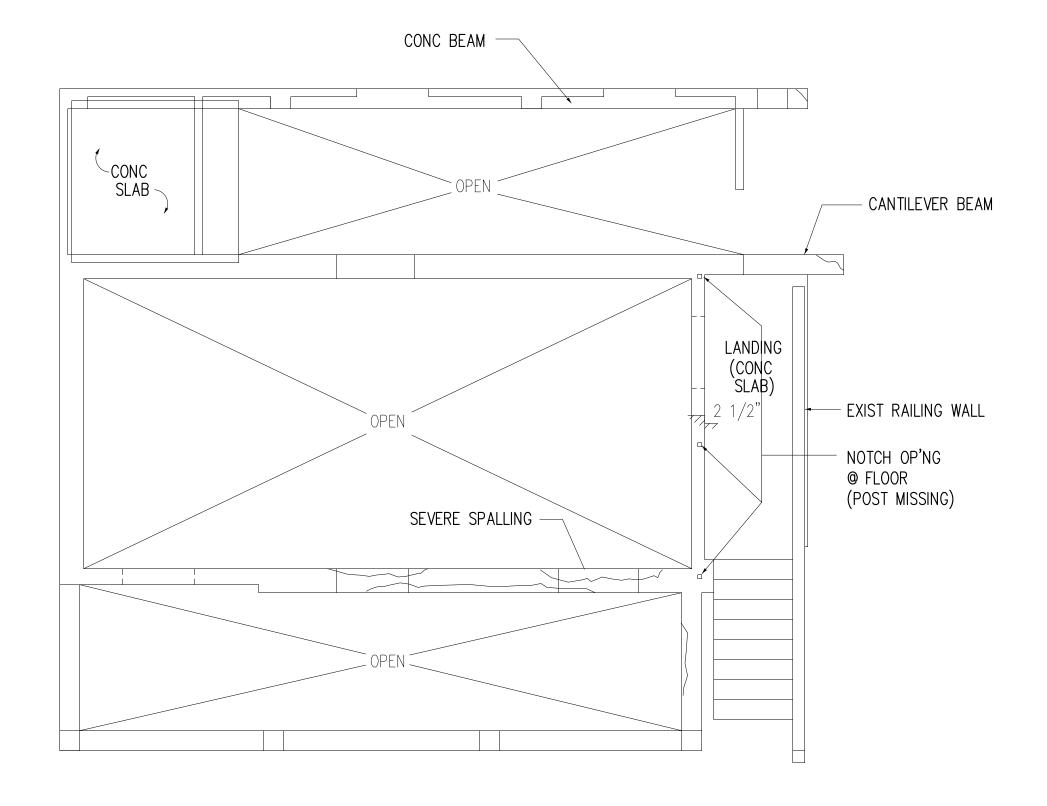

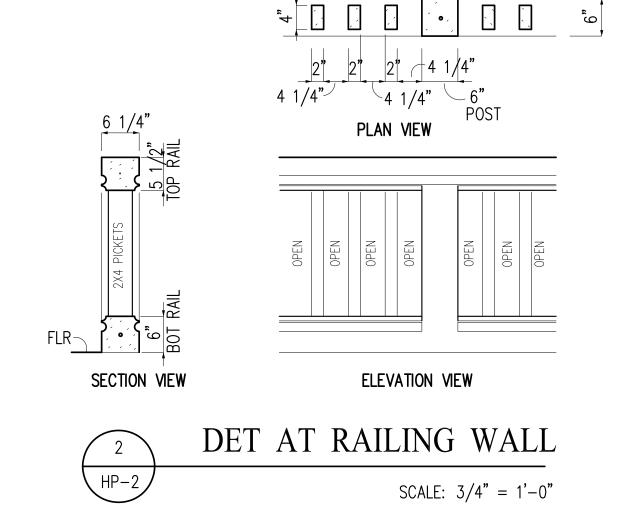



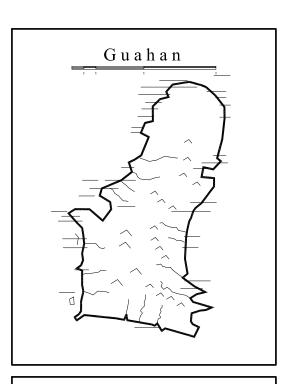

INANGOKKON INADAHI GUAHAN P.O. BOX 3036, HAGATNA, GUAM 96932

PROJECT TITLE:

RECONSTRUCTION
of
ANTONIA C.
CHARGUALAF

HOUSE,

HISTORIC
DISTRICT OF
INARAJAN,
INARAJAN, GUAM

Provido Tan Jones
architects inc.



PTJA PROJECT NO: GPT.02

THIS WORK WAS DONE BY ME OR UNDER MY DIRECT SUPERVISION EXPIRATION DATE: APR, 2015

DRAWING NAME:

EXIST ARCH'L FLOOR PLAN

© UPPER LEVEL

DRAWN: DT DATE: NOVEMBER 2014


CHECKED: LP SCALE: AS NOTED


REVISIONS:

DESCRIPTION DATE

DRAWING SHEET NO:


HP-2

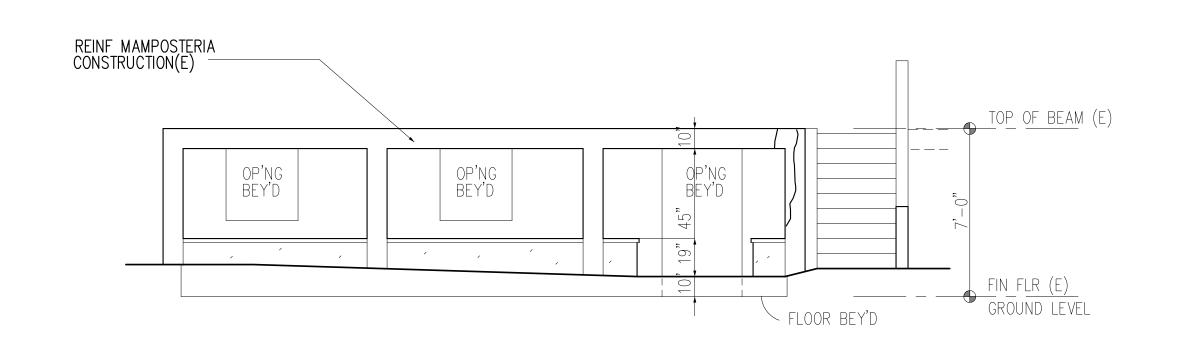

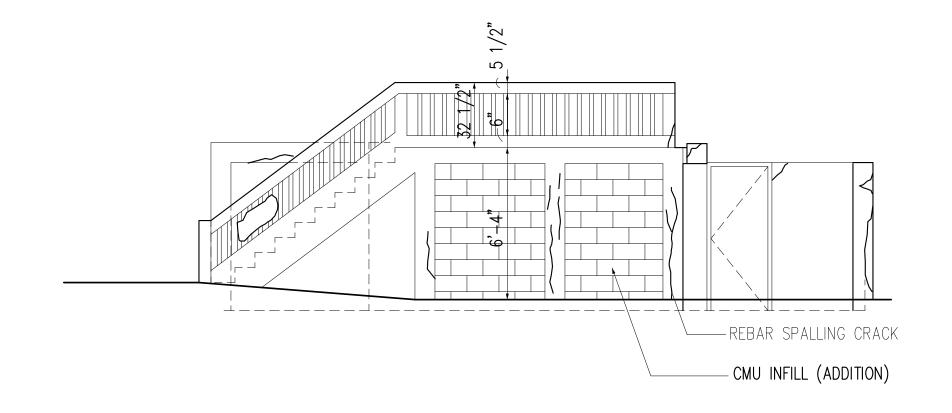







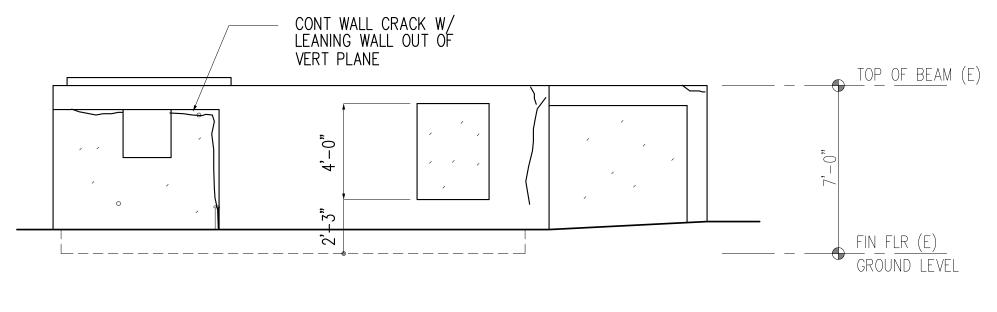



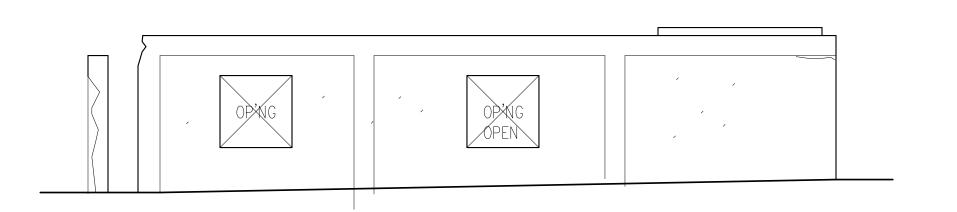



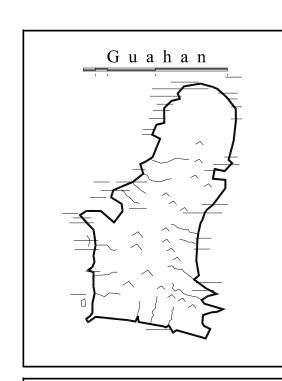

INANGOKKON INADAHI GUAHAN P.O. BOX 3036, HAGATNA, GUAM 96932

PROJECT TITLE:

# RECONSTRUCTION of ANTONIA C. CHARGUALAF HOUSE,

HISTORIC DISTRICT OF INARAJAN, INARAJAN, GUAM

DPR TRACKING NO: RC 2014 0373

DESIGN CONSULTANT:

Provido •Tan•·lone

## Provido Tan Jones architects inc.



PTJA PROJECT NO: GPT.02

THIS WORK WAS DONE BY ME OR UNDER MY DIRECT SUPERVISION EXPIRATION DATE: APR, 2015

DRAWING NAME:


EXIST

BLDG ELEVATION

DRAWN: DT DATE: NOV 2104


CHECKED: LP SCALE: AS NOTED

REVISIONS:

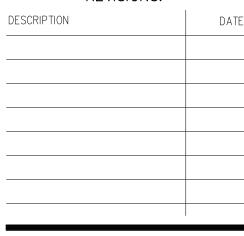

DRAWING SHEET NO:

HP-3

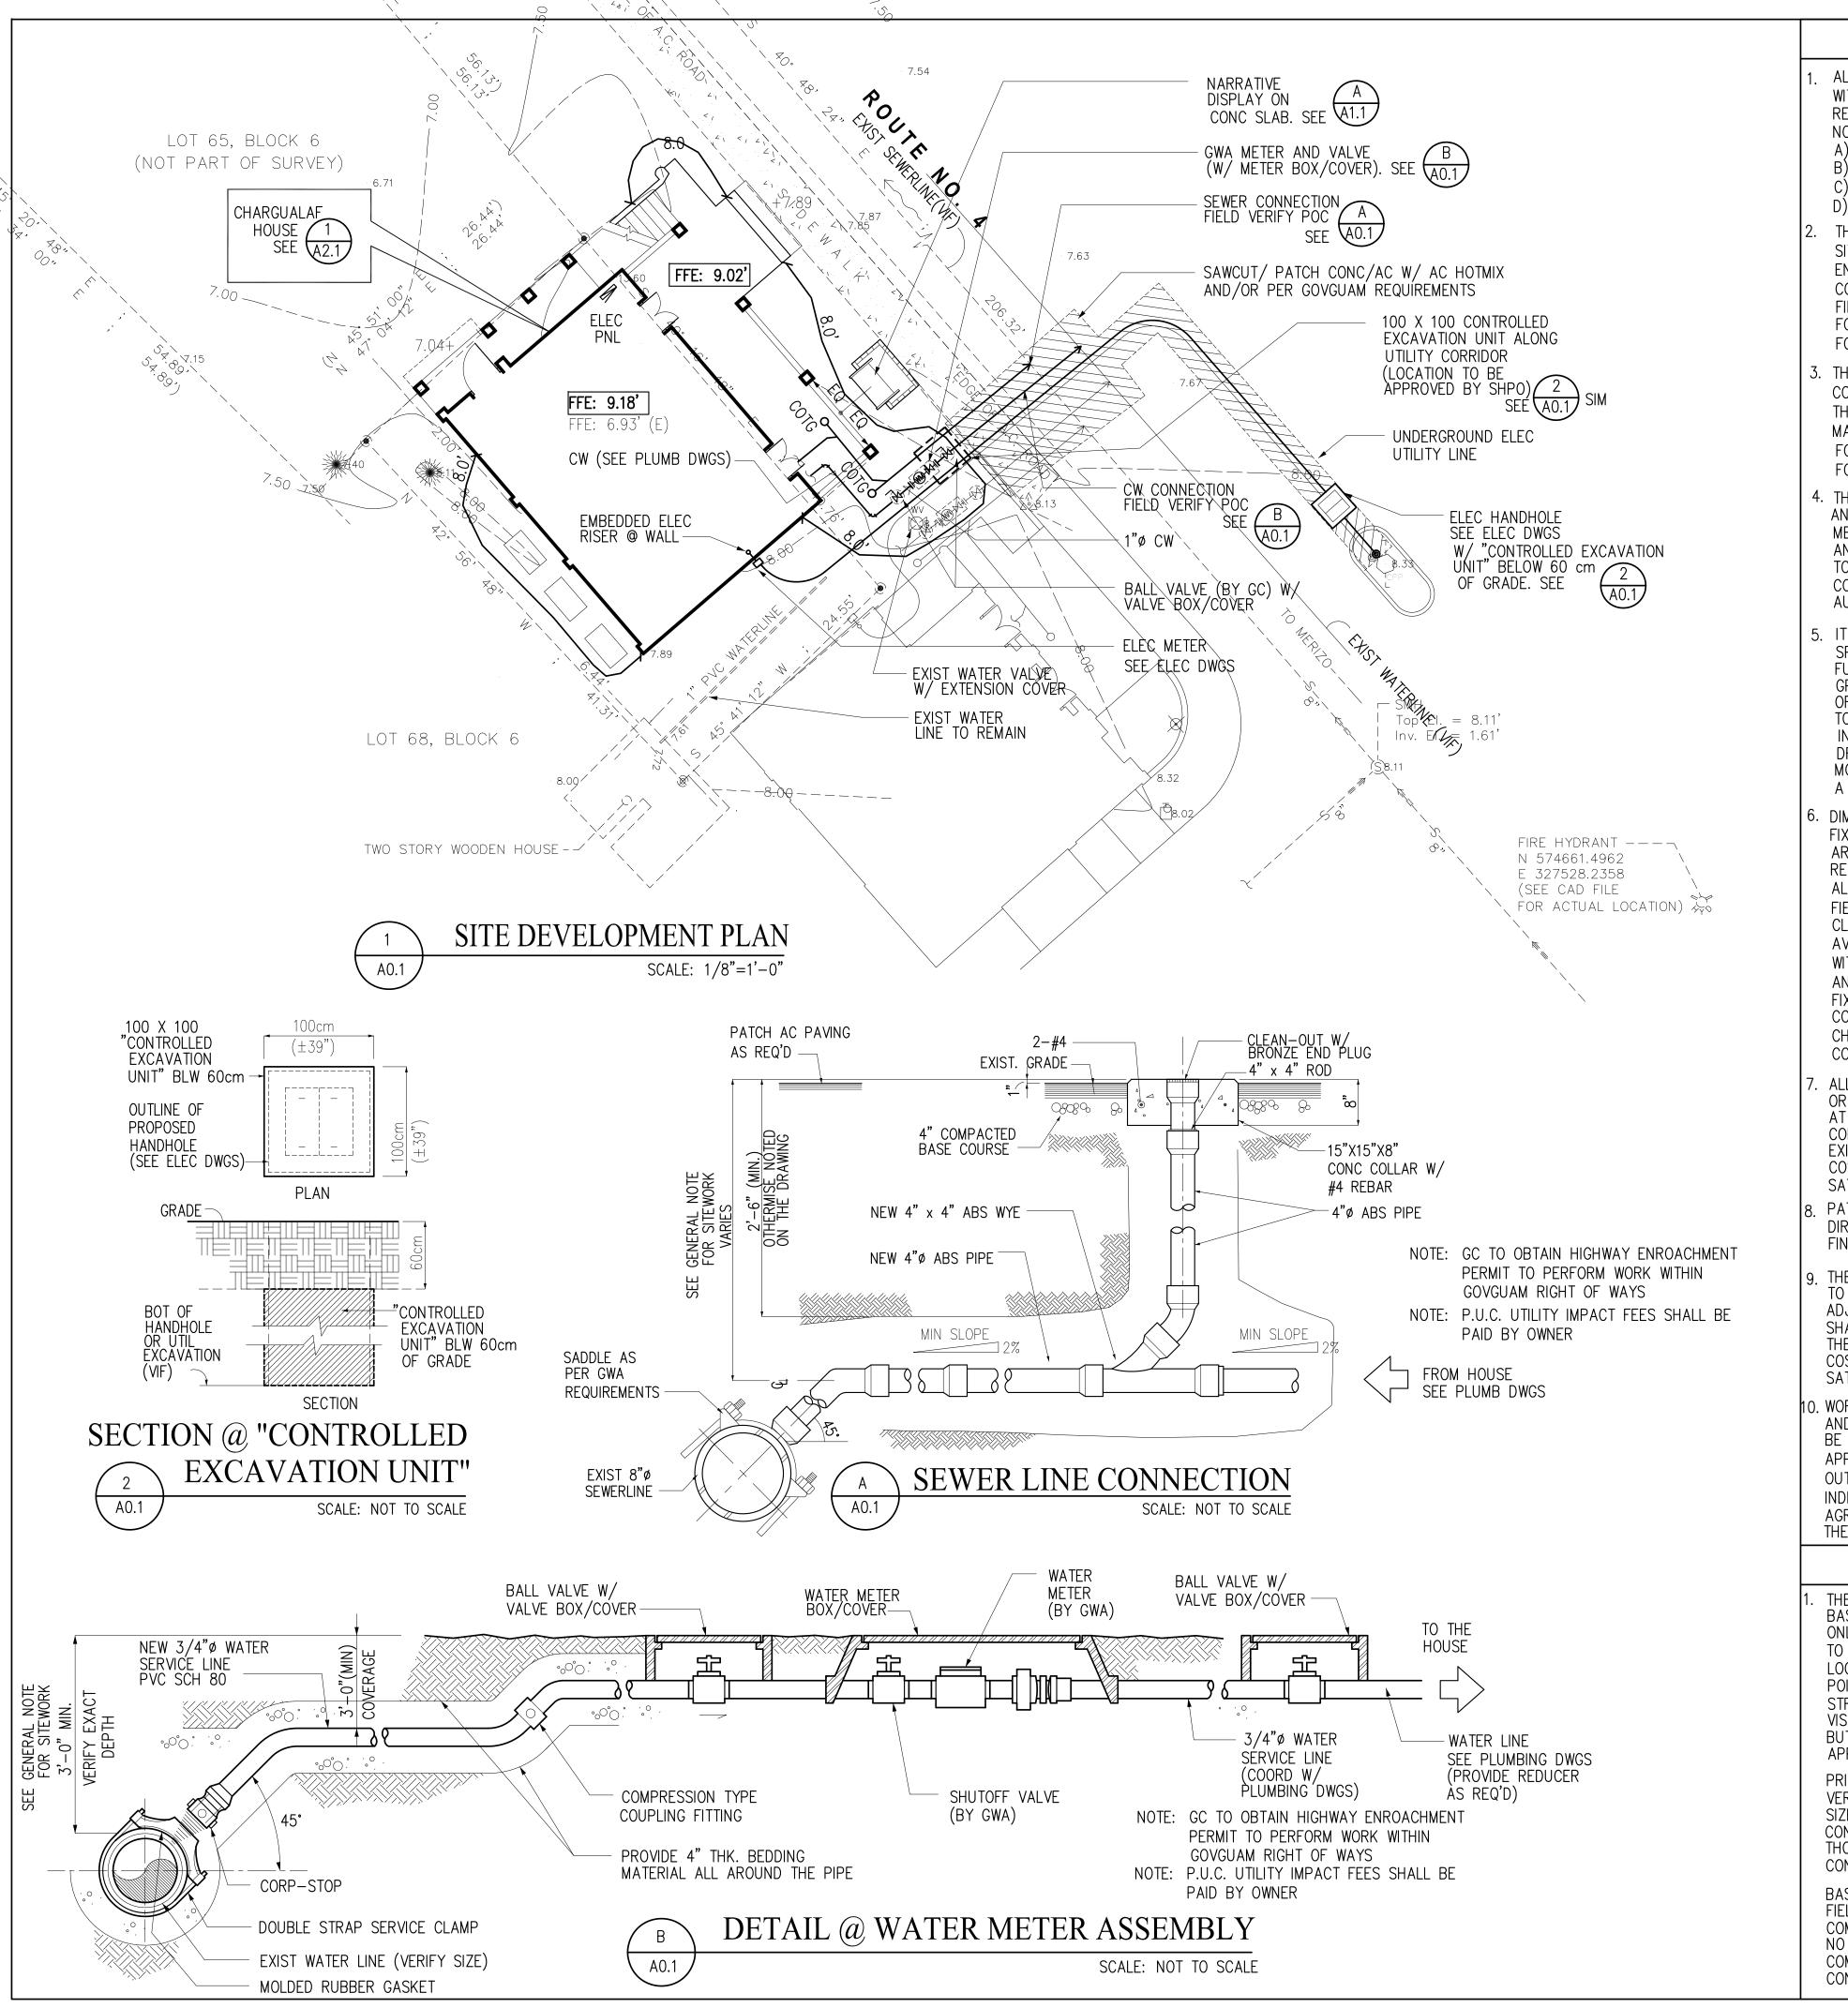

#### GENERAL NOTES

- . ALL WORK SHALL BE PERFORMED IN FULL COMPLIANCE WITH ALL APPLICABLE GOVGUAM AND FEDERAL REGULATIONS, CODES AND STANDARDS, INCLUDING BUT NOT LIMITED TO THE FOLLOWING:

  A) INTERNATIONAL RESIDENTIAL CODE (ICC 2009)

  B) INTERNATIONAL EXISTING BUILDING CODE (ICC 2009)

  C) SEC'Y OF INTERIOR'S STANDARDS OF RECONSTRUCTION D) STATE HISTORIC PRESERVATION OFFICER (SHPO)
- 2. THE CONTRACTOR SHALL EXAMINE AND VERIFY EXISTING SITE CONDITIONS AND OTHER CONDITIONS LIKELY TO BE ENCOUNTERED AND SHALL NOTIFY IMMEDIATELY THE CONTRACT ADMINISTRATOR OF ANY DISCREPANCIES HE MA FIND BEFORE PROCEEDING WITH THE PARTICULAR WORK. FOR PURPOSES OF BID, IF ANY DISCREPANCIES ARE FOUND, THE MOST COSTLY REQUIREMENT SHALL GOVERN.
- THE CONTRACTOR SHALL EXAMINE AND COORDINATE THE CONTRACT DOCUMENTS AND SHALL NOTIFY IMMEDIATELY THE CONTRACT ADMINISTRATOR OF ANY DISCREPANCIES HE MAY FIND BEFORE PROCEEDING WITH THE PARTICULAR WORLFOR PURPOSES OF BID, IF ANY DISCREPANCIES ARE FOUND, THE MOST COSTLY REQUIREMENT SHALL GOVERN.
- 4. THE CONTRACTOR SHALL BE SOLELY RESPONSIBLE FOR AND HAVE CONTROL OVER ALL CONSTRUCTION MEANS, METHODS, TECHNIQUES, SEQUENCES AND PROCEDURES, AND FOR COORDINATING ALL PORTIONS OF THE WORK TO FULLY COMPLY WITH THE REQUIREMENTS OF THE CONTRACT DOCUMENTS, GOVERNING LAWS, AND AUTHORITIES HAVING JURISDICTION.
- 5. IT IS THE DESIGN INTENT OF THESE DRAWINGS AND SPECIFICATIONS TO PROVIDE FOR A COMPLETE AND FUNCTIONAL FACILITY TO THE SATISFACTION OF SHPO/GPT CONTRACT ADMINISTRATOR. AS PART OF THE SCOPE OF WORK, THE CONTRACTOR SHALL PROVIDE MATERIALS, TOOLS, AND LABOR REQUIRED FOR A COMPLETE INSTALLATION OF SUCH A FACILITY AS SHOWN IN THE DRAWINGS OR IF NOT SHOWN, AS REQUIRED BY THE MORE STRINGENT AND/OR COSTLY REQUIREMENTS FOR A COMPLETE AND FUNCTIONAL FACILITY.
- DIMENSIONS, LOCATIONS AND MOUNTING HEIGHTS OF DEVICES FIXTURES AND APPERTUNANCES NOTED IN DESIGN DRAWINGS ARE NOMINAL AND APPROXIMATE ONLY. SUBJECT TO OTHER REQUIREMENTS AND PRIOR TO INSTALLATION, COORDINATE ALL DIMENSIONS, LOCATIONS AND MOUNTING HEIGHTS WITH FIELD CONDITIONS, ACTUAL SIZES, EQUIPMENT ACCESS AND CLEARANCES, AND REQUIREMENTS OF ALL TRADES TO AVOID CONFLICT. IF NECESSARY, AND IN FULL COMPLIANCE WITH AUTHORITIES HAVING JURISDICTION, FIELD—ENGINEER AND RE—ARRANGE, REROUTE AND RELOCATE DEVICES, FIXTURES AND OTHER APPERTUNANCES REQUIRED FOR A COMPLETE AND FULLY FUNCTIONAL FACILITY WITHOUT ANY CHANGE TO THE CONTRACT COST AMOUNT AND/OR COMPLETION TIME.
- 7. ALL EXISTING FACILITIES AND UTILITIES, WHETHER SHOWN OR NOT SHOWN IN THE DRAWINGS SHALL BE PROTECTED AT ALL TIMES DURING CONSTRUCTION. IF DAMAGED, THE CONTRACTOR SHALL REPAIR AND RESTORE THEM TO THEIR EXISTING CONDITIONS WITH NO CHANGE TO THE CONTRACT COST AMOUNT AND COMPLETION TIME, AND TO THE SATISFACTION OF THE CONTRACT ADMINISTRATOR.
- PATCH AND/OR REPAIR ALL EXPOSED AREAS THAT RESULT DIRECTLY FROM DEMOLITION WORK. THESE AREAS SHALL BE FINISHED TO MATCH ADJACENT FINISHES AND APPEARANCE.
- THE CONTRACTOR SHALL NOT DISRUPT UTILITY SERVICES TO ADJACENT FACILITIES. WHERE DISRUPTION OF SERVICES ADJACENT FACILITIES IS UNAVOIDABLE, THE CONTRACTOR SHALL PROVIDE TEMPORARY UTILITY SERVICE TO MINIMIZE THE INTERUPTION WITH NO CHANGE TO THE CONTRACT COST AMOUNT AND COMPLETION TIME, AND TO THE SATISFACTION OF THE CONTRACT ADMINISTRATOR.
- O. WORK THAT RESULT IN INCREASED/REDUCED COST AMOUNT AND/OR COMPLETION TIME OF THE CONTRACT SHALL NOT BE MADE BY THE CONTRACTOR WITHOUT WRITTEN AND APPROVED (NEGOTIATED) CHANGE ORDER. WORK CARRIED OUT WITHOUT ANY FORMAL EXECUTION OF CHANGE ORDER INDICATES THE CONTRACTOR'S ACKNOWLEDGEMENT AND AGREEMENT THAT THERE ARE NO INCREASE/REDUCTION TO THE CONTRACT COST AMOUNT AND/OR COMPLETION TIME.

#### GENERAL NOTES FOR SITEWORK

THE TOPOGRAPHIC SURVEY SHOWN IN THE DRAWINGS IS BASED ON VISIBLE FEATURES ON THE GROUND. IT IS ONLY APPROXIMATE IN NATURE AND IS NOT INTENDED TO SHOW CONCEAL OR LATENT CONDITIONS. FURTHERMORE LOCATION OF STRUCTURES, DRIVEWAYS, SLABS, TREES, POINTS OF CONNECTIONS OF UTILITIES, UNDERGROUND STRUCTURES OR OTHER UTILITIES, ARE DRAWN BASED ON VISIBLE FEATURES ON THE GROUND OR FROM AVAILABLE BUT UNVERIFIED DRAWINGS AND THEREFORE, ARE ONLY APPROXIMATE IN NATURE.

PRIOR TO THE START OF WORK, THE CONTRACTOR SHALL VERIFY THE ACCURACY OF THE TOPOGRAPHIC SURVEY, SIZES, TYPES OF MATERIALS, LOCATIONS, DEPTHS, AND CONDITION OF ALL STRUCTURES AND UTILITIES INCLUDING THOSE NOT SHOWN IN THE DRAWINGS, AND INVESTIGATE CONCEALED OR LATENT CONDITIONS.


BASED ON ACTUAL CONDITIONS, THE CONTRACTOR SHALL FIELD ENGINEER AND MODIFY THE WORK TO ENSURE A COMPLETE AND FULLY FUNCTIONAL INSTALLATION WITH NO CHANGE TO THE CONTRACT COST AMOUNT AND COMPLETION TIME, AND TO THE SATISFACTION OF THE CONTRACT ADMINISTRATOR.

2. PROPERTY LINES AND EASEMENTS ARE BASED ON PROPERTY MAP BY: GUAM CADASTRAL MAP SERIES LAND SQUARE 37 SECTION I.T. (COM.NAV.MAR) DWG 10964 SECTION I.S. (COM.NAV.MAR) DWG 10963

THE CONTRACTOR SHALL PROVIDE A REGISTERED LAND SURVEYOR (RLS) TO LAYOUT THE NEW CONSTRUCTION AND VERIFY ALL LOCATIONS OF PROPERTY BOUNDARIES AND MARKERS (MONUMENTS, ETC) BEFORE LAYOUT OF THE NEW CONSTRUCTION. WHERE MARKERS ARE MISSING, THE SURVEYOR SHALL CONDUCT RETRACEMENT SURVEY AND REPLACE MISSING POINTS WITH HIS MONUMENT.

REFER TO TOPO SURVEY FOR TEMPORARY BENCH MARK (TBM) CONTROLS. WHERE GEODETIC SURVEY MARKERS ARE FOUND, DO NOT MOVE THEM.

- THE SOIL REPORT SHOWN AS PART OF DESIGN DOCUMENTS ARE BASED ON SPECIFIC TEST PITS AT RANDOM LOCATIONS. IT IS INTENDED TO BE CONSIDERED DURING THE DESIGN PHASE ONLY AND IS NOT INTENDED TO BE GENERALIZED TO THE REST OF THE SITE DURING CONSTRUCTION.
- THE CONTRACTOR SHALL EMPLOY A REGISTERED SOIL/GEO-TECHNICAL ENG'R TO MONITOR AND REVIEW SOIL EXCAVATION AND SOIL PREPARATION WORK. BASED ON UNCOVERED OR ACTUAL FIELD-CONDITIONS, THE CONTRACTOR'S SOIL/GEO-TECHNICAL ENG'R SHALL PROVIDE FIELD RECOMMENDATIONS, TESTING (IF NEEDED) AND REVIEW SOIL PREPARATION WORK TO ACHIEVE THE SOIL BEARING CAPACITY AND OTHER APPLICABLE REQUIREMENTS.
- THE CONTRACTOR SHALL COMPLY WITH RECOMMENDATIONS OF THE SOIL/ GEO-TECHNICAL ENGINEER AS PART OF THE SCOPE OF WORK. WHERE COMPACTED FILL FOR THE BLDG STRUCTURE IS TO BE PROVIDED, A LIQUEFACTION POTENTIAL REPORT IS REQUIRED UNLESS WAIVERED BY THE SOIL / GEO-TECHNICAL ENGINEER IN WRITING.
- PRIOR TO EXCAVATION FOR NEW WORK OR UTILITIES OR THE PURCHASE OF MATERIALS, THE CONTRACTOR SHALL UNCOVER AND EXPOSE POINTS OF CONTACT WITH EXIST WORK OR UTILITIES TO VERIFY EXACT LOCATIONS, SIZES, TYPE AND GENERAL CONDITIONS. IF NECESSARY, AND BASED ON ACTUAL UNCOVERED CONDITIONS, THE CONTRACTOR SHALL FIELD ENGINEER AND MODIFY THE WORK TO ACHIEVE A COMPLETE AND FUNCTIONAL INSTALLATION AT NO CHANGE TO THE CONSTRUCTION COST AMOUNT AND COMPLETION TIME, AND TO THE SATISFACTION OF THE CONTRACT ADMINISTRATOR.
- THE CONTRACTOR SHALL NOT INTERRUPT EXISTING VEHICULAR AND PEDESTRIAN TRAFFIC FLOW. WHERE INTERRUPTION OF EXISTING TRAFFIC FLOW OCCURS, THE CONTRACTOR SHALL PROVIDE ALTERNATIVE MEANS TO MITIGATE THE INTERRUPTION TO THE SATISFACTION OF THE CONTRACT ADMINISTRATOR. AND WITH NO CHANGE TO THE CONTRACT COST AMOUNT AND COMPLETION TIME.
- 6. PROVIDE TERMITE TREATMENT TO FORM AN UNBROKEN VERTICAL AND HORIZONTAL BARRIER FOR THE BLDG. TERMITE TREATMENT SHALL INCLUDE BUT NOT LIMITED TO SATURATION OF GRADE OR BACKFILL BLW CONC SLAB, SATURATION OF SURROUNDING GRADE WITHIN 5 FEET OF BLDG, AND THE SATURATION OF PIPING/CONDUIT PENETRATION INTO THE BLDG FOOTING WALL. PROVIDE WARANTY OF NOT LESS THAN 3 YEARS FROM THE DATE OF SUBSTANTIAL COMPLETION. WITHIN THE 3 YEAR PERIOD, PROVIDE FOLLOW—UP POST—CONSTRUCTION TREATMENT, MAINTENANCE SERVICE TO MONITOR, LOCATE AND TERMINATE ANY TERMITE ACTIVITY.
- THE CONTRACTOR SHALL COORDINATE AND OBTAIN ALL PERMITS AND CLEARANCES FROM GOVGUAM AGENCIES PRIOR TO ANY ON—SITE OR OFF—SITE CONSTRUCTION. THE CONTRACTOR SHALL ALSO PROVIDE AND COMPLY W/ AN EROSION CONTROL PLAN, ENVIRONMENTAL PROTECTION PLAN, IF REQUIRED BY G.E.P.A. AND HIGHWAY ENROACHMENT PLAN, IF REQ'D BY DPW WHERE UTILITY EASEMENTS ARE REQ'D, THE CONTRACTOR SHALL COORDINATE WITH GOVERNING UTILITY AGENCY AND PROVIDE A REGISTERED LAND SURVEYOR TO DOCUMENT THE EASEMENT LOCATIONS.
- 8. THE CONTRACTOR SHALL PREPARE AN EXCAVATION PLAN (SHOP DRAWING) TO SHOW ALL EXCAVATION WORK BELOW EXIST RECENTLY DISTURBED GRADE AND/OR KNOWN STRUCTURE INCLUDING EXIST SLAB, FOOTING, BASE COURSE OR DISTURBED SOILS. SUBMIT EXCAVATION PLAN WITH TIME SCHEDULE, PROPOSED METHODS OF EXCAVATION AND LOCATIONS OF EXCAVATION TO BE MONITORED BY AN ARCHEOLOGIST AND "CONTROLLED EXCAVATION UNITS" (TO BE EXCAVATED/DOCUMENTED BY AN ARCHEOLOGIST)
- THE CONTRACTOR SHALL EMPLOY AN ARCHEOLOGIST (AS APPROVED BY STATE HISTORIC PRESERVATION OFFICE OR SHPO) TO MONITOR/REVIEW EXCAVATION WORK (W/ A DATA RECOVERY STRATEGY IN THE EVENT OF FINDING SIGNIFICANT DEPOSITS), AS WELL AS TO PERFORM "CONTROLLED EXCAVATION UNITS" IN COMPLIANCE WITH SHPO.

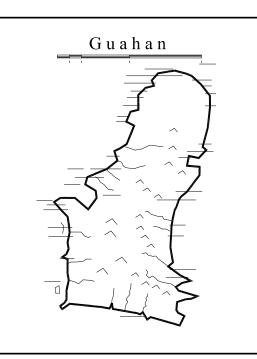

GUAM PRESERVATION TRUST

INANGOKKON INADAHI GUÅHAN P.O. BOX 3036, HAGATNA, GUAM 96932

ECT TITLE:


RECONSTRUCTION
of
ANTONIA
CHARGUALAF
HOUSE,

HISTORIC DISTRICT OF INARAJAN,

INARAJAN, GUAM

DESIGN CONSULTANT:

Provido •Tan•Jones
architects inc.

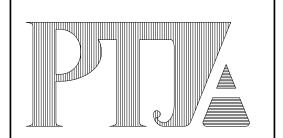

P.O. BOX 6463, TAMUNING, GUAM 96931 TEL: 671 646 1361 FAX: 671 646 2767

PTJA PROJECT NO: GPT.02

THIS WORK WAS DONE BY ME OR UNDER MY DIRECT SUPERVISION EXPIRATION DATE: APR, 2015

DRAWING NAME:

SITE PLAN

DRAWN: DT DATE: NOV 201


CHECKED: LP SCALE: AS NOTE

REVISIONS:

DESCRIPTION


DRAWING SHEET NO:

A0.1

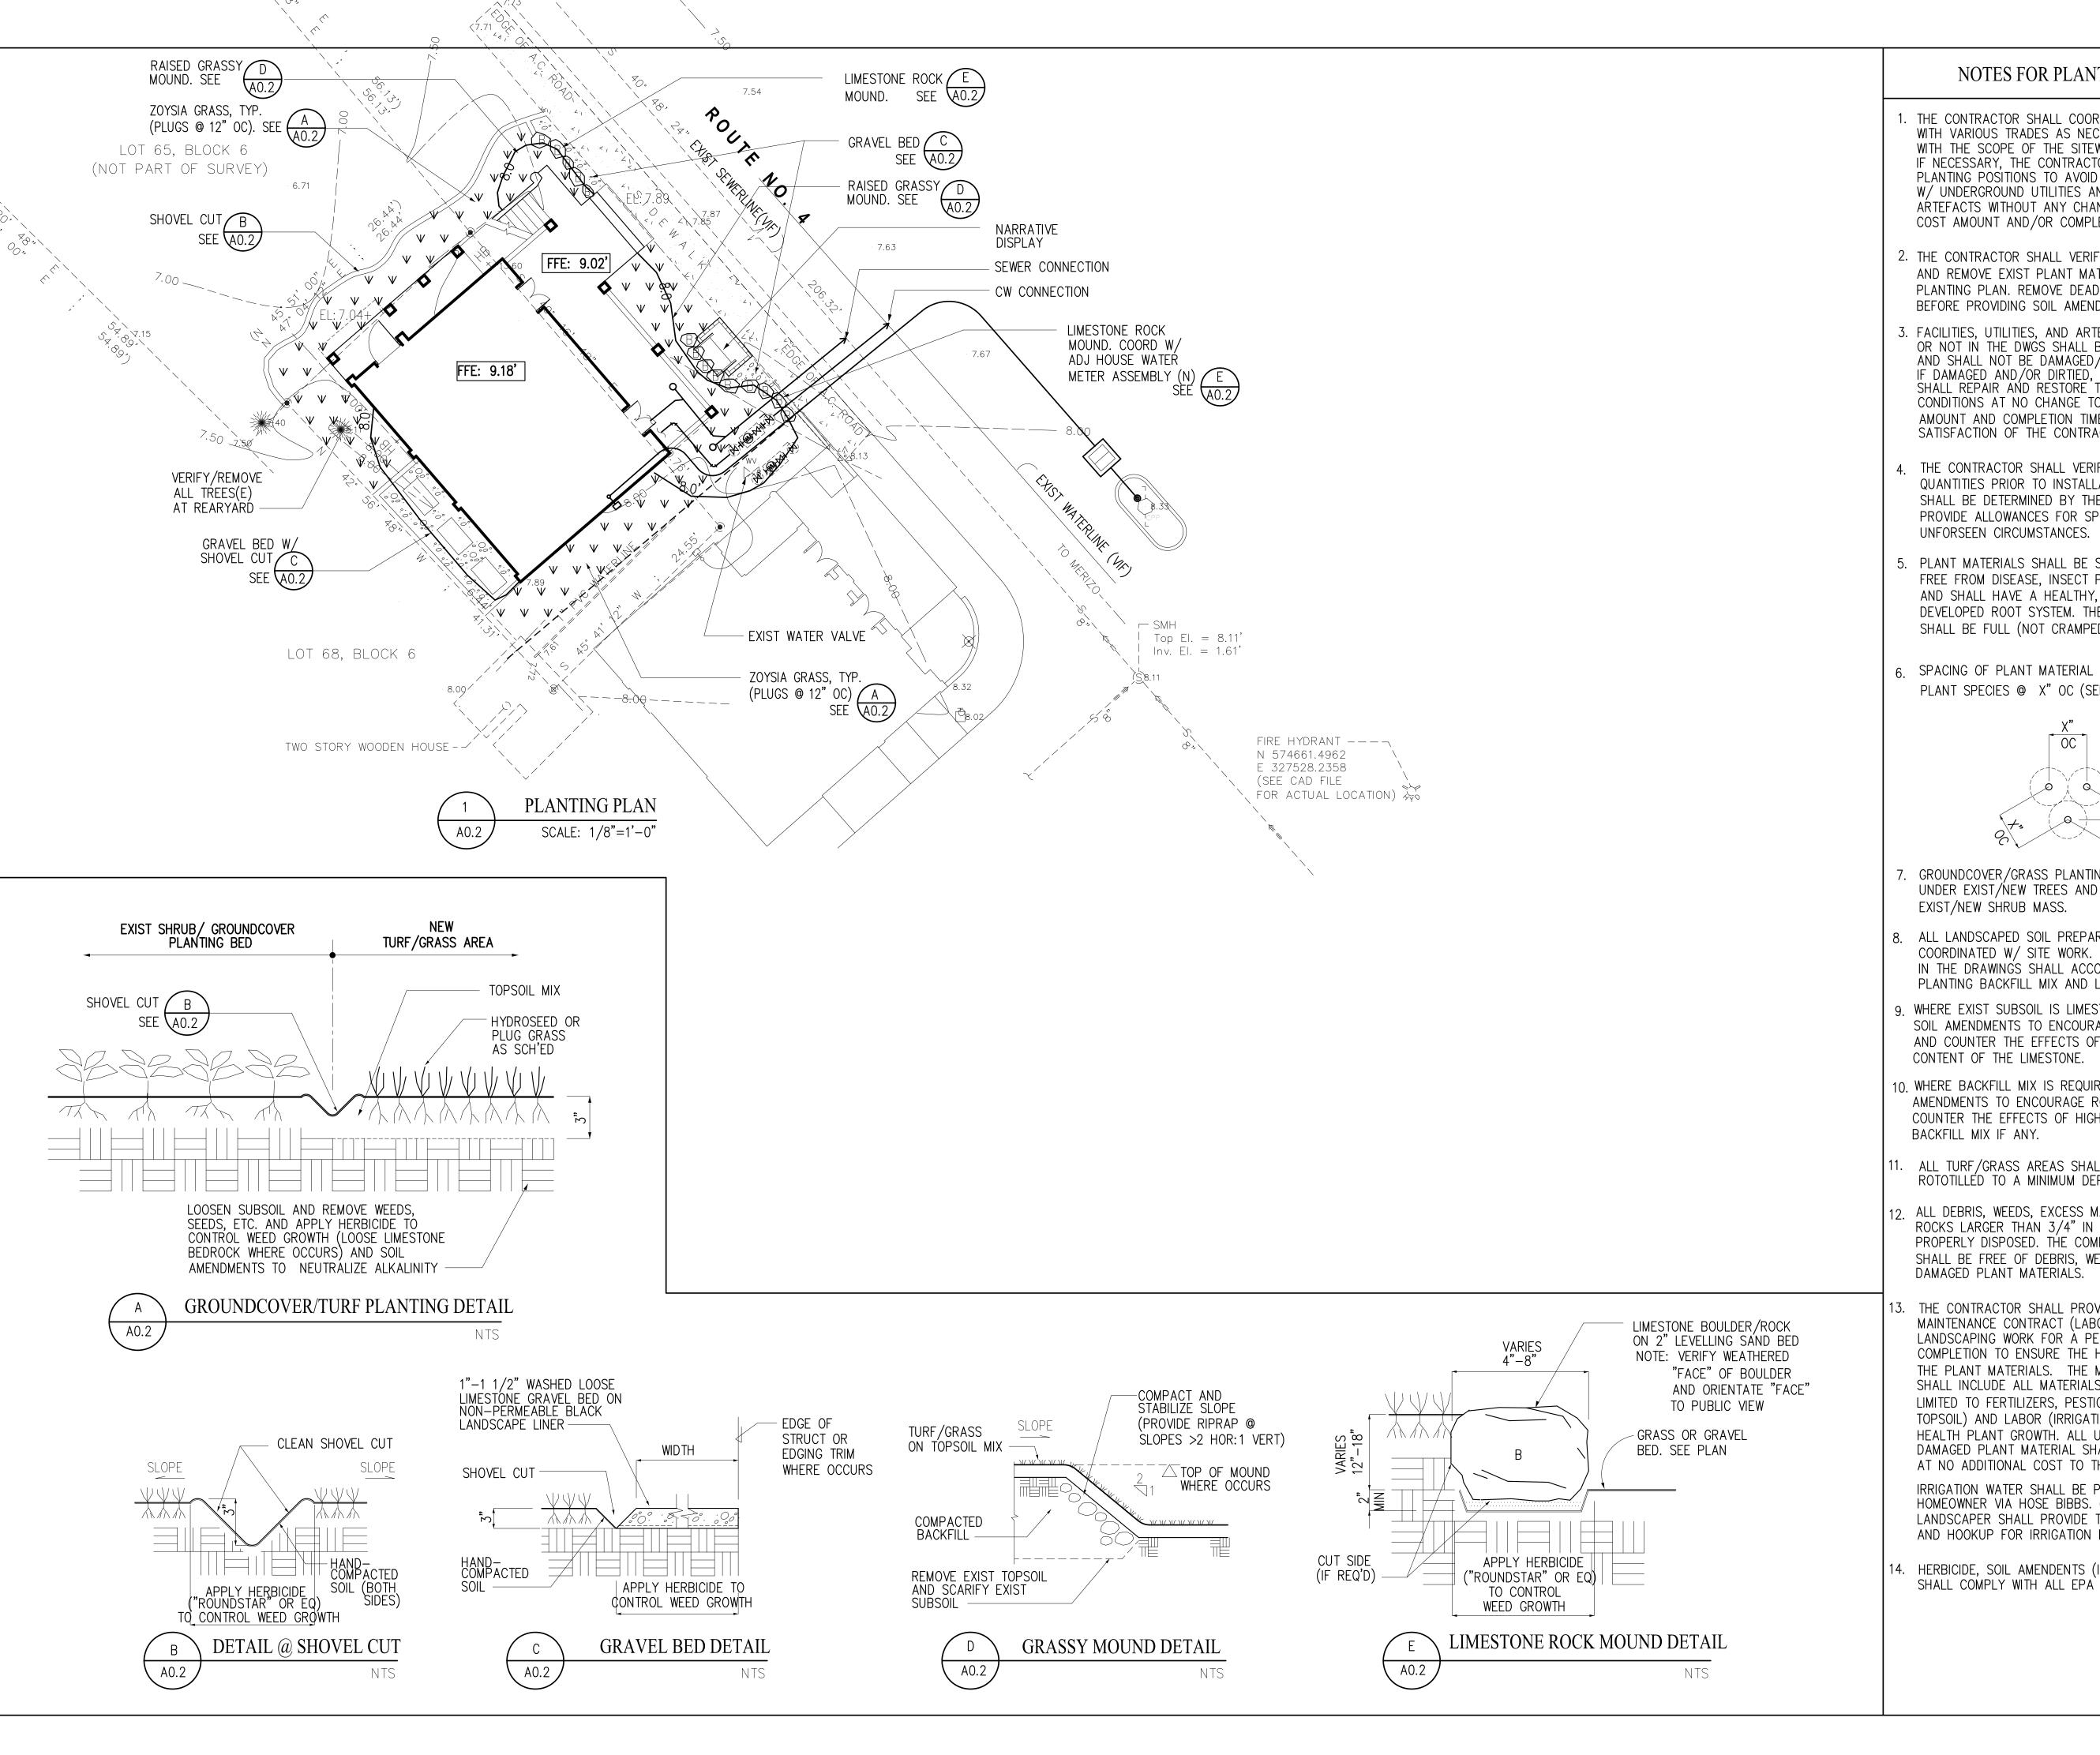




- . THE CONTRACTOR SHALL COORDINATE PLANTING WORK WITH VARIOUS TRADES AS NECESSARY TO AVOID CONFLICTS WITH THE SCOPE OF THE SITEWORK AND SCHEDULE. IF NECESSARY, THE CONTRACTOR SHALL RELOCATE PLANTING POSITIONS TO AVOID POTENTIAL CONFLICT W/ UNDERGROUND UTILITIES AND/OR ARCHEOLOGICAL ARTEFACTS WITHOUT ANY CHANGE TO CONTRACT COST COST AMOUNT AND/OR COMPLETION TIME.
- 2. THE CONTRACTOR SHALL VERIFY EXIST FIELD CONDITIONS AND REMOVE EXIST PLANT MATERIAL IN CONFLICT WITH PLANTING PLAN. REMOVE DEAD ROOTS, WEEDS AND DEBRIS BEFORE PROVIDING SOIL AMENDMENT/TOPSOIL
- 5. FACILITIES, UTILITIES, AND ARTEFACTS WHETHER SHOWN OR NOT IN THE DWGS SHALL BE PROTECTED AT ALL TIMES, AND SHALL NOT BE DAMAGED / DIRTIED DURING WORK. IF DAMAGED AND/OR DIRTIED, THE CONTRACTOR SHALL REPAIR AND RESTORE THEM TO THEIR EXISTING CONDITIONS AT NO CHANGE TO THE CONTRACT COST AMOUNT AND COMPLETION TIME, AND TO THE SATISFACTION OF THE CONTRACT ADMINISTRATOR.
- 4. THE CONTRACTOR SHALL VERIFY ALL PLANT MATERIAL AND QUANTITIES PRIOR TO INSTALLATION. ACTUAL QUANTITIES SHALL BE DETERMINED BY THE CONTRACTOR, AND SHALL PROVIDE ALLOWANCES FOR SPOILAGE, DAMAGE AND OTHER
- 5. PLANT MATERIALS SHALL BE SOUND AND VIGOROUS, FREE FROM DISEASE, INSECT PESTS, AND/OR THEIR EGGS, AND SHALL HAVE A HEALTHY, NORMAL AND FULLY DEVELOPED ROOT SYSTEM. THE ROOT SYSTEM SHALL BE SHALL BE FULL (NOT CRAMPED) IN CONTAINERS.
- 6. SPACING OF PLANT MATERIAL SHALL AS FOLLOWS: PLANT SPECIES @ X" OC (SEE SKETCH BELOW)

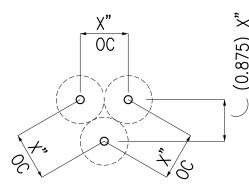

- GROUNDCOVER/GRASS PLANTING SHALL BE CONTINUOUS UNDER EXIST/NEW TREES AND UP TO THE EDGE OF
- 8. ALL LANDSCAPED SOIL PREPARATION WORK SHALL BE COORDINATED W/ SITE WORK. FINISH GRADES SHOWN IN THE DRAWINGS SHALL ACCOUNT FOR TOPSOIL, PLANTING BACKFILL MIX AND LANDSCAPED BERMS.
- 9. WHERE EXIST SUBSOIL IS LIMESTONE-BASED, PROVIDE SOIL AMENDMENTS TO ENCOURAGE ROOT/LEAF GROWTH AND COUNTER THE EFFECTS OF HIGH ALKALINITY
- 10. WHERE BACKFILL MIX IS REQUIRED, PROVIDE SOIL AMENDMENTS TO ENCOURAGE ROOT/LEAF GROWTH AND COUNTER THE EFFECTS OF HIGH ALKALINITY CONTENT OF
- ALL TURF/GRASS AREAS SHALL HAVE TOPSOIL MIX ROTOTILLÉD TO A MINIMUM DEPTH OF 3".
- 12 ALL DEBRIS, WEEDS, EXCESS MATERIALS AND UNWANTED ROCKS LARGER THAN 3/4" IN DIAMETER SHALL BE PROPERLY DISPOSED. THE COMPLETED LANDSCAPED AREAS SHALL BE FREE OF DEBRIS, WEEDS, UNHEALTHY AND/OR
- 13. THE CONTRACTOR SHALL PROVIDE A LANDSCAPE MAINTENANCE CONTRACT (LABOR/MATERIAL) FOR THE LANDSCAPING WORK FOR A PERIOD OF 4 MONTHS AFTER COMPLETION TO ENSURE THE HEALTHY GROWTH OF THE PLANT MATERIALS. THE MAINTENANCE CONTRACT SHALL INCLUDE ALL MATERIALS (INCLUDING BUT NOT LIMITED TO FERTILIZERS, PESTICIDES, HERBICIDES, MULCH, TOPSOIL) AND LABOR (IRRIGATION, ETC) TO PROMOTE HEALTH PLANT GROWTH. ALL UNHEALTHY AND/OR DAMAGED PLANT MATERIAL SHALL BE REPLACÉD AT NO ADDITIONAL COST TO THE CONTRACT AMOUNT. IRRIGATION WATER SHALL BE PROVIDED BY THE HOMEOWNER VIA HOSE BIBBS. (IF NEEDED, THE LANDSCAPER SHALL PROVIDE TEMPORARY GARDEN HOSE AND HOOKUP FOR IRRIGATION PURPOSES)
- HERBICIDE, SOIL AMENDENTS (INCLUDING FERTILIZERS) SHALL COMPLY WITH ALL EPA GUIDELINES.

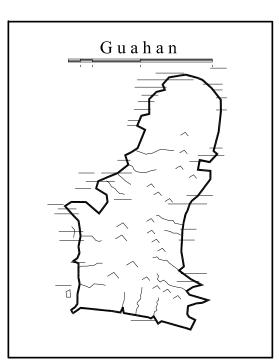

INANGOKKON INADAHI GUAHAN P.O. BOX 3036, HAGATNA, GUAM 96932

PROJECT TITLE:

RECONSTRUCTION **ANTONIA CHARGUALAF** 

> HOUSE, HISTORIC DISTRICT OF

INARAJAN,

INARAJAN, GUAM

**DESIGN CONSULTANT:** Provido •Tan•Jones architects



TEL: 671 646 1361 FAX: 671 646 2767

PTJA PROJECT NO: GPT.02 THIS WORK WAS DONE BY ME OR UNDER MY DIRECT SUPERVISION

> DRAWING NAME: PLANTING PLAN


EXPIRATION DATE: APR, 2015

DT DATE: NOV 2014 CHECKED: LP SCALE: AS NOTE

**REVISIONS:** 

DESCRIPTION DATE

DRAWING SHEET NO:

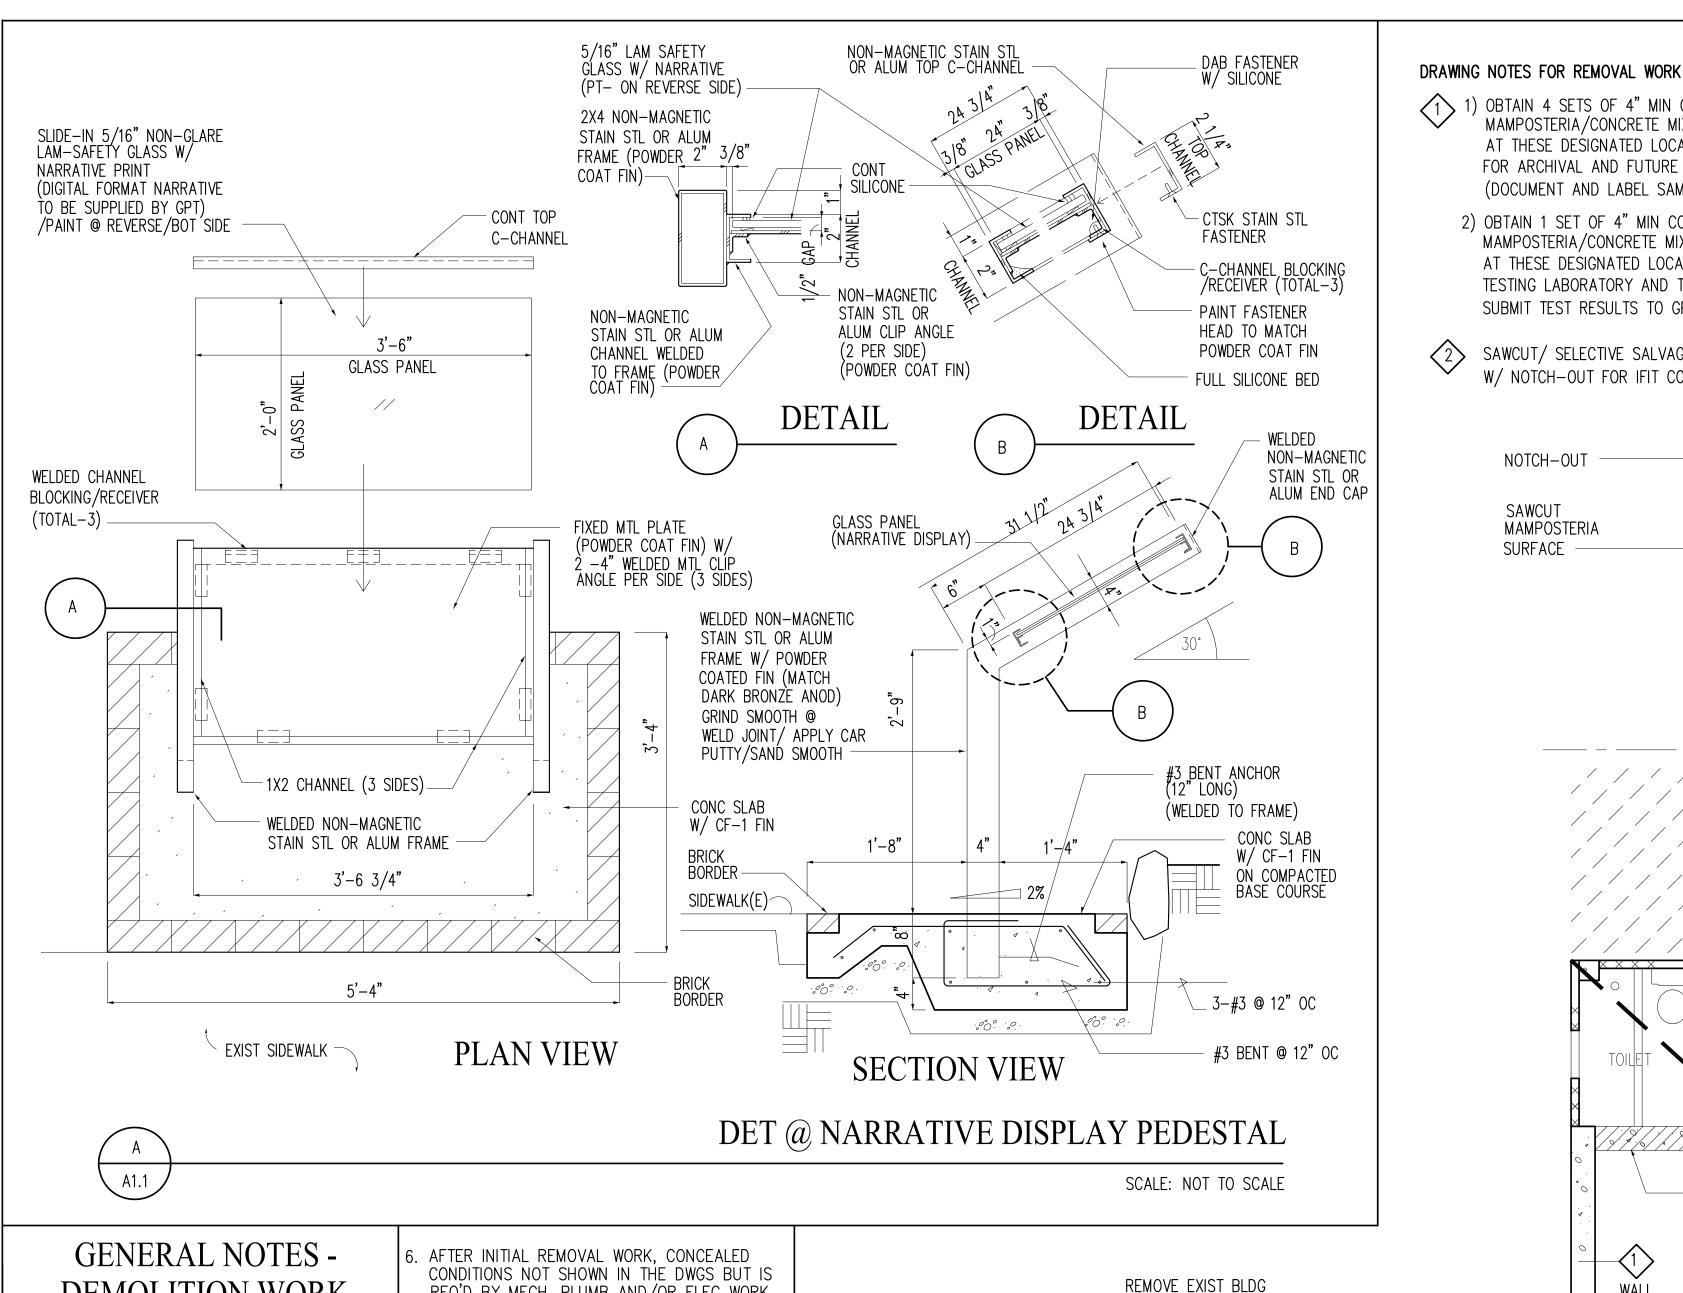

## **DEMOLITION WORK**

- DO NOT REMOVE ANY STRUCTURAL WALLS /COLUMNS/SLAB UNLESS APPROVED BY OWNER'S STRUCT ENG'R IN WRITING (OR DWG)
- DO NOT DAMAGE ANY EXIST WORK TO REMAIN. TAKE ALL PRECAUTIONS AND MEASURES TO PROTECT EXISTING WORK AT ALL TIMES.
- ANY DAMAGE TO EXIST WORK AND/OR OTHER ADJACENT CONDITION FOR ANY REASONS, SHALL BE REPAIRED AND/OR RESTORED TO ITS ORIGINAL CONDITION BY THE CONTRACTOR TO THE SATISFACTION OF THE OWNER. WHERE REPAIR AND/OR RESTORATION WORK IS NOT SATISFACTORY, THE CONTRACTOR SHALL REPLACE THE DAMAGED WORK WITH NEW WORK TO MATCH (OR BETTER) THE EXIST WORK.
- 3. PATCH AREAS THAT ARE EXPOSED AS A DIREC' OR INDIRECT RESULT OF DEMOLITION WORK, AND RESTORE/FINISH TO MATCH ADJACENT FINISHES.
- COORD ARCHITECTURAL DEMOLITION WORK W/ MECH / PLUMB / ELEC WORK. WHERE REMOVAL OF WALL, DOOR, CLG/SOFFIT, FIXT/DEVICE, ETC REQUIRE REROUTING OF EXIST PIPES, DUCTWORK, DEVICES, CONDUITS, WIRING, ETC (WHETHER OR NOT SHOWN IN THE DWGS) THE CONTRACTOR SHALL REMOVE, CAP AND REROUTE THE EXIST PIPES, DUCTWORK, CONDUITS, WIRING, FIXTURE, ETC AS PART OF THIS SCOPE OF WORK.
- COORD MECH/ PLUMB/ ELEC WORK W/ EXIST CONDITIONS. WHERE MECH/PLUMB/ELEC WORK REQUIRES THE REMOVAL AND/OR RELOCATION OF EXIST CONDITIONS, THE CONTRACTOR SHALL REMOVE AND/OR RELOCATE THE EXIST NON-STRUCT WORKS AND REPLACE IT WITH NEW WORK TO MATCH EXIST CONDITIONS.

- REQ'D BY MECH, PLUMB AND/OR ELEC WORK TO BE REMOVED (INCLUDING BUT NOT LIMITED TO EXIST CONCEAL STUB-OUTS, J-BOXES, CONCEAL OR ABANDONED UTILITIES AND OTHER APPERTUNANCE) SHALL BE REMOVED AND/OR CAPPED AS PART OF THIS SCOPE OF WORK.
- AFTER INITIAL REMOVAL WORK, CONCEALED CONDITIONS NOT SHOWN IN THE DWGS BUT IS REQ'D BY EXIST CONDITION OF THE WORK IN DEFECTIVE STATE (FOR EG. RUSTED STEEL CONC SPALLS AND CRACKS, PIPE LEAKS, ETC) SHALL BE REPAIRED TO THE SATISFACTION OF THE ARCHITECT.
- PROVIDE SEPARATION OF DEBRIS/ SOLID WASTE PER EPA REQUIREMENTS. PROVIDE DISPOSAL FEE AND DISPOSE ALL MATERIALS IN A LAWFUI MANNER, THAT DOES NOT INTERFER WITH EXIST OPERATIONS. DO NOT USE EXISTING SOLID WASTE DISPOSAL SYSTEM.
- EXIST WORK TO REMAIN SHALL BE CLEANED THOROUGHLY TO BE DUST-FREE, OIL-FREE AND DEFECT-FREE. TO THE FULLEST EXTENT POSSIBLE, SURFACE DEFECTS AND/OR DISCOLORATION SHALL BE REMOVED.
- ABANDONED UTILITIES SHALL BE REMOVED (EXCEPTION: UNDERGOUND UTILITIES @ SLAB ON GRADE, AND EMBEDDED UTILITIES INSIDE CONC/CMU WALLS). ABANDONED UTILITIES SHALL BE CAPPED.
- PROVIDE TEMPORARY CONSTRUCTION FENCE TO SEPARATE EXISTING FOOT TRAFFIC FLOW FROM THE CONSTRUCTION. THE TEMPORARY FENCE SHALL BE OPAQUE AND LOCATED WITH THE LANDLORD'S AND OWNER'S APPROVAL. PROVIDE TEMPORARY SHORING/BRACING/HARD FENCE TO PROTECT PERSONNÉL/PUBLIC FROM FALLING DEBRIS AND SUPPORT EXIST WORK. 2. DO NOT DISRUPT UTILITY SERVICES TO EXIST

OPERATIONS AND OR INTERUPT TRAFFIC FLOW.

(AND THICK UNDERGROWTH)

EXCEPTION: 1) EXIST FLOOR SLAB

2) EXIST WALLS AS NOTED

(REMOVE BOND BEAM(E) ABV

WALLS TO REMAIN. VERTICAL

OF THE WALL. DOCUMENT VERT

REBAR LOCATIONS/QNTY FOR

PURPOSES OF CONNECTING TO

ANODE PROTECTION SYSTEM -

REBARS(E) SHALL BE CUT TO ACHIEVE 2" REBAR

PROJECTION AT THE TOP

IN ITS ENTIRETY UNLESS


NOTED OTHERWISE

#### MAMPOSTERIA/CONCRETE MIX FROM EXISTING STRUCTURE (PRIOR TO DEMOLITION) AT THESE DESIGNATED LOCATIONS. SURRENDER TO GPT REPRESENTATIVE FOR ARCHIVAL AND FUTURE TESTING /ANALYSIS (TOTAL CYLINDER SAMPLES =16) (DOCUMENT AND LABEL SAMPLES TO CORRESPOND W/ LOCATION) 2) OBTAIN 1 SET OF 4" MIN CORE CYLINDER SAMPLES OF FINE

MAMPOSTERIA/CONCRETE MIX FROM EXISTING STRUCTURE (PRIOR TO DEMOLITION) AT THESE DESIGNATED LOCATIONS. SURRENDER TO CONTRACTOR'S INDEPENDENT TESTING LABORATORY AND TEST FOR COMPRESSIVE STRENGTH SUBMIT TEST RESULTS TO GPT REP AND ARCHITECT OF RECORD.

SAWCUT/ SELECTIVE SALVAGE FINE MAMPOSTERIA/CONC MIX W/ NOTCH-OUT FOR IFIT COLUMNS

1) OBTAIN 4 SETS OF 4" MIN CORE CYLINDER SAMPLES OF FINE

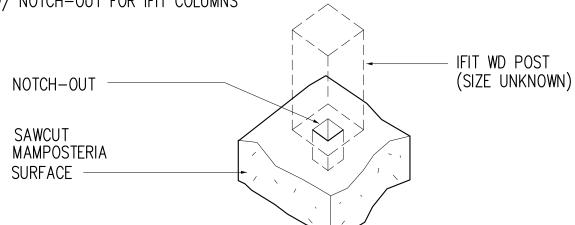


#### SCHEDULE OF ITEMS TO BE SALVAGED/ REMOVED OR DISASSEMBLED


ITEM NO.	DESCRIPTION	QNTY	REMARKS
1	FINE MAMPOSTERIA/CONC MIX SAMPLE	4 SETS	LABEL SAMPLES AND TRANSMIT 1 SET TO SHPO VIA GPT REP
2	MAMPOSTERIA CONC W/ POST NOTCH-OUTS	2 SETS	LABEL SAMPLES AND TRANSMIT 1 SET TO SHPO VIA GPT REP

#### LEGEND

DESCRIPTION


WALL TO REMAIN

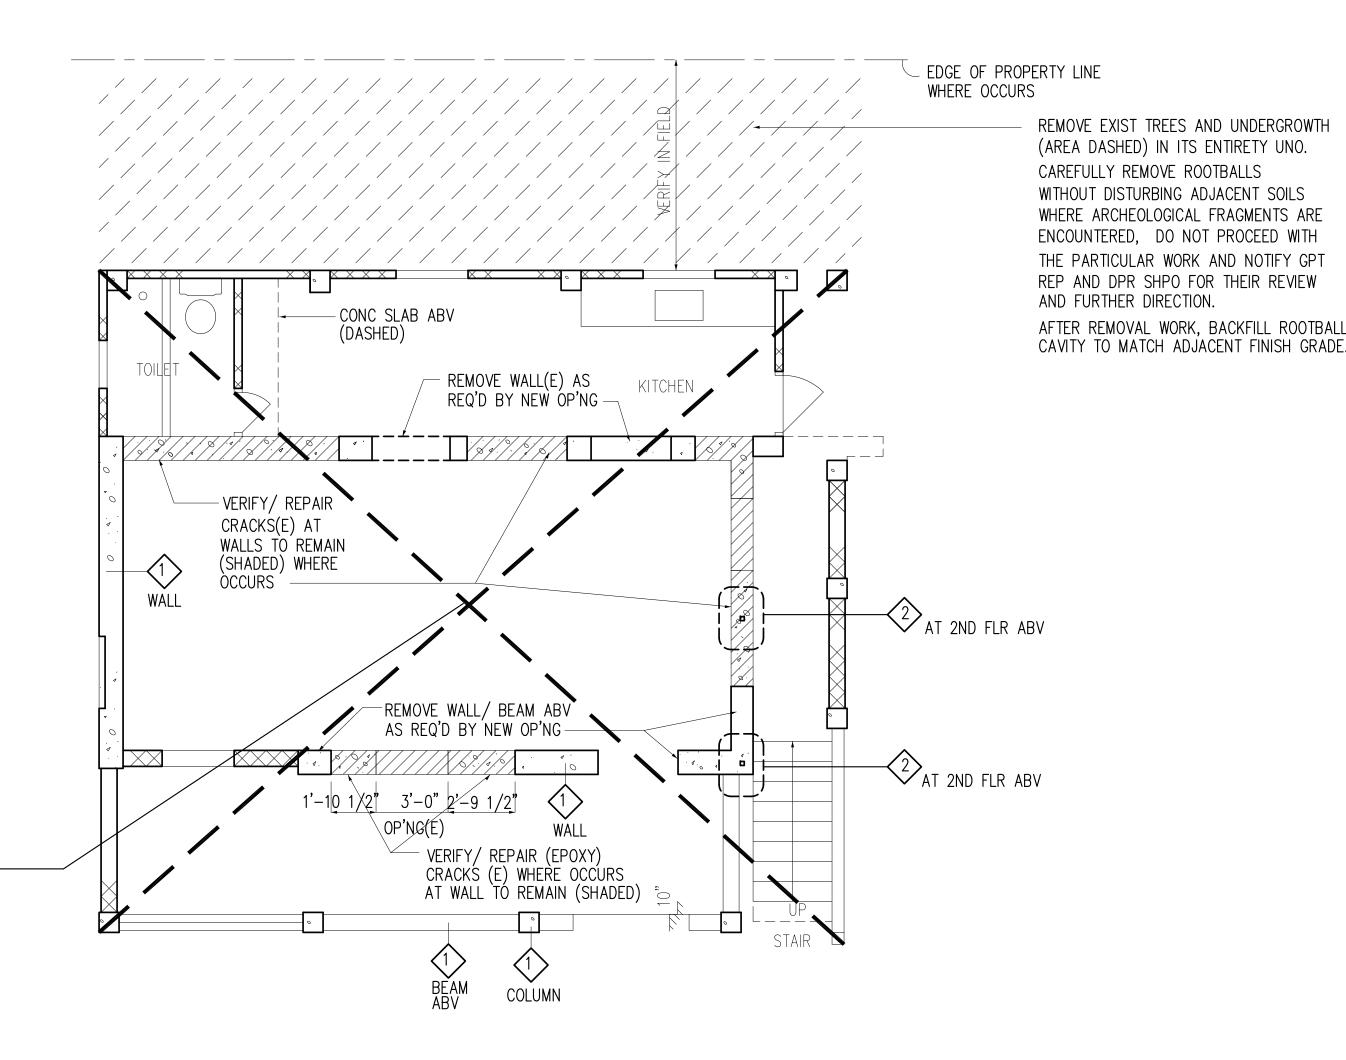


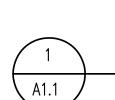

ARCHITECTURAL DEMO PLAN @ GROUND LEVEL

SCALE: 1/4" = 1'-0"

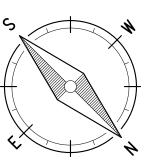

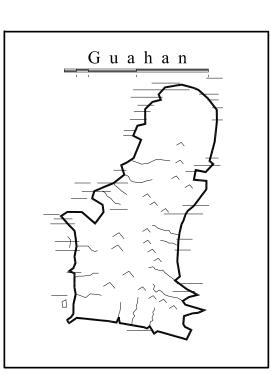

**GUAM PRESERVATION** TRUST

INANGOKKON INADAHI GUAHAN P.O. BOX 3036, HAGATNA, GUAM 96932

PROJECT TITLE:

RECONSTRUCTION ANTONIA C. **CHARGUALAF** HOUSE,

HISTORIC DISTRICT OF INARAJAN. INARAJAN, GUAM

DPR TRACKING NO: RC 2014 0373

DESIGN CONSULTANT: Provido · Tan · Jones architects inc.



TEL: 671 646 1361 FAX: 671 646 2767

PTJA PROJECT NO: GPT.02 THIS WORK WAS DONE BY ME OR UNDER MY DIRECT SUPERVISION

EXPIRATION DATE: APR, 2015

DRAWING NAME: GROUND LEVEL DEMO PLAN

DT DATE: NOV 210 CHECKED: LP SCALE: AS NOTE

**REVISIONS:** 


DESCRIPTION


DRAWING SHEET NO:

#### DRAWING NOTES FOR REMOVAL WORK

- 1) OBTAIN 4 SETS OF 4" MIN CORE CYLINDER SAMPLES OF FINE MAMPOSTERIA/CONCRETE MIX FROM EXISTING STRUCTURE (PRIOR TO DEMOLITION) AT THESE DESIGNATED LOCATIONS. SURRENDER TO GPT REPRESENTATIVE FOR ARCHIVAL AND FUTURE TESTING /ANALYSIS (TOTAL CYLINDER SAMPLES =16) (DOCUMENT AND LABEL SAMPLES TO CORRESPOND W/ LOCATION)
  - 2) OBTAIN 1 SET OF 4" MIN CORE CYLINDER SAMPLES OF FINE MAMPOSTERIA/CONCRETE MIX FROM EXISTING STRUCTURE (PRIOR TO DEMOLITION) AT THESE DESIGNATED LOCATIONS. SURRENDER TO CONTRACTOR'S INDEPENDENT TESTING LABORATORY AND TEST FOR COMPRESSIVE STRENGTH SUBMIT TEST RESULTS TO GPT REP AND ARCHITECT OF RECORD.

SAWCUT/ SELECTIVE SALVAGE FINE MAMPOSTERIA/CONC MIX

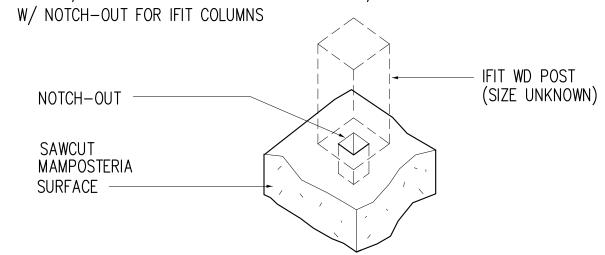


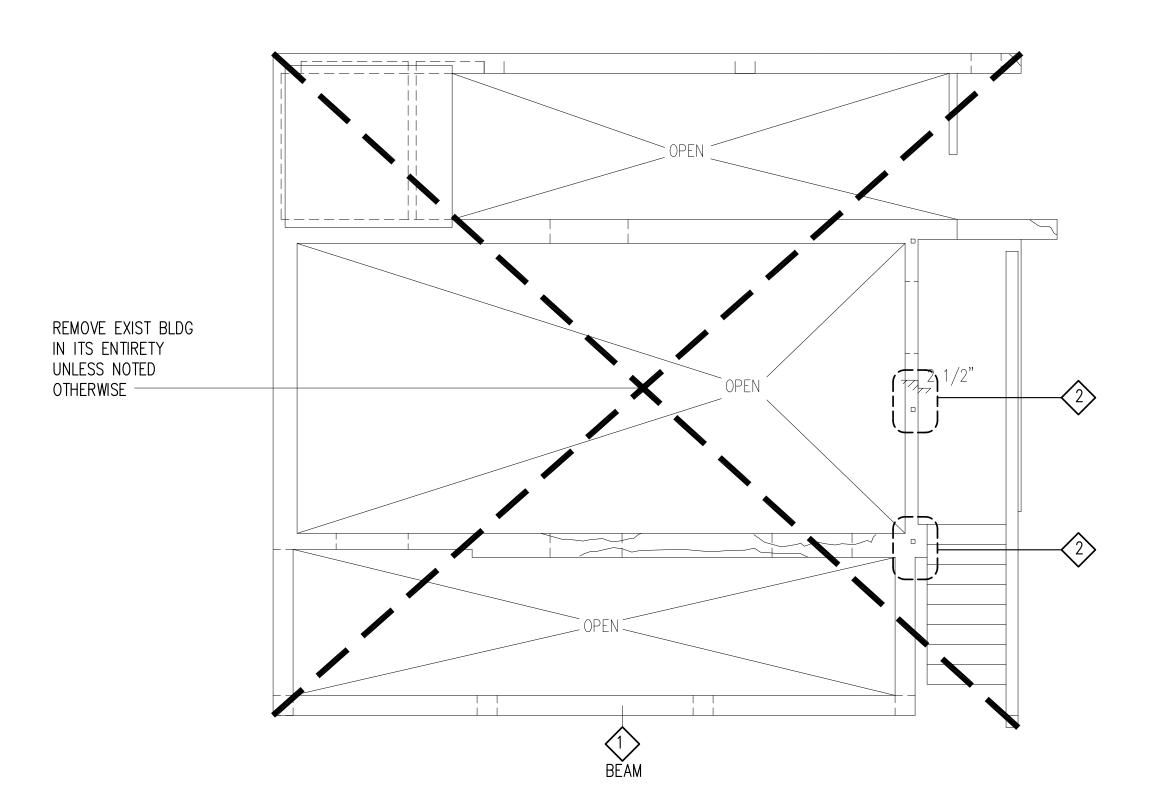



ARCHITECTURAL DEMO PLAN @ UPPER LEVEL

SCALE: 1/4" = 1'-0"

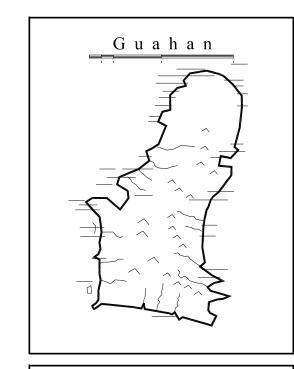

GUAM PRESERVATION TRUST

INANGOKKON INADAHI GUAHAN P.O. BOX 3036, HAGATNA, GUAM 96932

PROJECT TITLE:

RECONSTRUCTION
of
ANTONIA C.
CHARGUALAF
HOUSE,


HISTORIC DISTRICT OF INARAJAN, INARAJAN, GUAM

DPR TRACKING NO: RC 2014 0373

DESIGN CONSULTANT:

Provido Tan Jones

architects inc.

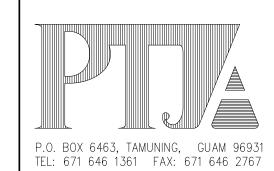

PTJA PROJECT NO: GPT.02

THIS WORK WAS DONE BY ME OR UNDER MY DIRECT SUPERVISION EXPIRATION DATE: APR, 2015


DRAWING NAME:

UPPER LEVEL DEMO PLAN

DRAWN: DT DATE: NOV 2104


CHECKED: LP SCALE: AS NOTED


**REVISIONS:** 

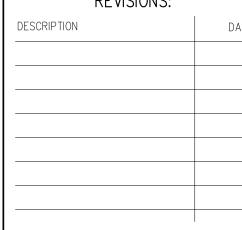

DRAWING SHEET NO:

A1.2

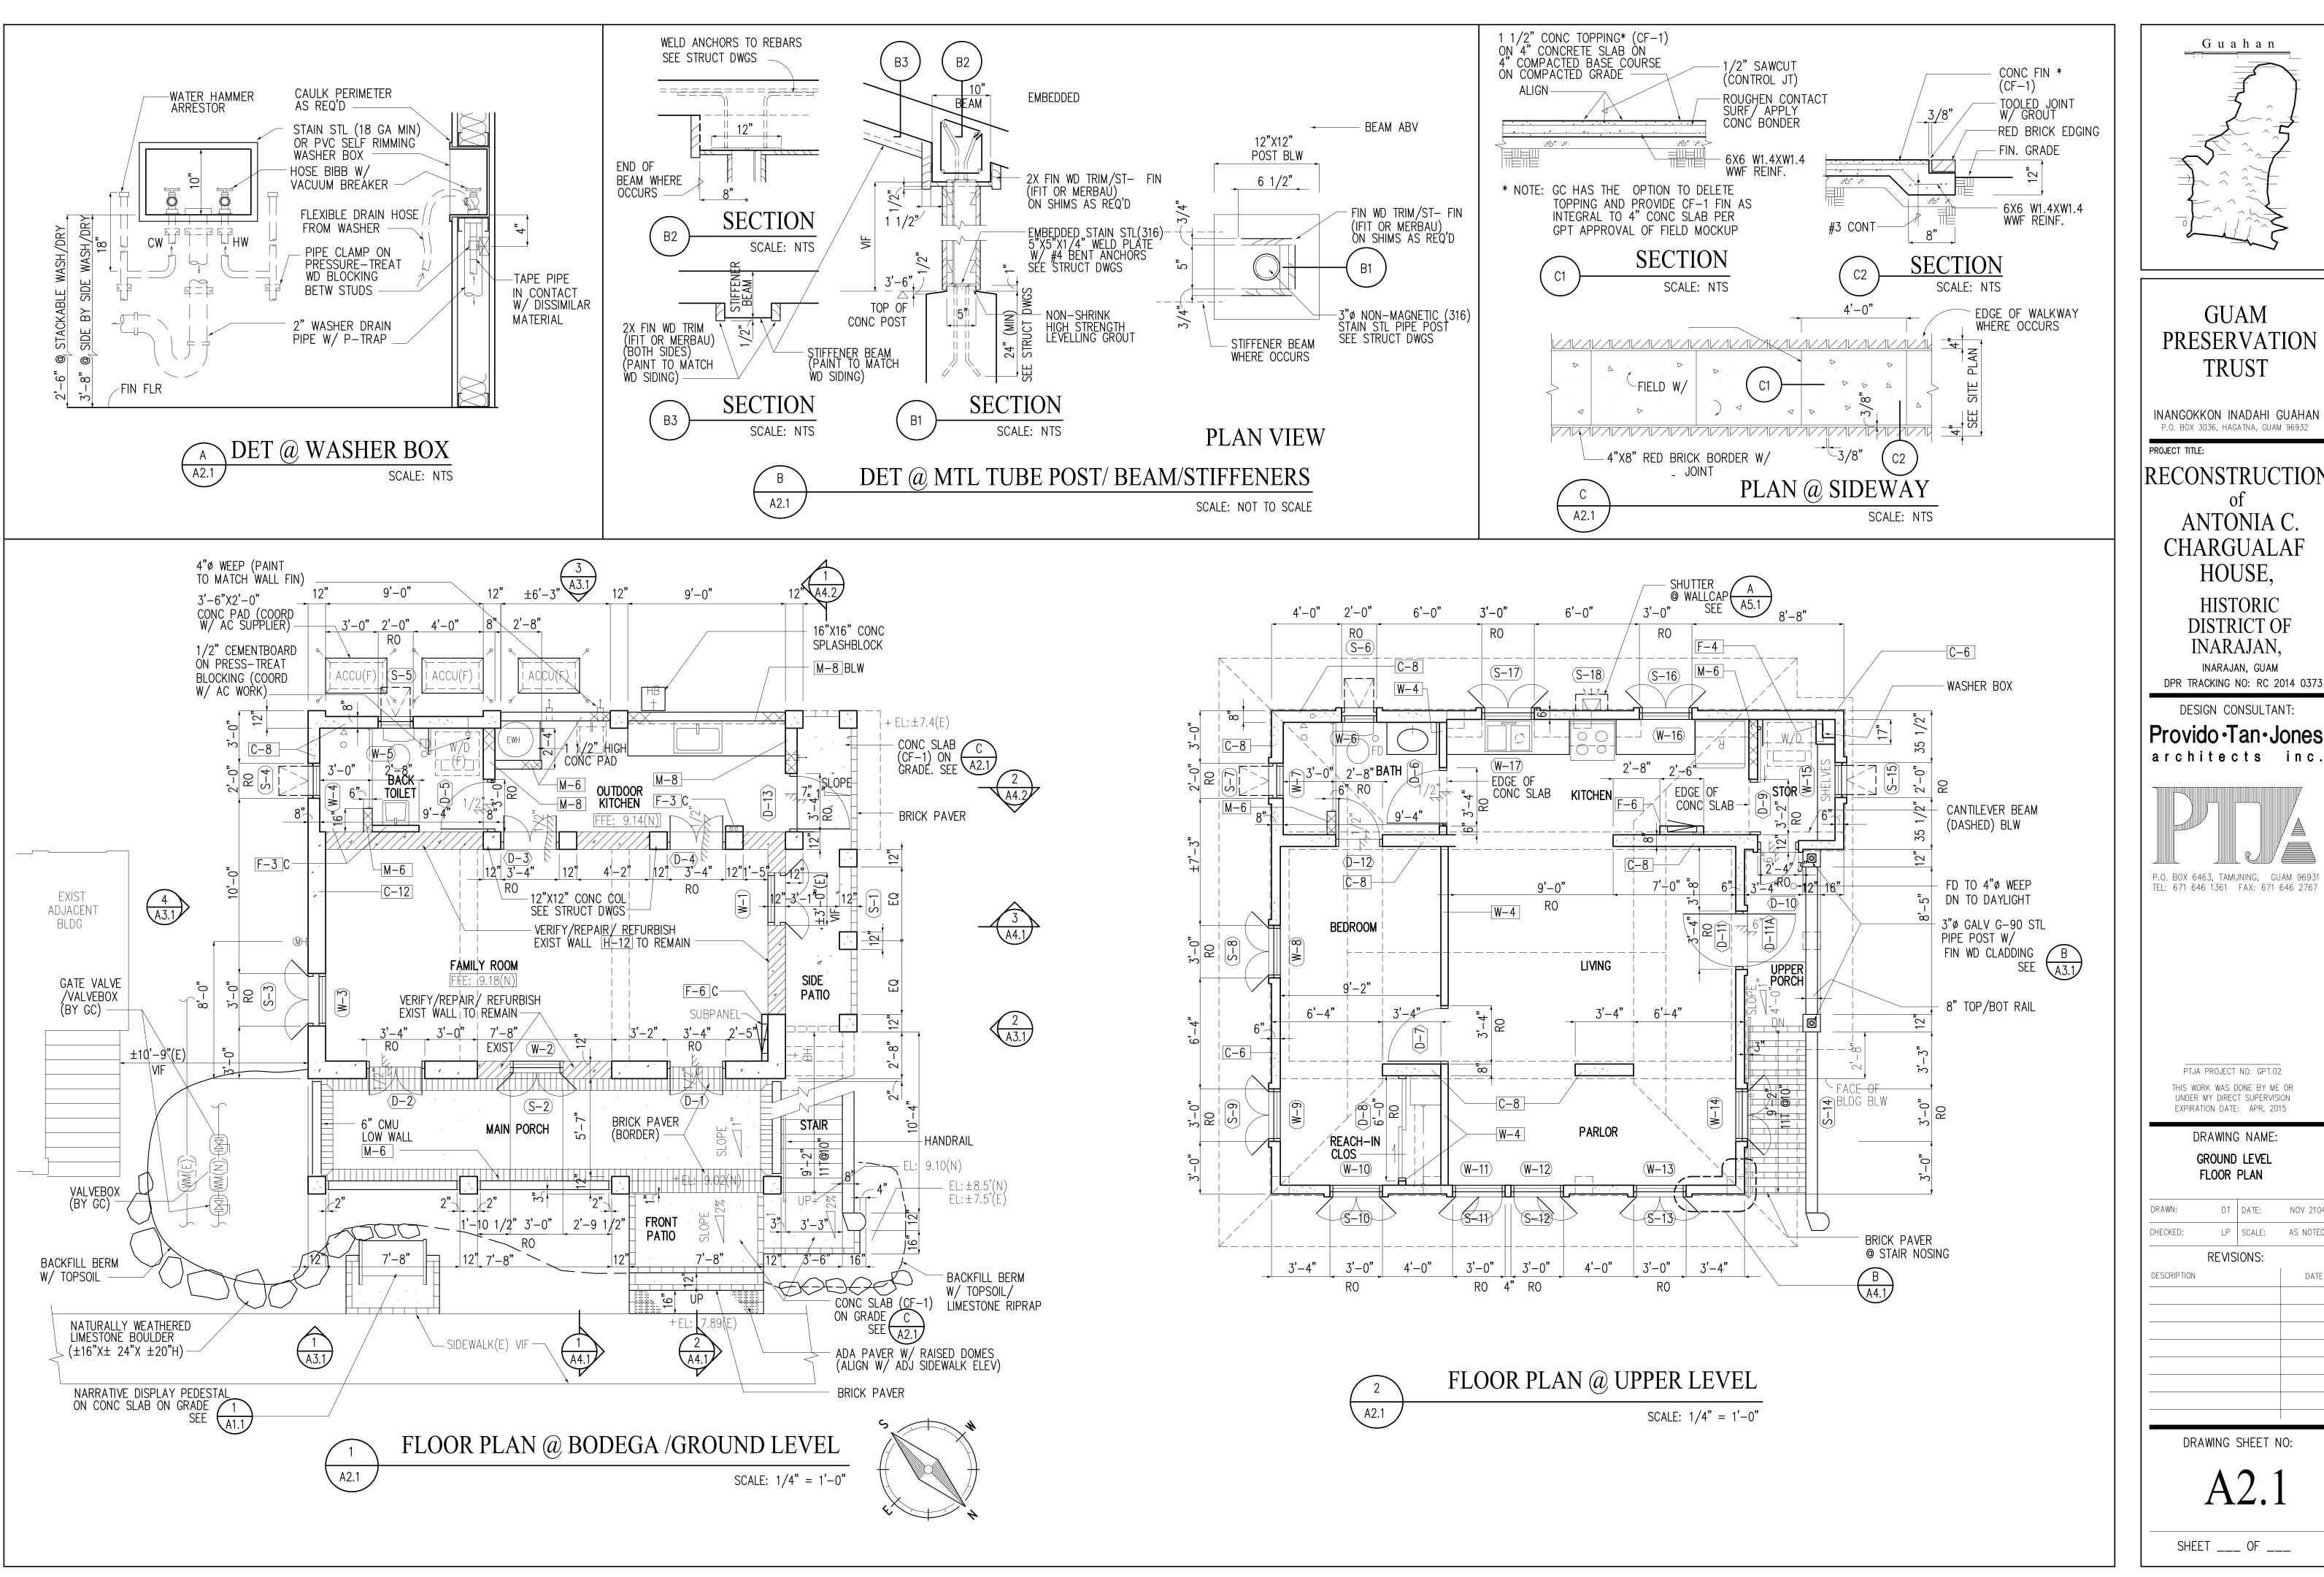

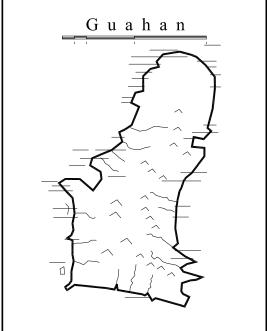

INANGOKKON INADAHI GUAHAN P.O. BOX 3036, HAGATNA, GUAM 96932


PROJECT TITLE: RECONSTRUCTION

ANTONIA C. **CHARGUALAF** HOUSE,

HISTORIC DISTRICT OF INARAJAN,

INARAJAN, GUAM DPR TRACKING NO: RC 2014 0373

DESIGN CONSULTANT: Provido · Tan · Jones

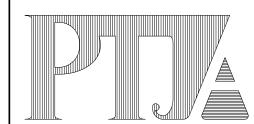

P.O. BOX 6463, TAMUNING, GUAM 96931 TEL: 671 646 1361 FAX: 671 646 2767

PTJA PROJECT NO: GPT.02 THIS WORK WAS DONE BY ME OR UNDER MY DIRECT SUPERVISION EXPIRATION DATE: APR, 2015


> DRAWING NAME: GROUND LEVEL FLOOR PLAN


DT DATE: CHECKED: LP SCALE: AS NOTE

**REVISIONS:** 

DRAWING SHEET NO:

A2.1

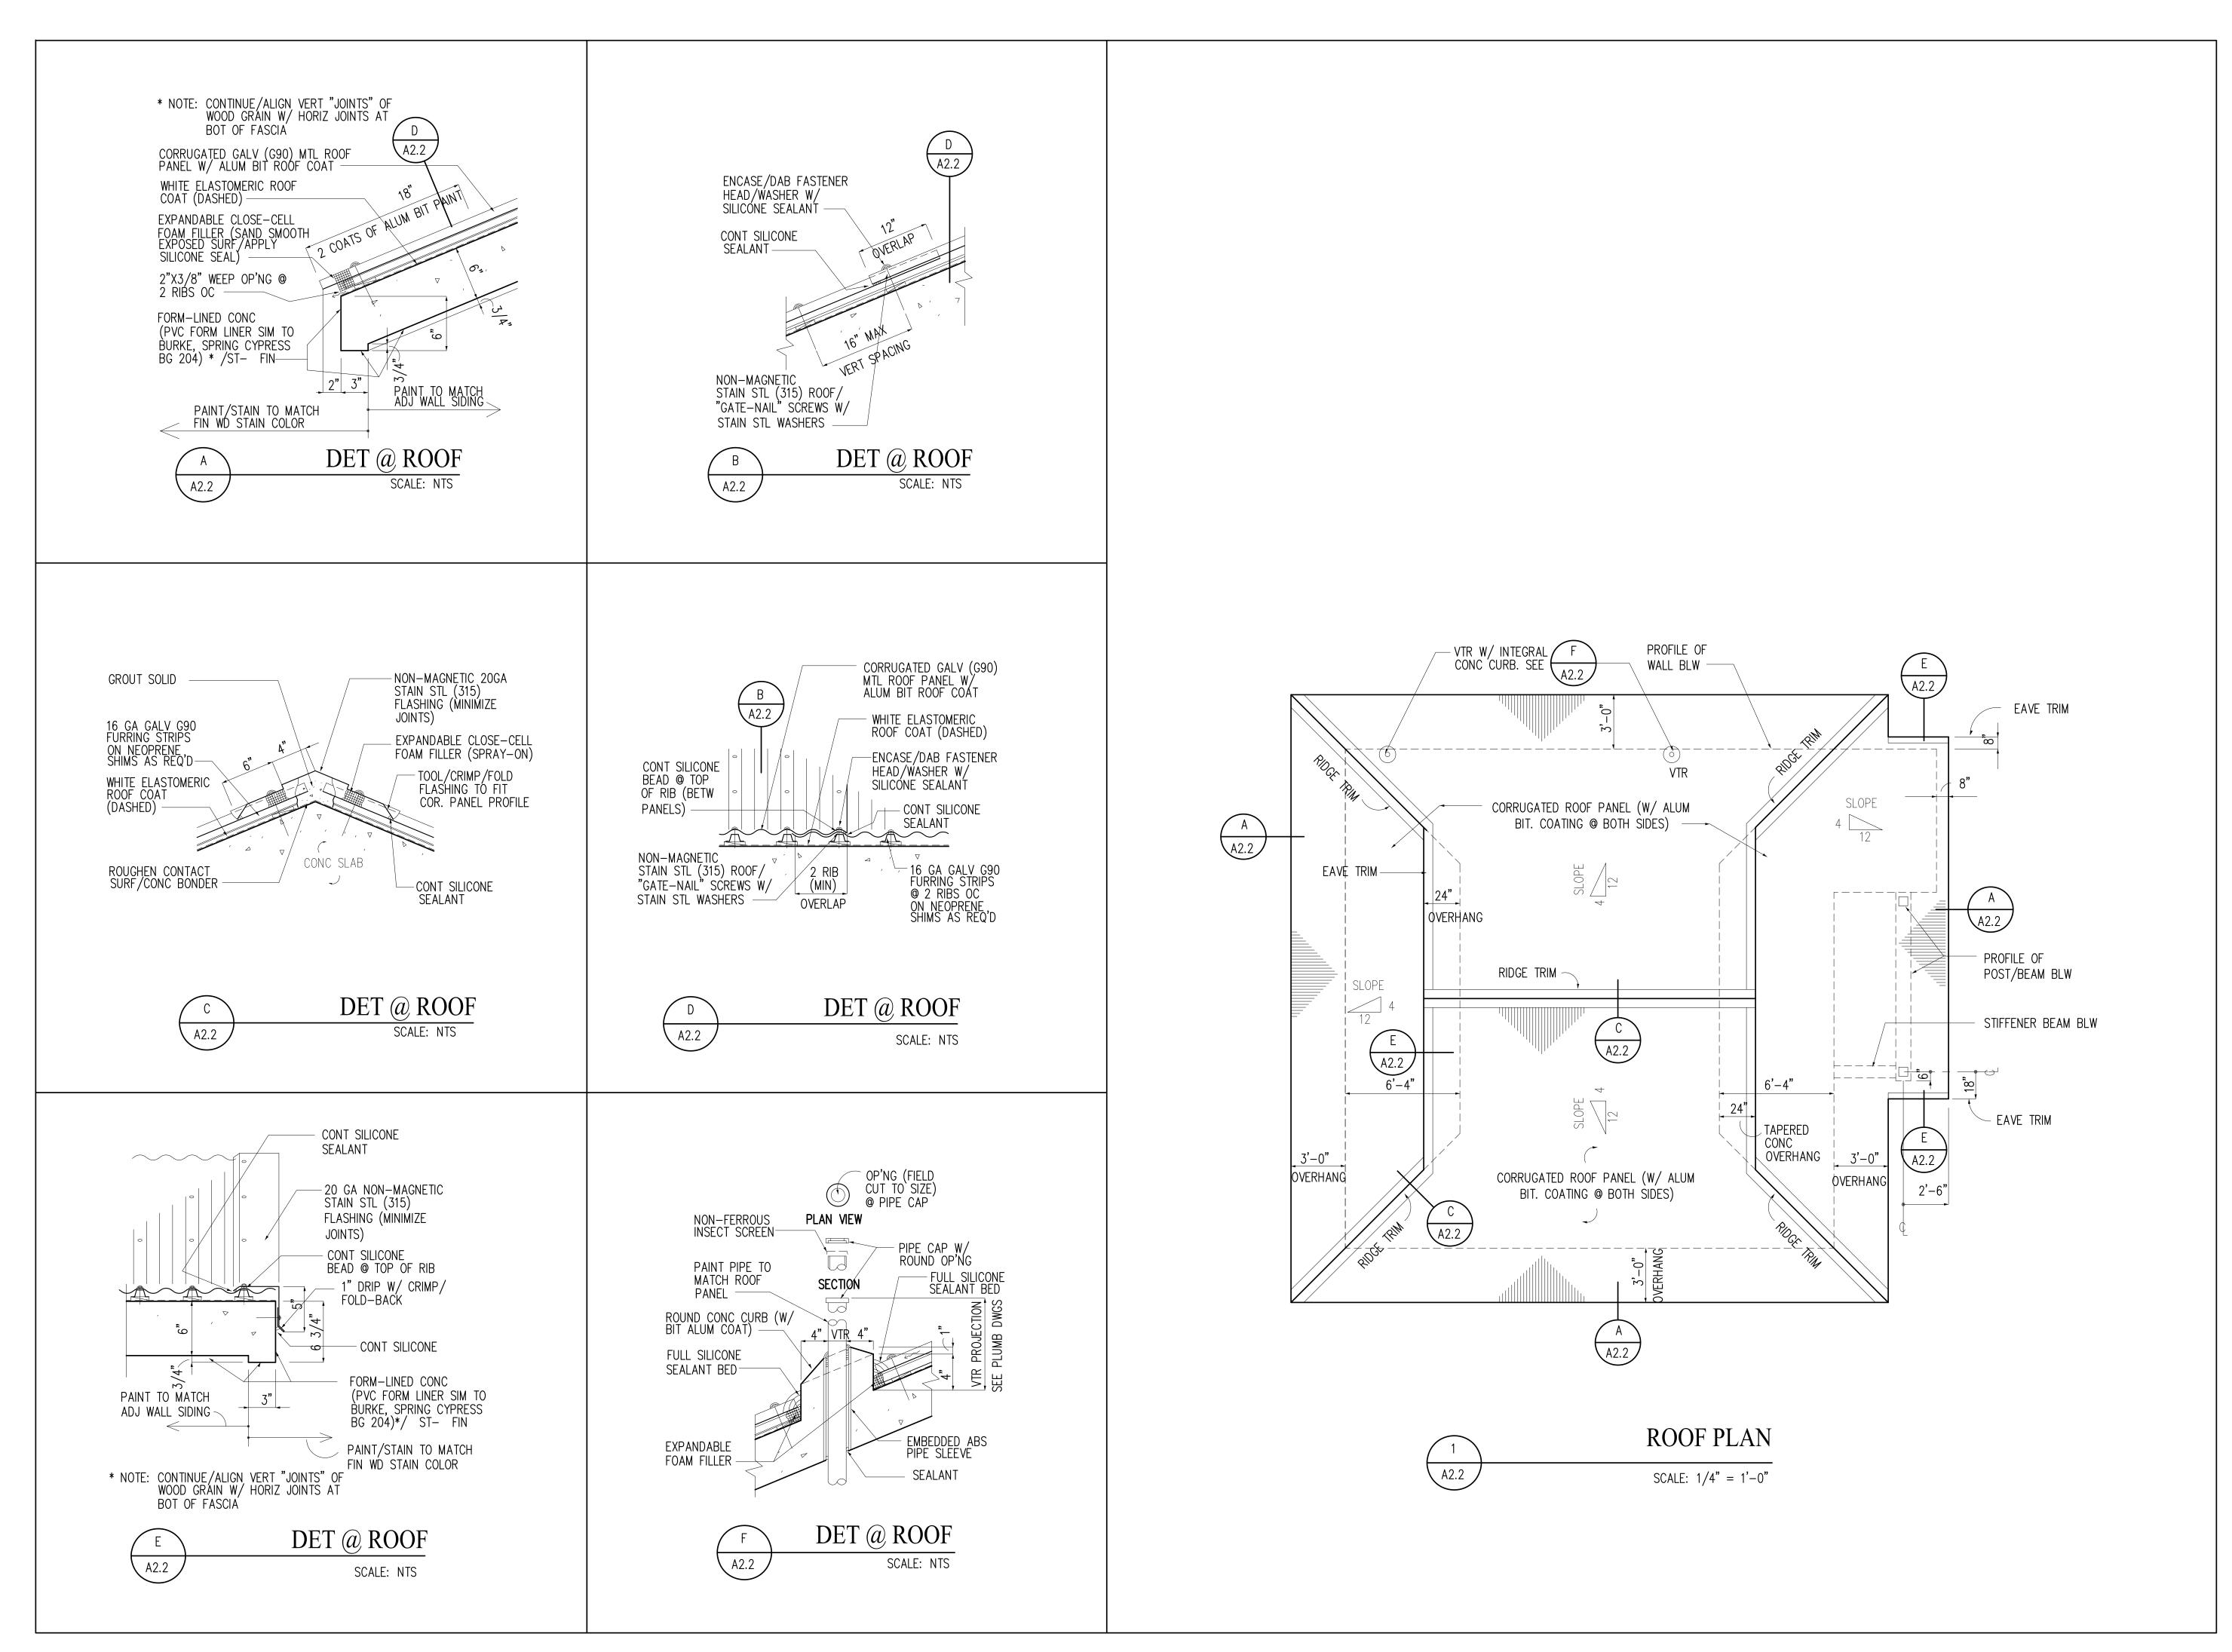

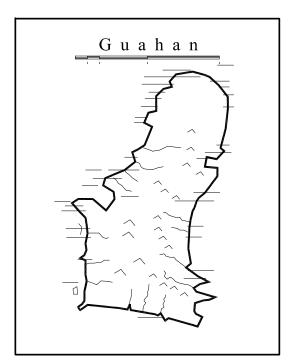

INANGOKKON INADAHI GUAHAN P.O. BOX 3036, HAGATNA, GUAM 96932

PROJECT TITLE:

RECONSTRUCTION
of
ANTONIA C.
CHARGUALAF
HOUSE,

HISTORIC DISTRICT OF INARAJAN,

INARAJAN, GUAM
DPR TRACKING NO: RC 2014 0373

Provido Tan Jones
architects inc.



PTJA PROJECT NO: GPT.02

THIS WORK WAS DONE BY ME OR UNDER MY DIRECT SUPERVISION EXPIRATION DATE: APR, 2015

DRAWING NAME:

UPPER LEVEL

REFEEOORCEGANLAN

DRAWN: DT DATE: NOV 2104


CHECKED: LP SCALE: AS NOTED


REVISIONS:

DESCRIPTION DATE

DRAWING SHEET NO:

A2.2

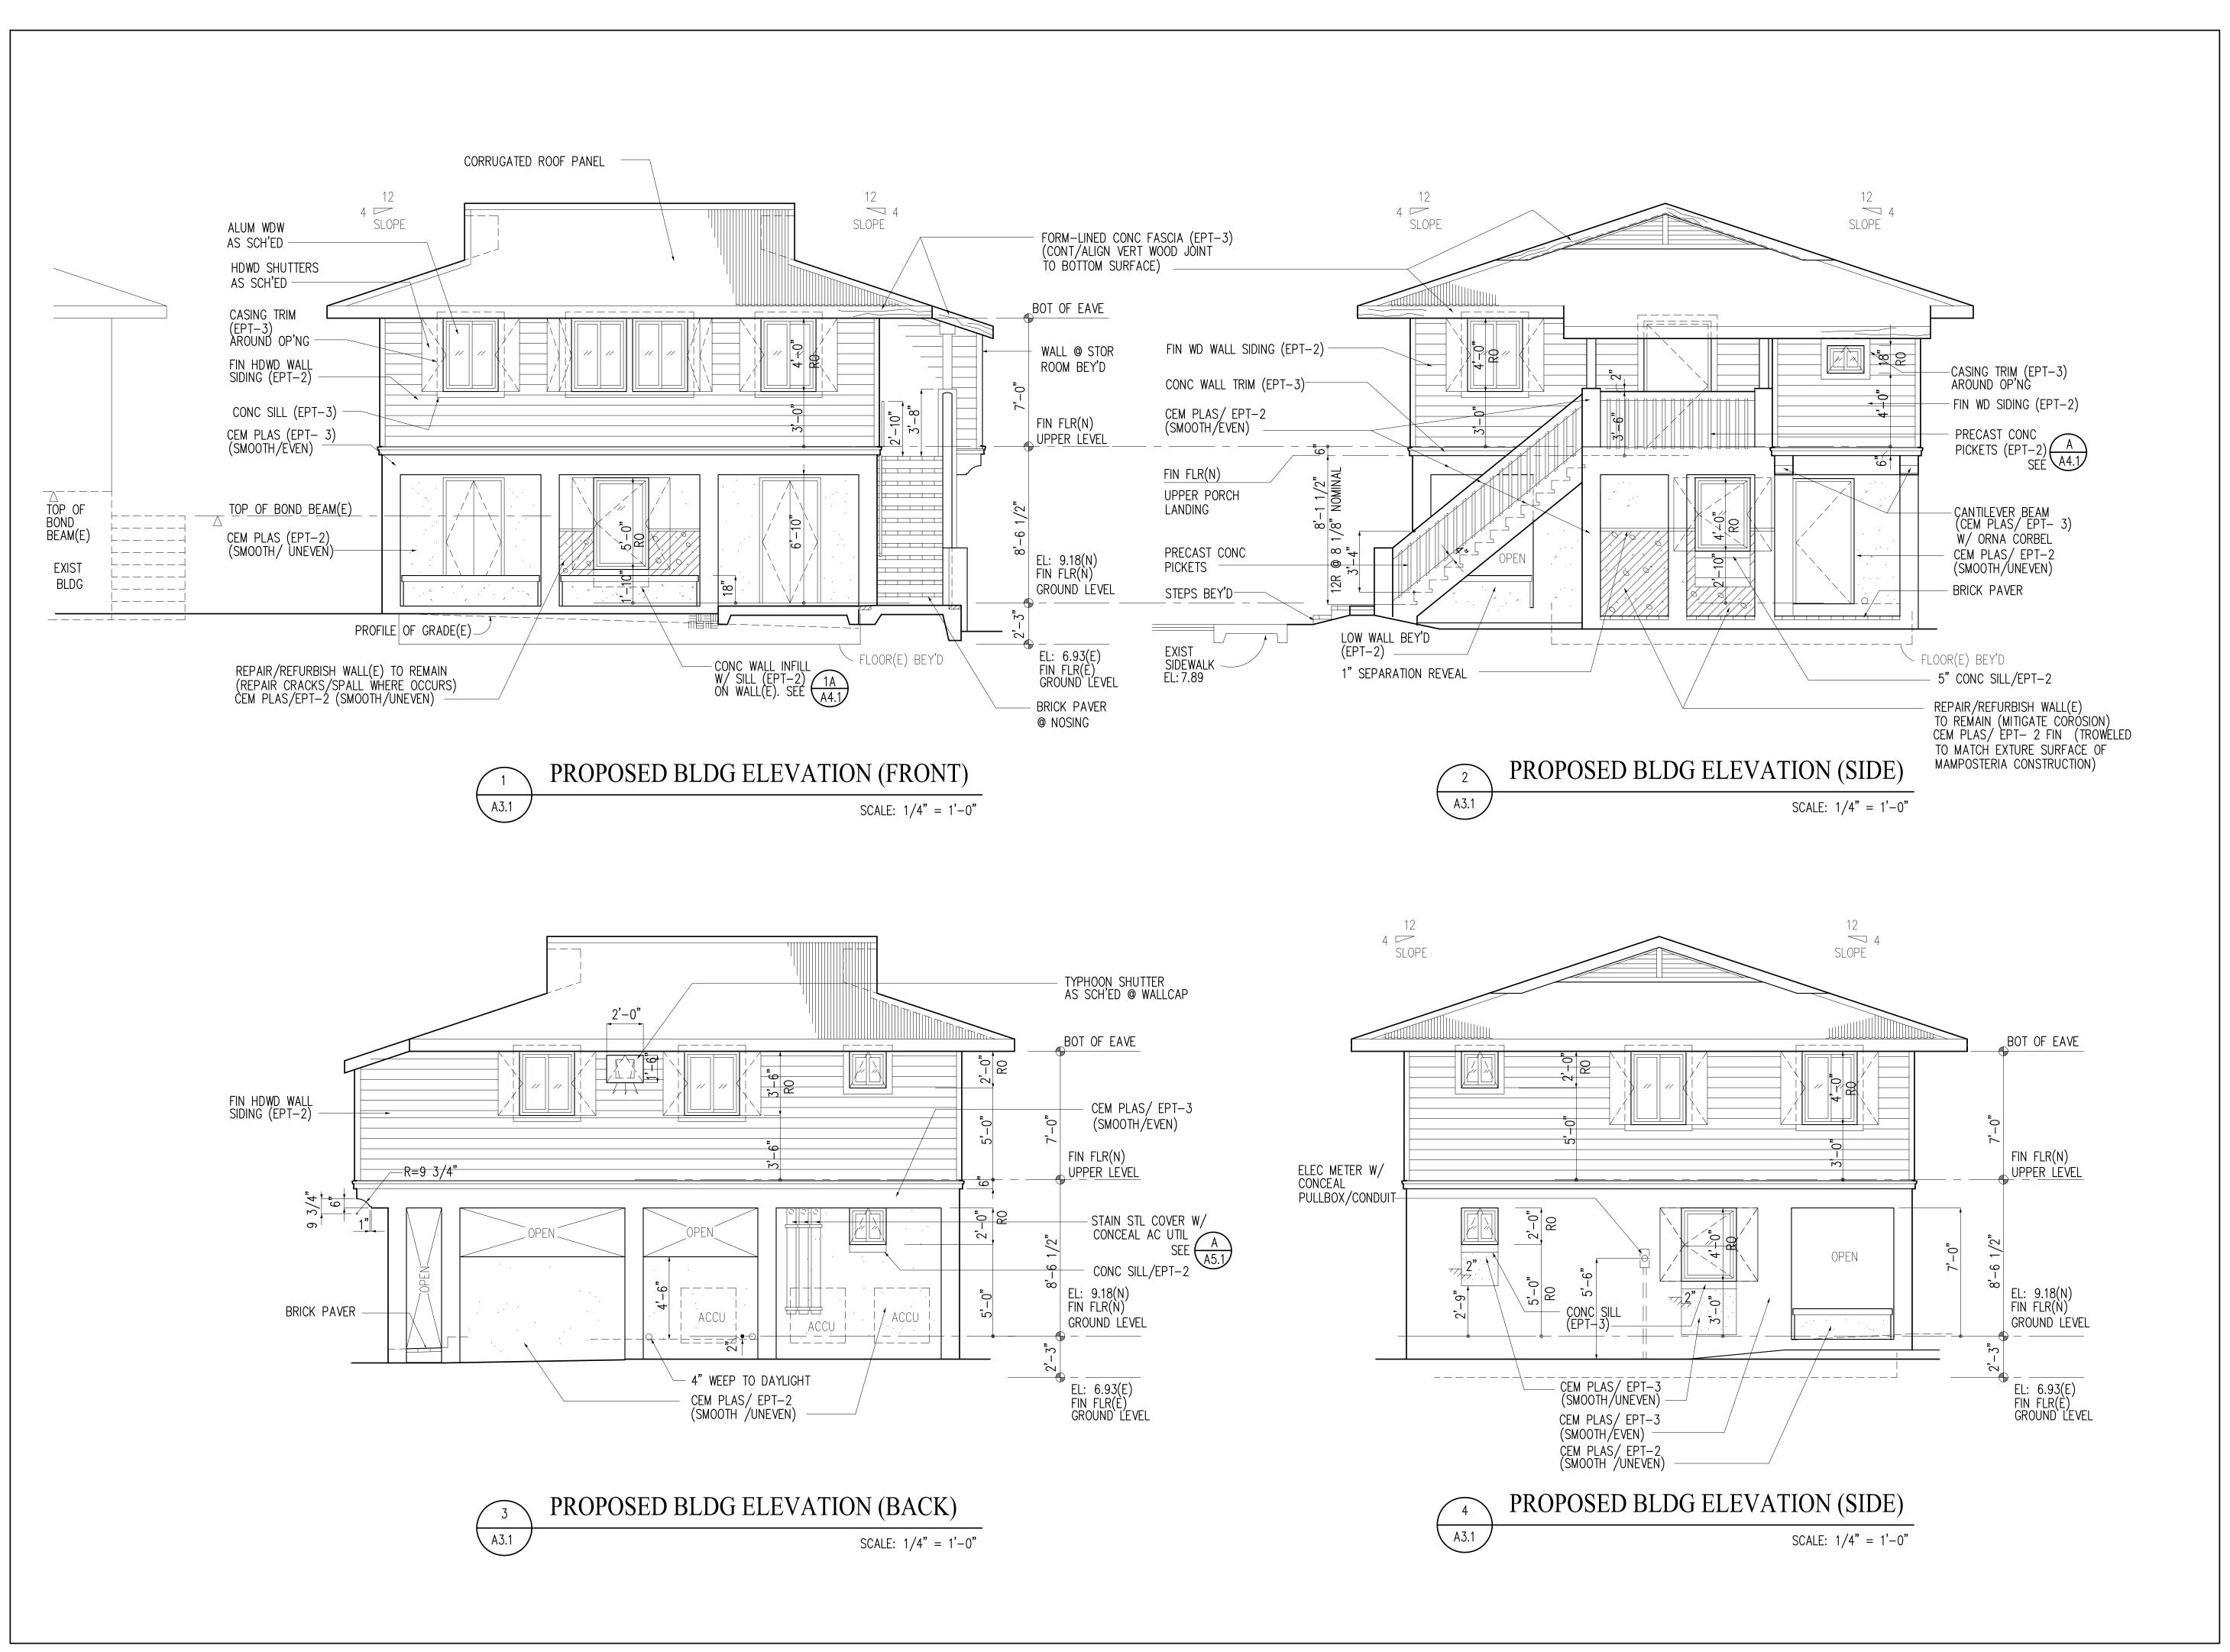

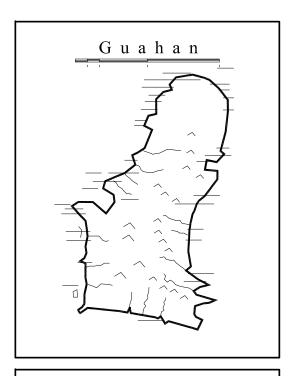

INANGOKKON INADAHI GUAHAN P.O. BOX 3036, HAGATNA, GUAM 96932

PROJECT TITLE:

RECONSTRUCTION

ANTONIA C. CHARGUALAF HOUSE,

DISTRICT OF INARAJAN,
INARAJAN, GUAM

HISTORIC

DPR TRACKING NO: RC 2014 0373

DESIGN CONSULTANT:

Provido Tan Jones

architects inc.



P.O. BOX 6463, TAMUNING, GUAM 96931 TEL: 671 646 1361 FAX: 671 646 2767

PTJA PROJECT NO: GPT.02

THIS WORK WAS DONE BY ME OR UNDER MY DIRECT SUPERVISION EXPIRATION DATE: APR, 2015


BLDG ELEVATION

DRAWING NAME:

DRAWN: DT DATE: NOV 2104


CHECKED: LP SCALE: AS NOTED


REVISIONS:

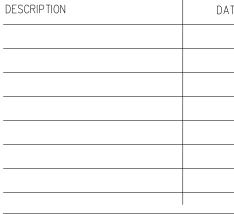

DRAWING SHEET NO:

A3.1

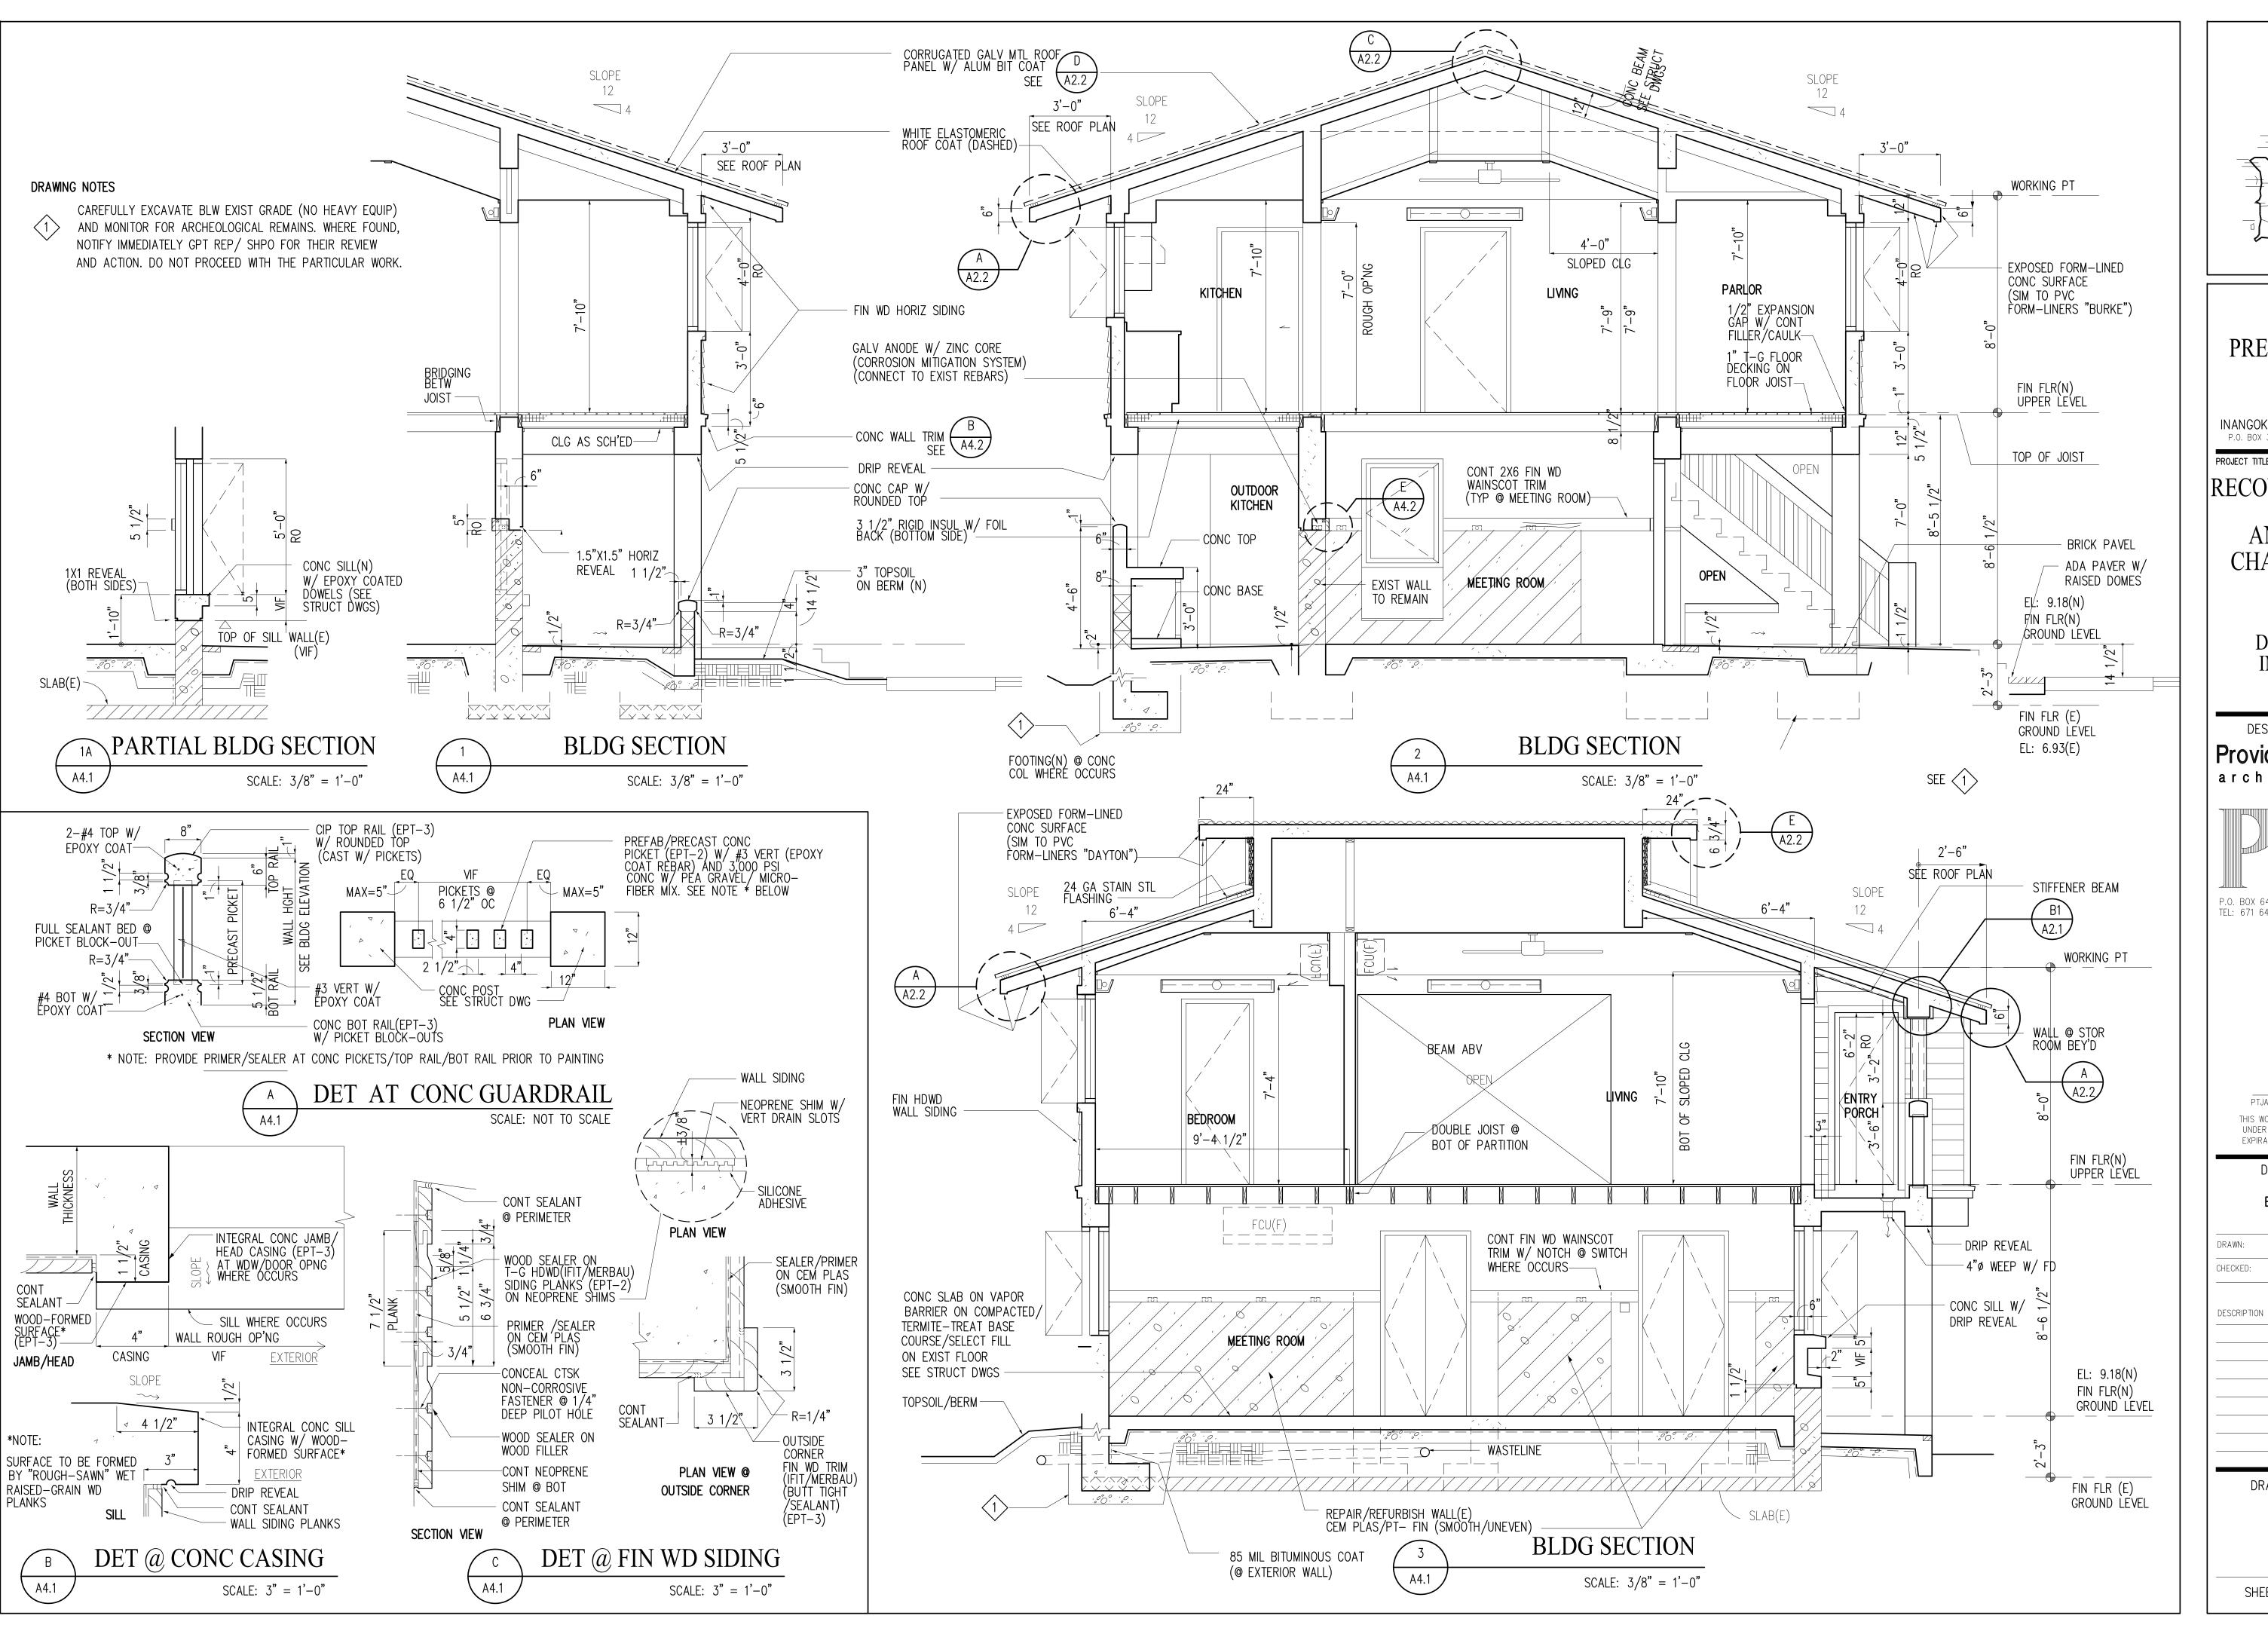

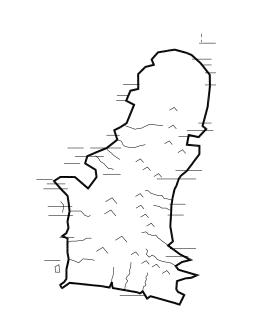

## GUAM **PRESERVATION** TRUST INANGOKKON INADAHI GUAHAN P.O. BOX 3036, HAGATNA, GUAM 96932 PROJECT TITLE: RECONSTRUCTION ANTONIA C. **CHARGUALAF** HOUSE, HISTORIC DISTRICT OF INARAJAN. INARAJAN, GUAM DESIGN CONSULTANT: Provido · Tan · Jones architects inc. P.O. BOX 6463, TAMUNING, GUAM 96931 TEL: 671 646 1361 FAX: 671 646 2767

PTJA PROJECT NO: GPT.02

THIS WORK WAS DONE BY ME OR UNDER MY DIRECT SUPERVISION EXPIRATION DATE: APR, 2015

DRAWING NAME:

BLDG SECTIONS

**REVISIONS:** 


DRAWING SHEET NO:

A4.1

SHEET \_\_\_ OF \_\_\_

DT DATE: NOV 2104

LP SCALE: AS NOTE

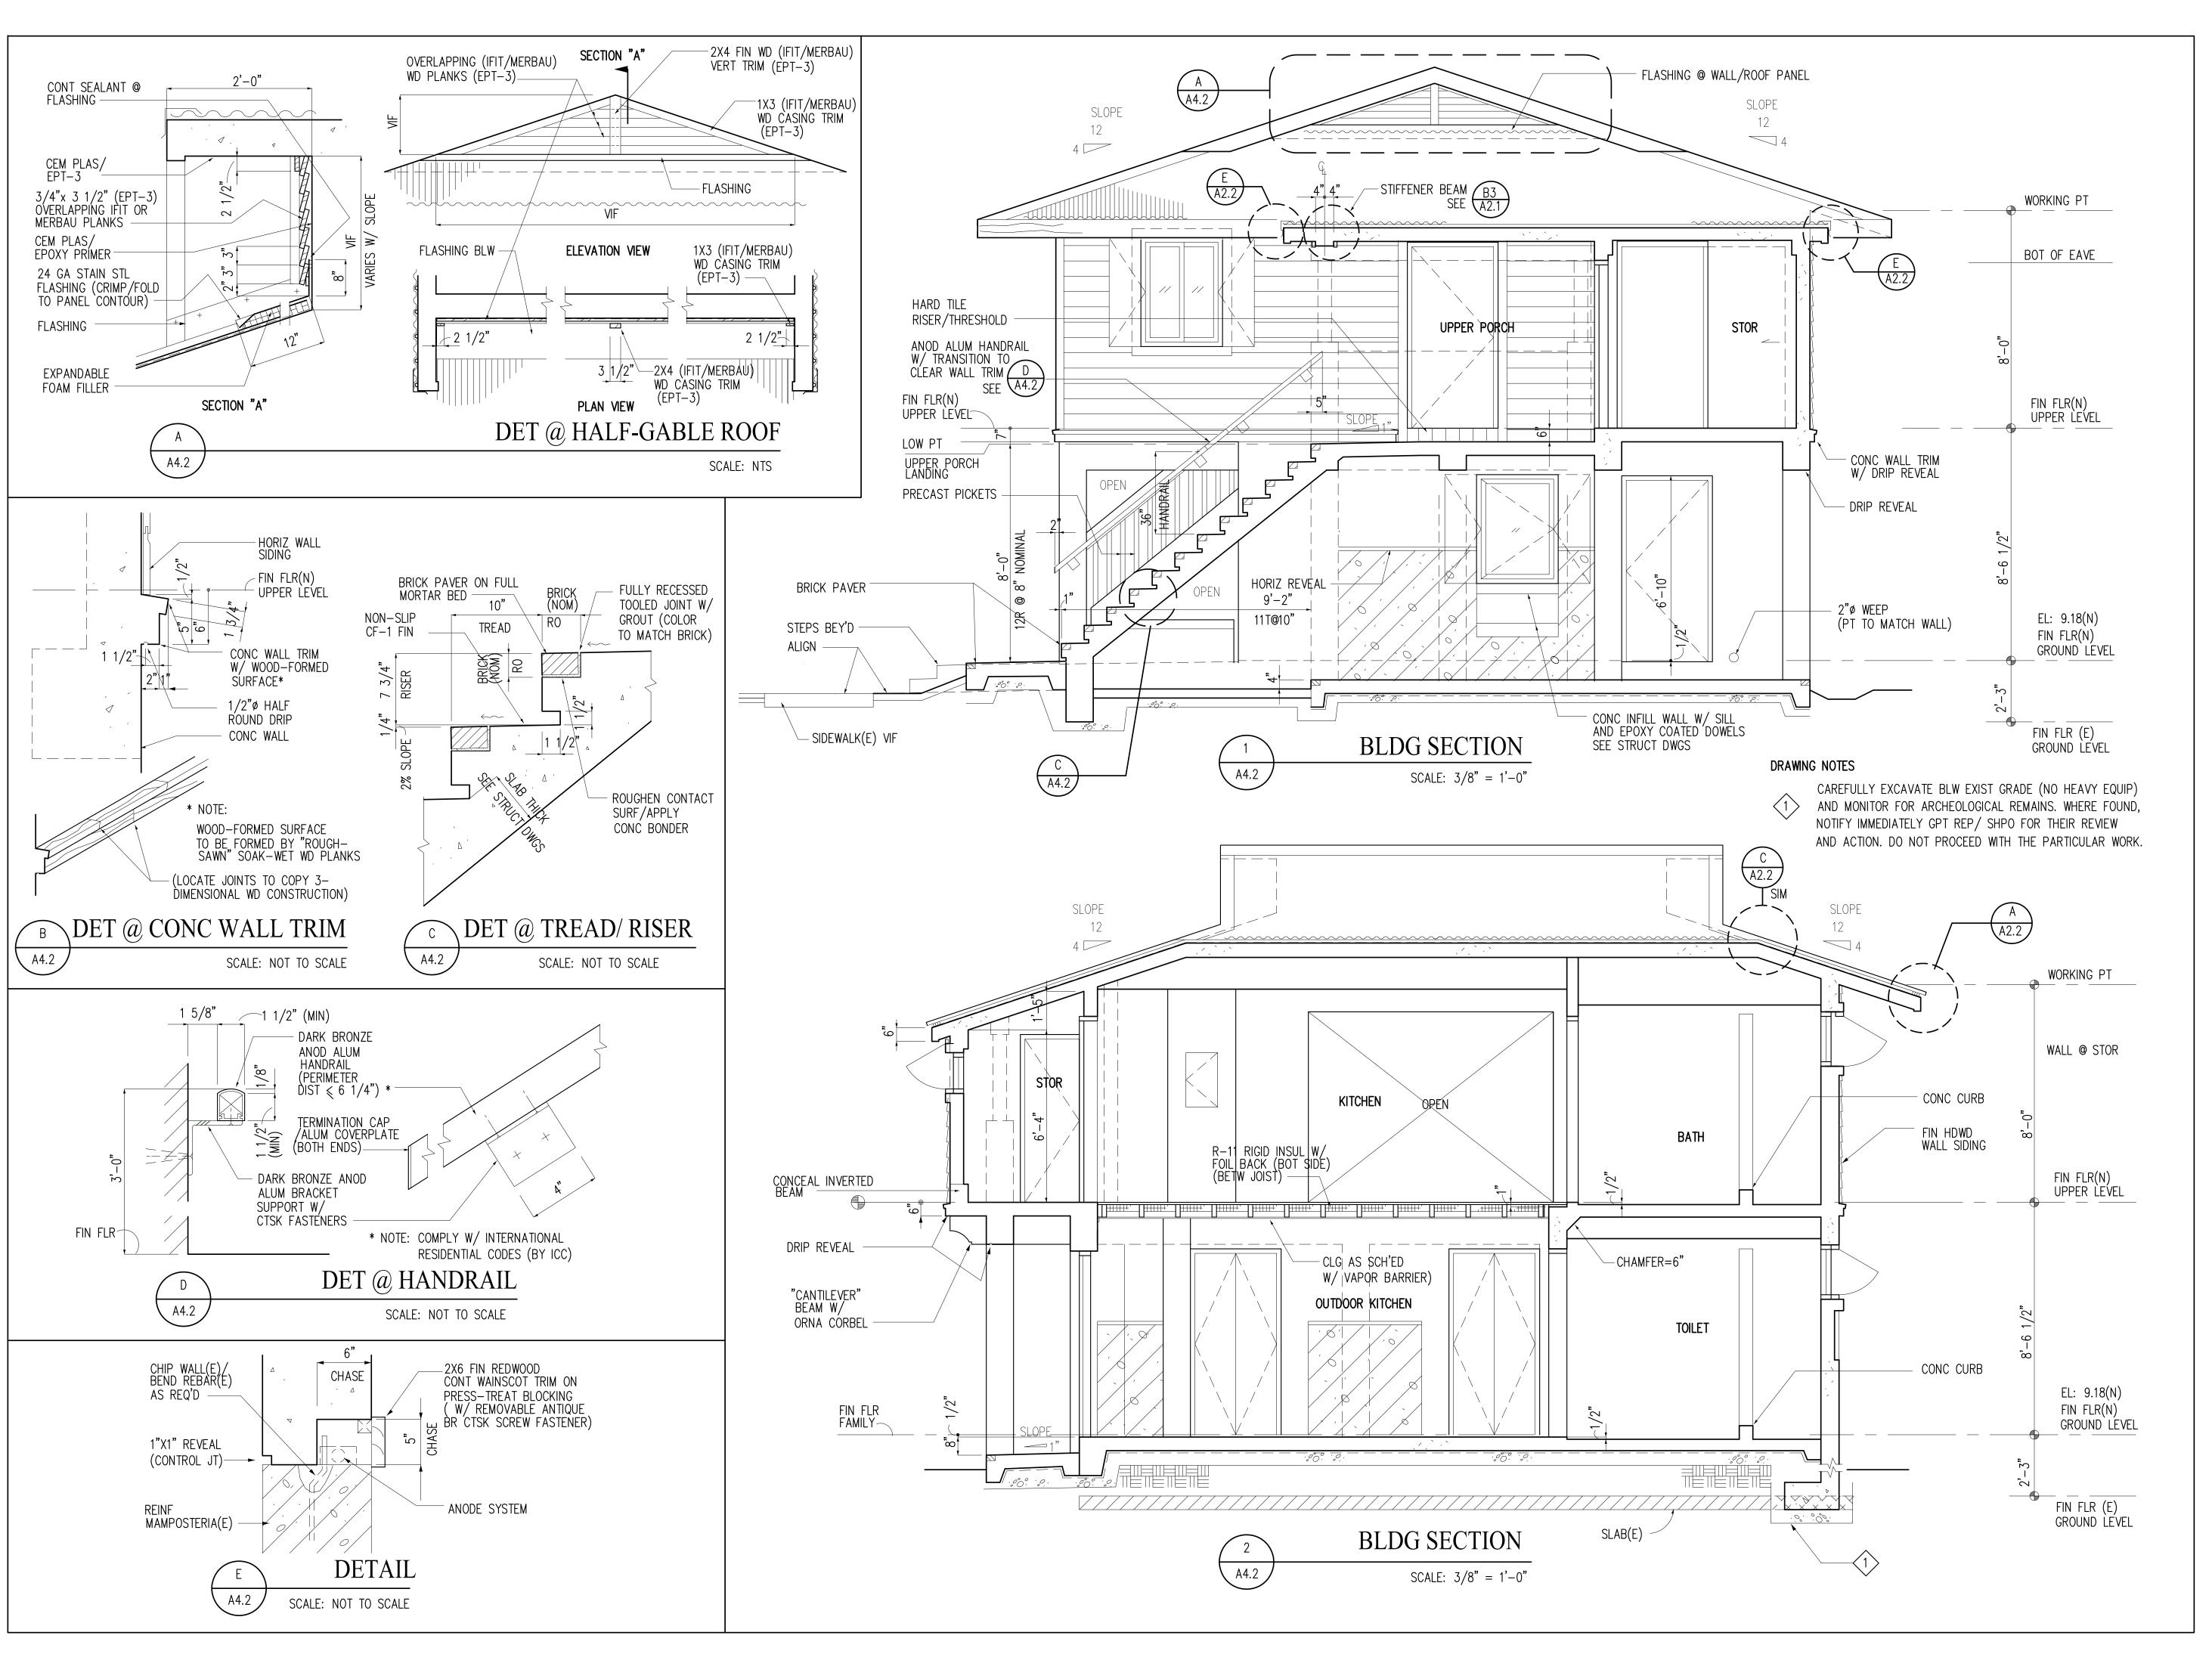



INANGOKKON INADAHI GUAHAN P.O. BOX 3036, HAGATNA, GUAM 96932

PROJECT TITLE: RECONSTRUCTION

ANTONIA C. **CHARGUALAF** HOUSE,

HISTORIC DISTRICT OF INARAJAN,

INARAJAN, GUAM DPR TRACKING NO: RC 2014 0373

DESIGN CONSULTANT: Provido ·Tan · Jones architects inc.



P.O. BOX 6463, TAMUNING, GUAM 96931 TEL: 671 646 1361 FAX: 671 646 2767

PTJA PROJECT NO: GPT.02 THIS WORK WAS DONE BY ME OR UNDER MY DIRECT SUPERVISION EXPIRATION DATE: APR, 2015

BLDG SECTIONS


DRAWING NAME:


DT DATE: NOV 2104 CHECKED: LP SCALE: AS NOTEI


**REVISIONS:** DESCRIPTION

DRAWING SHEET NO:

A4.2

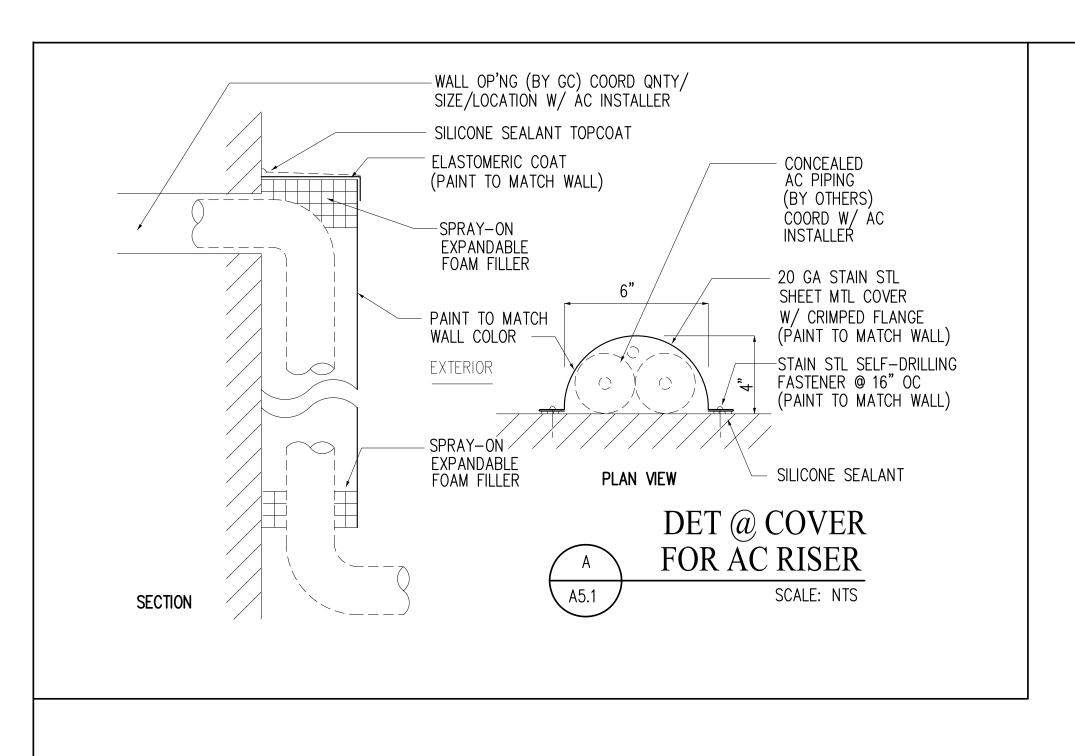

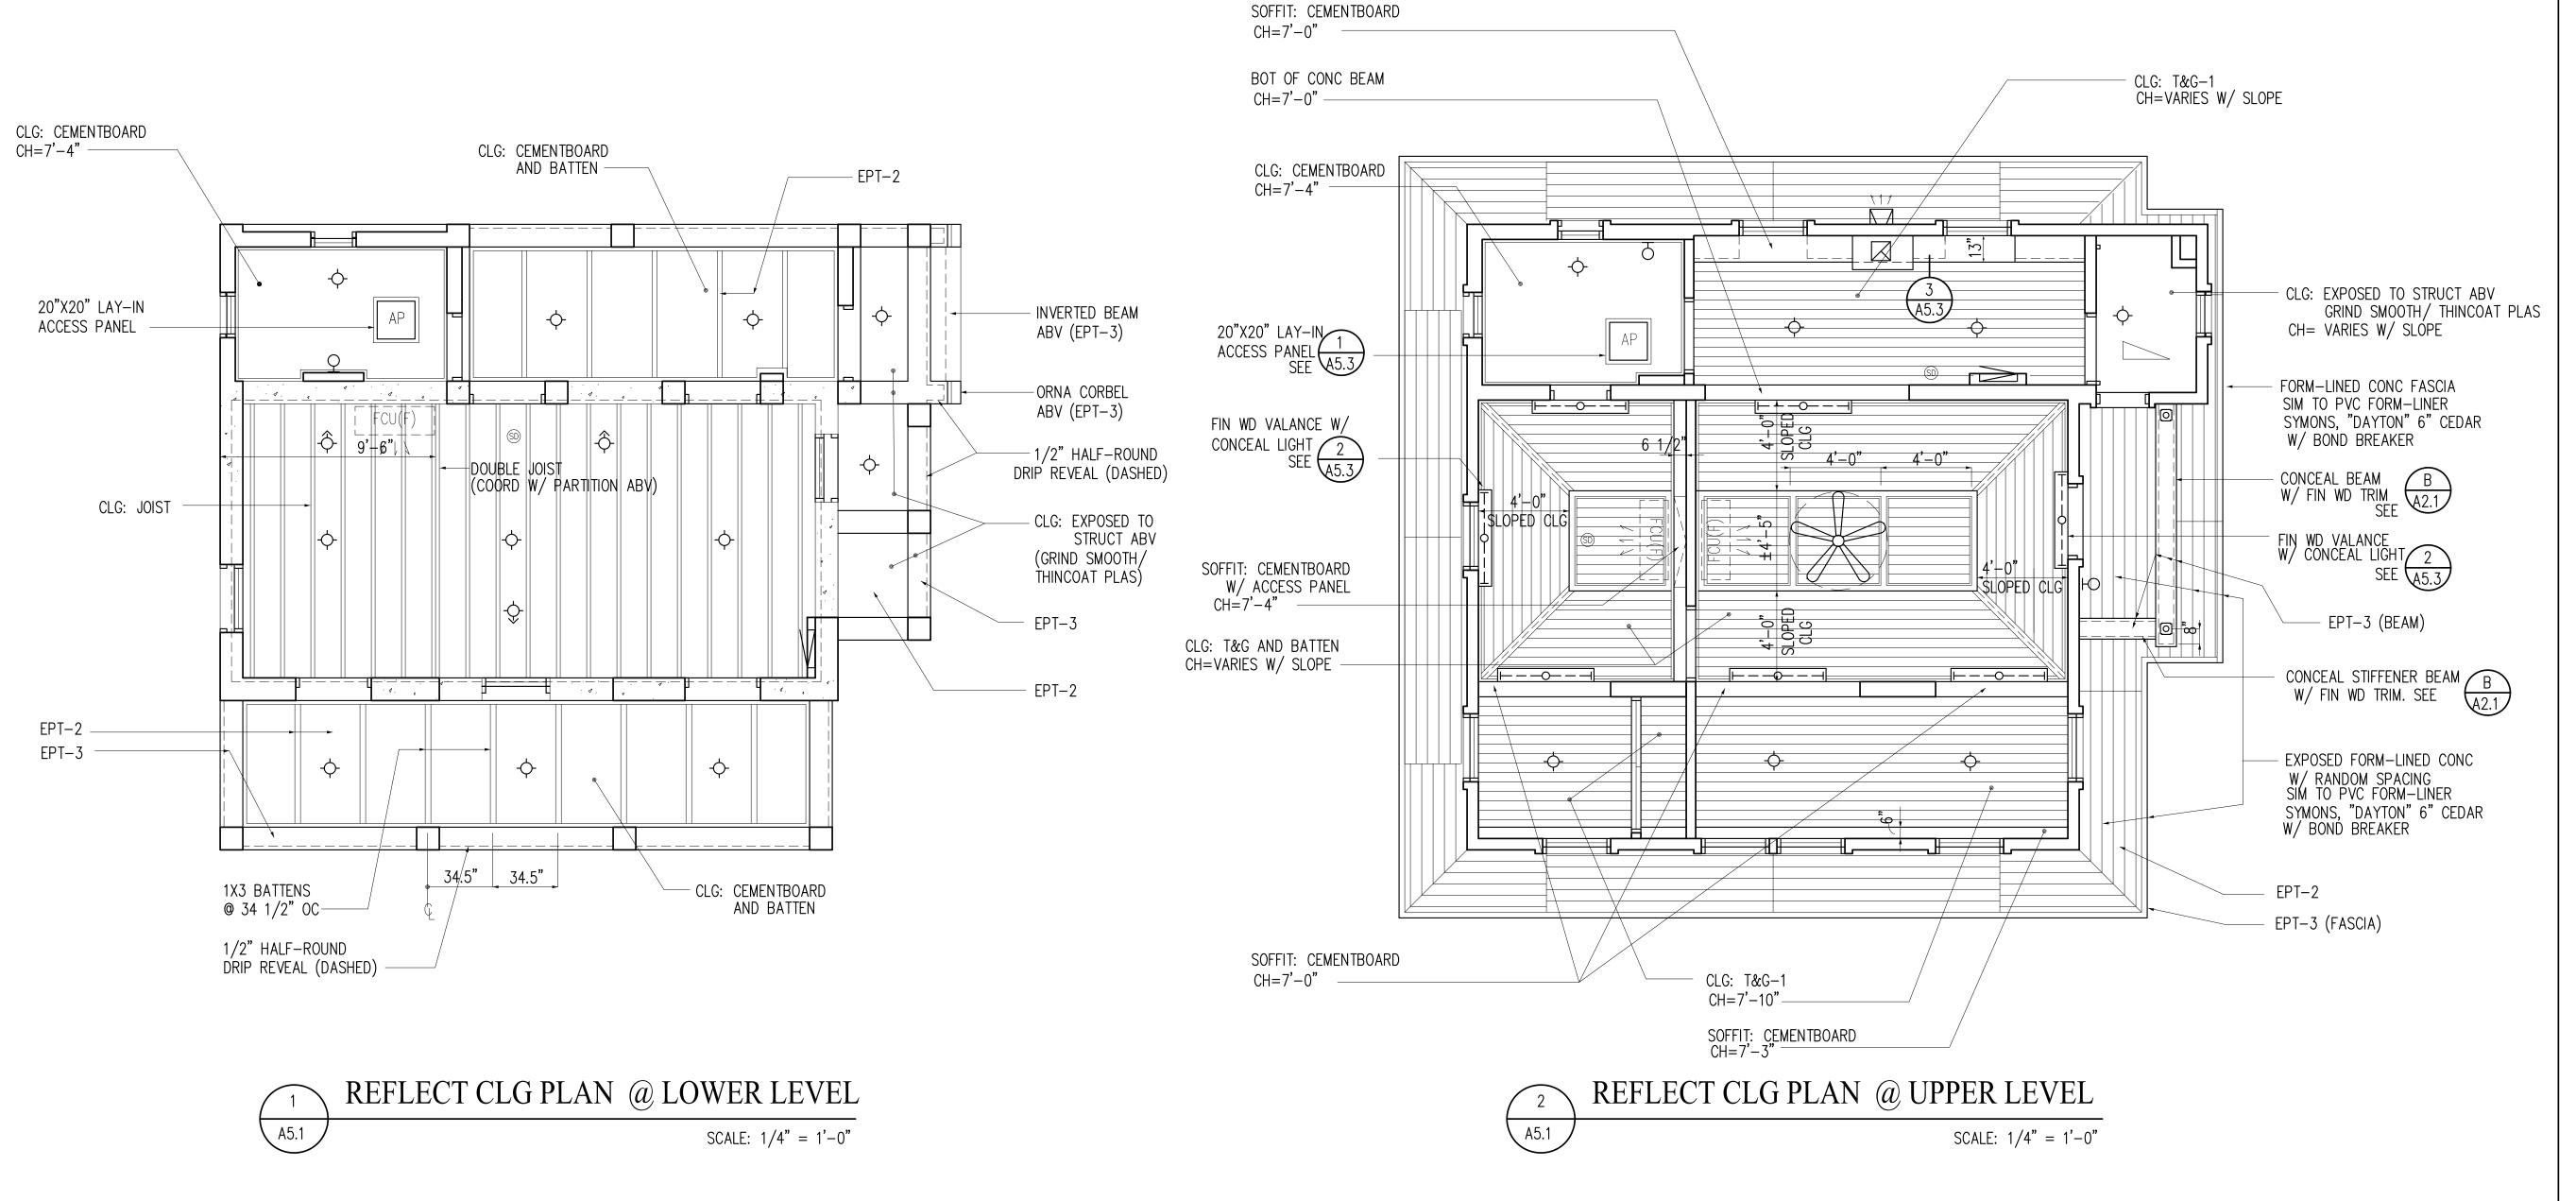

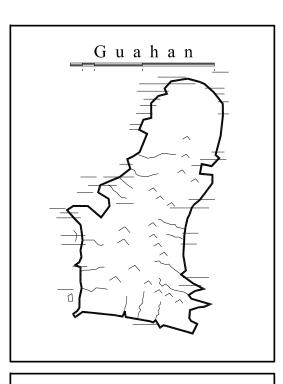

INANGOKKON INADAHI GUAHAN P.O. BOX 3036, HAGATNA, GUAM 96932

PROJECT TITLE:

# RECONSTRUCTION of ANTONIA C. CHARGUALAF


HOUSE,
HISTORIC
DISTRICT OF
INARAJAN,

INARAJAN, GUAM
DPR TRACKING NO: RC 2014 0373

DESIGN CONSULTANT:

Provido Tan Jones

architects inc.

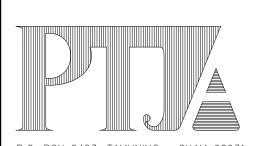

P.O. BOX 6463, TAMUNING, GUAM 96931 TEL: 671 646 1361 FAX: 671 646 2767

PTJA PROJECT NO: GPT.02

THIS WORK WAS DONE BY ME OR UNDER MY DIRECT SUPERVISION EXPIRATION DATE: APR, 2015

DRAWING NAME:

LOWER LEVEL
REFLECT CLG PLAN

DRAWN: DT DATE: NOV 2104

CHECKED: LP SCALE: AS NOTED


REVISIONS:

10N



DRAWING SHEET NO:

A5.1

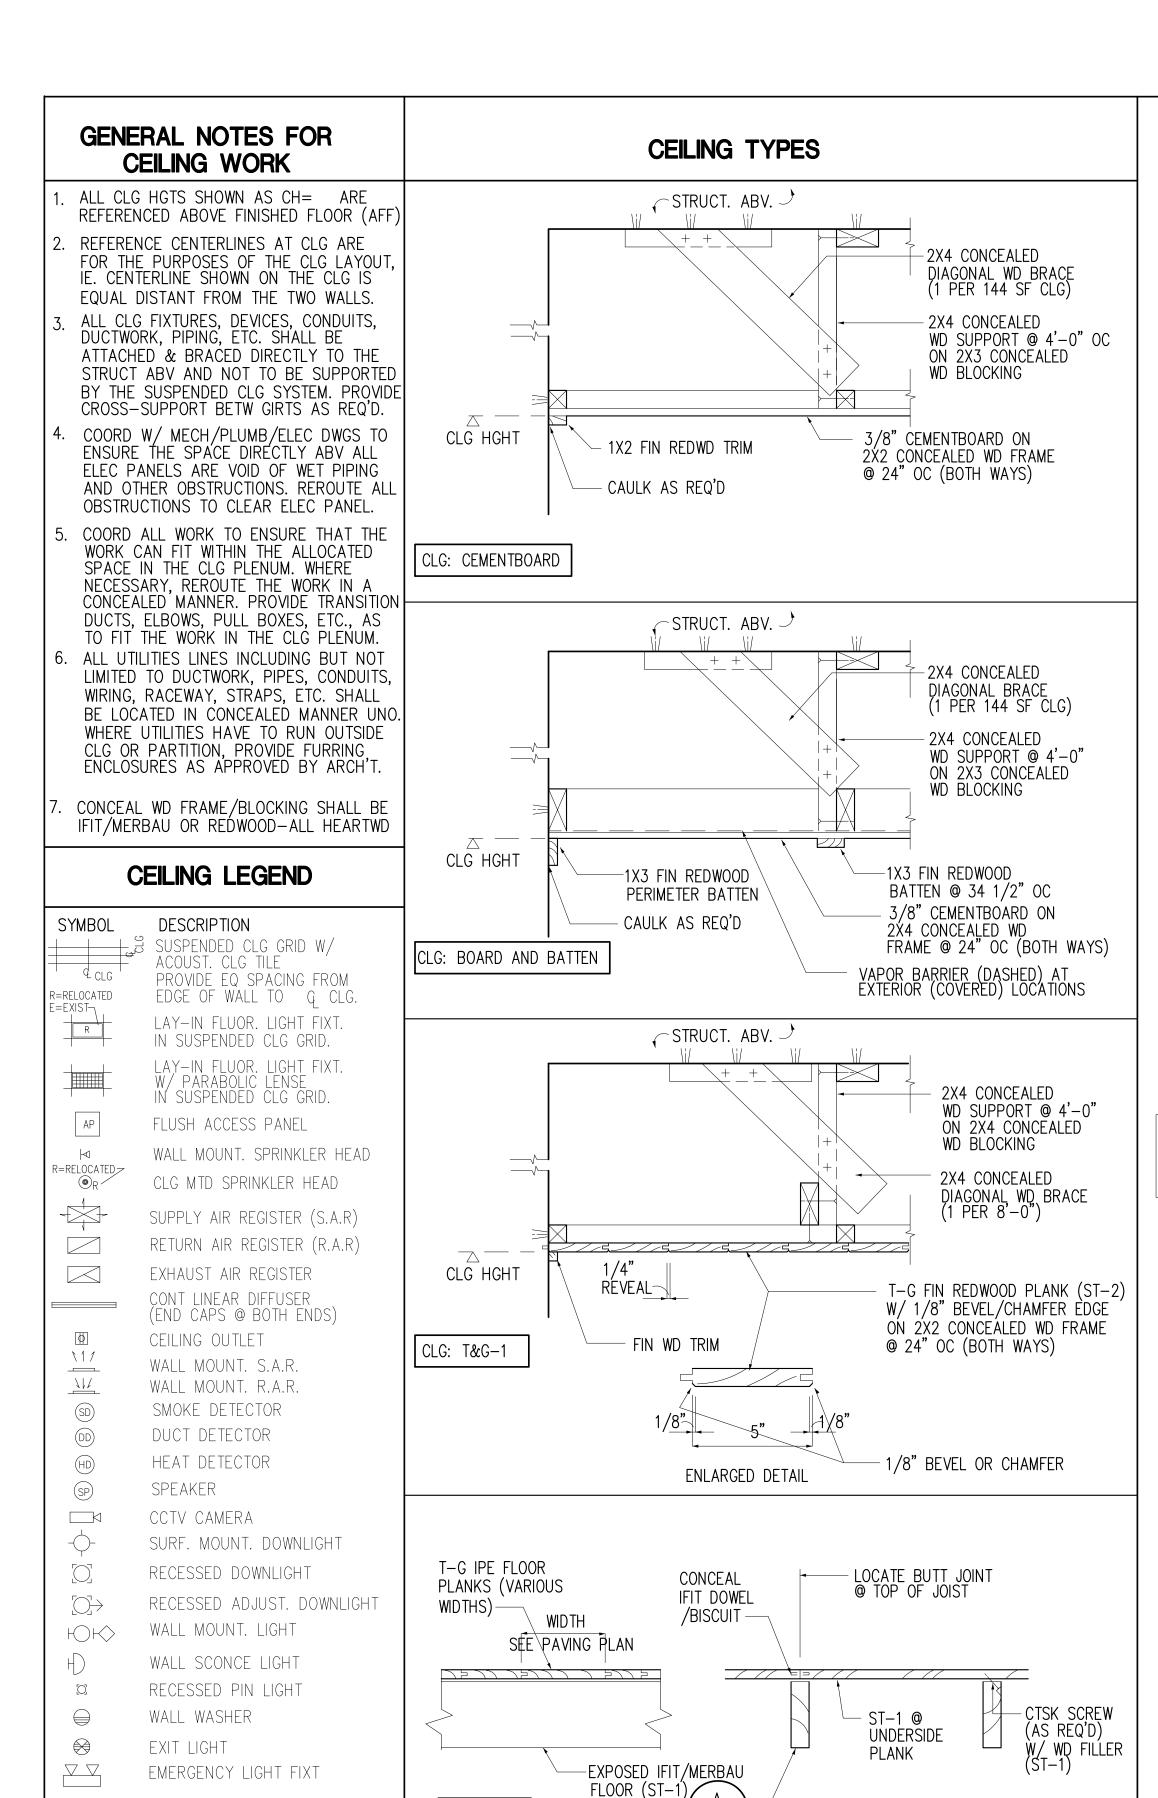

FIRE ALARM PULL STATION

STRIP FLUORSECENT LIGHT

FLUORESCENT LIGHT W/ LENSE

CONCEALED STRIP FLUORSCENT

HIGH FREQUENCY HORN

& STROBE LIGHT

FLUOR.FIXT. WITH

CLG CHANDELIAR

PENDANT MOUNT

TRACKLIGHT

TRACKLIGHT

CEILING FAN


WRAPAROUND LENSE


LED LIGHT


CLG: JOIST


CLG: T&G-2 AND BATTEN


A5.2

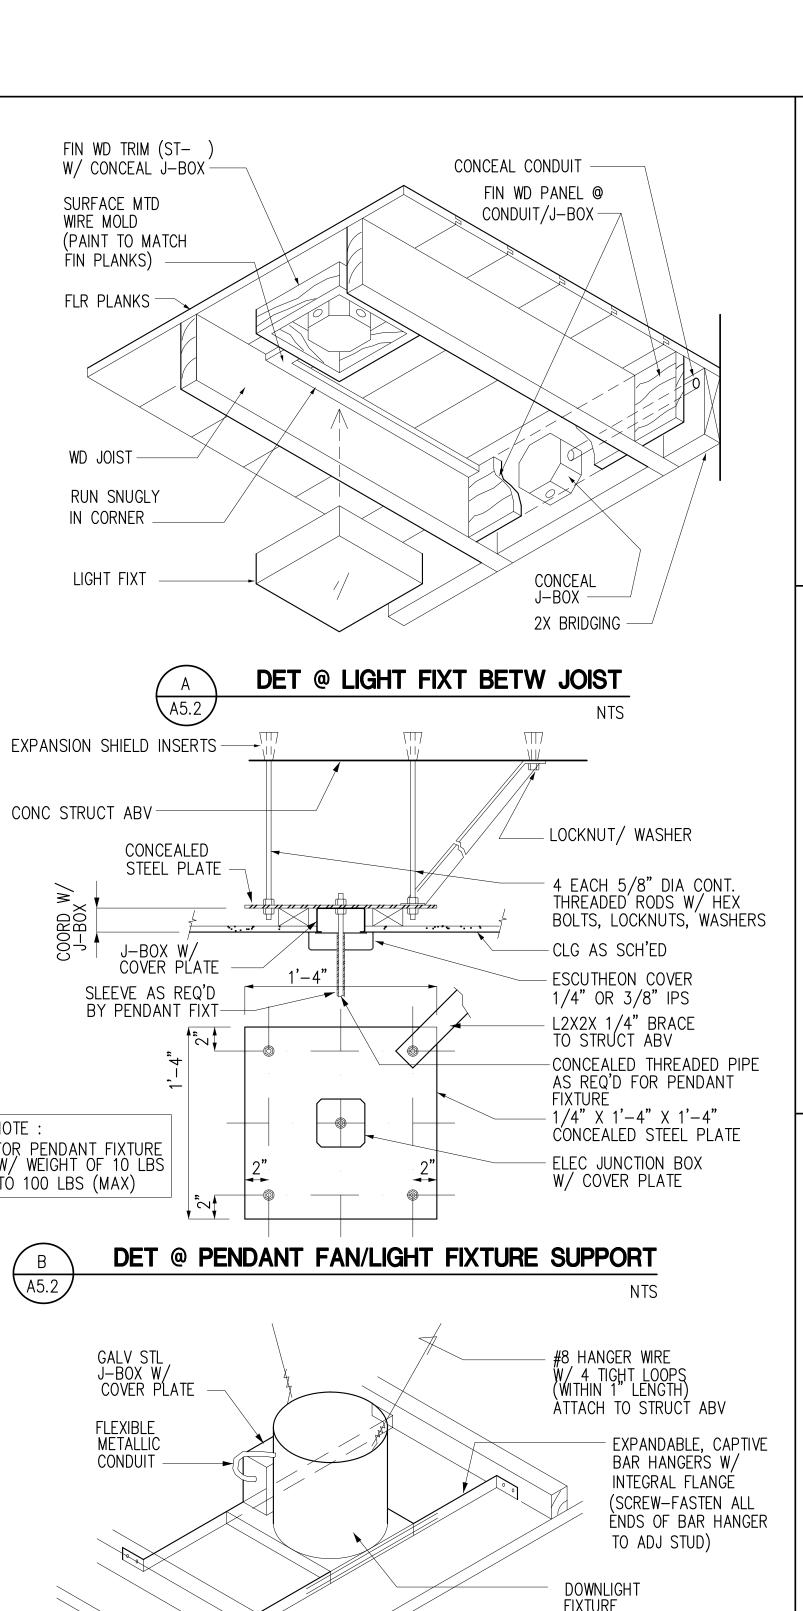

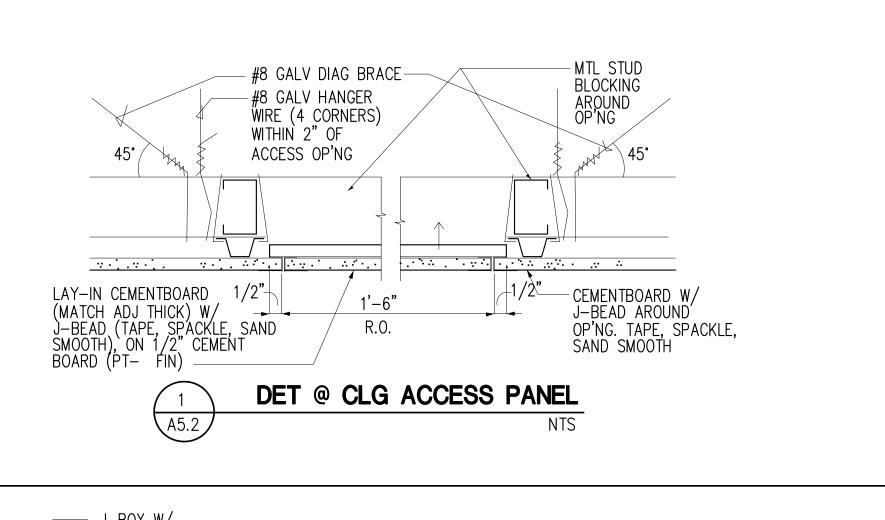

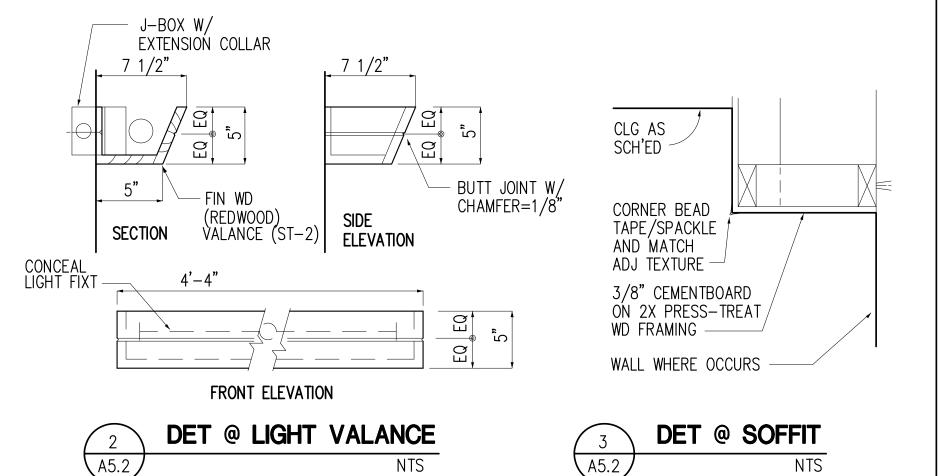

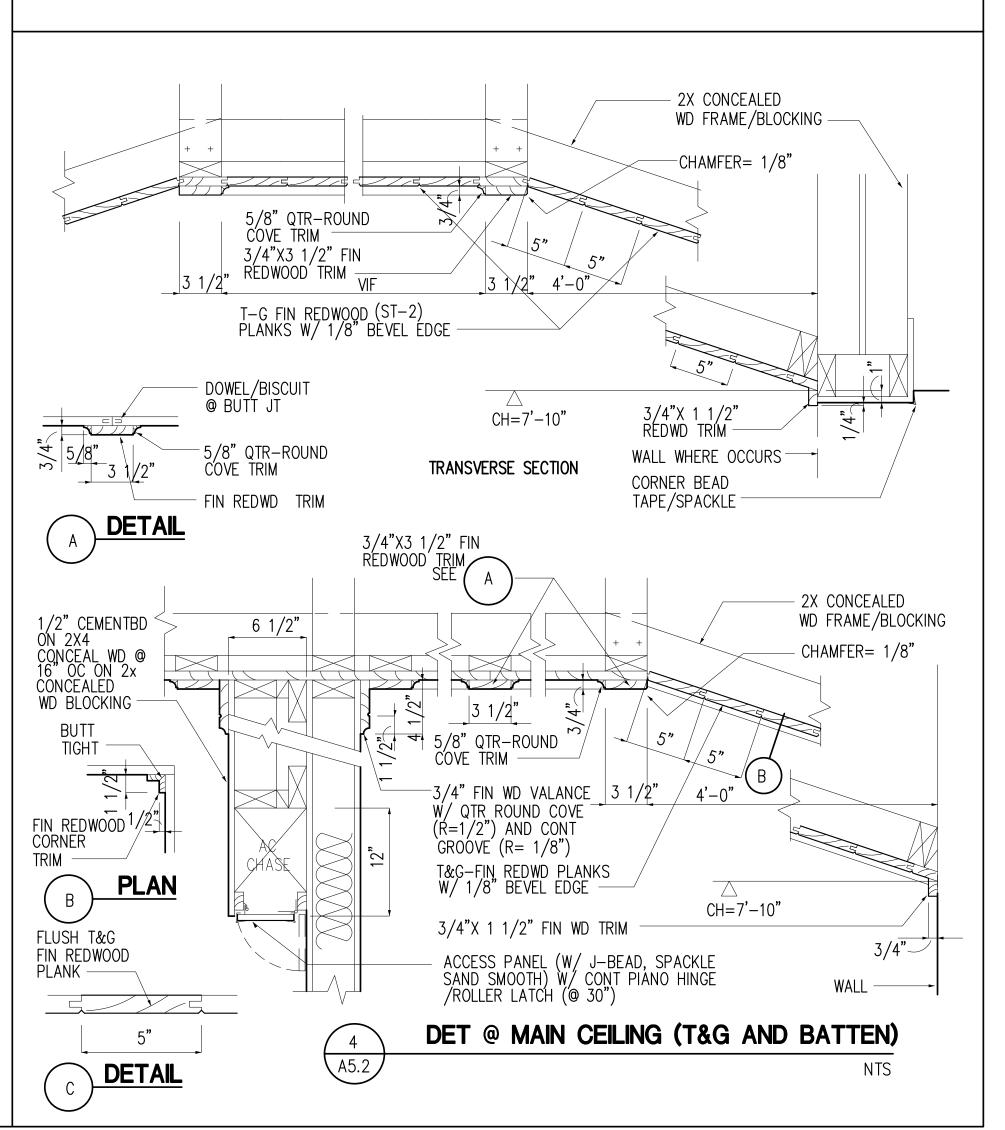

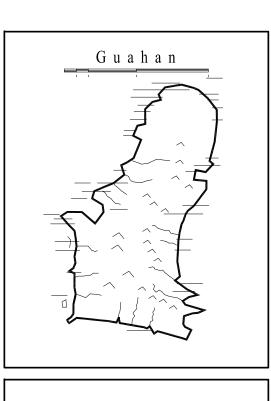

**GUAM PRESERVATION TRUST** 


INANGOKKON INADAHI GUÅHAN P.O. BOX 3036, HAGATNA, GUAM 96932

PROJECT TITLE:

RECONSTRUCTION ANTONIA C CHARGUALAF HOUSE, HISTORIC

DISTRICT OF INARAJAN, INARAJAN, GUAM

**DESIGN CONSULTANT:** Provido · Tan · Jones architects inc.

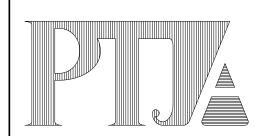

P.O. BOX 6463, TAMUNING, GUAM 96931 TEL: 671 646 1361 FAX: 671 646 2767

> PTJA PROJECT NO: GPT.02 THIS WORK WAS DONE BY ME OR

UNDER MY DIRECT SUPERVISION EXPIRATION DATE: APR, 2015

DRAWING NAME:


CEILING DETAILS

DT DATE: NOV 2014 CHECKED: LP | SCALE: AS NOTE

**REVISIONS:** DESCRIPTION

DRAWING SHEET NO:

A5.2

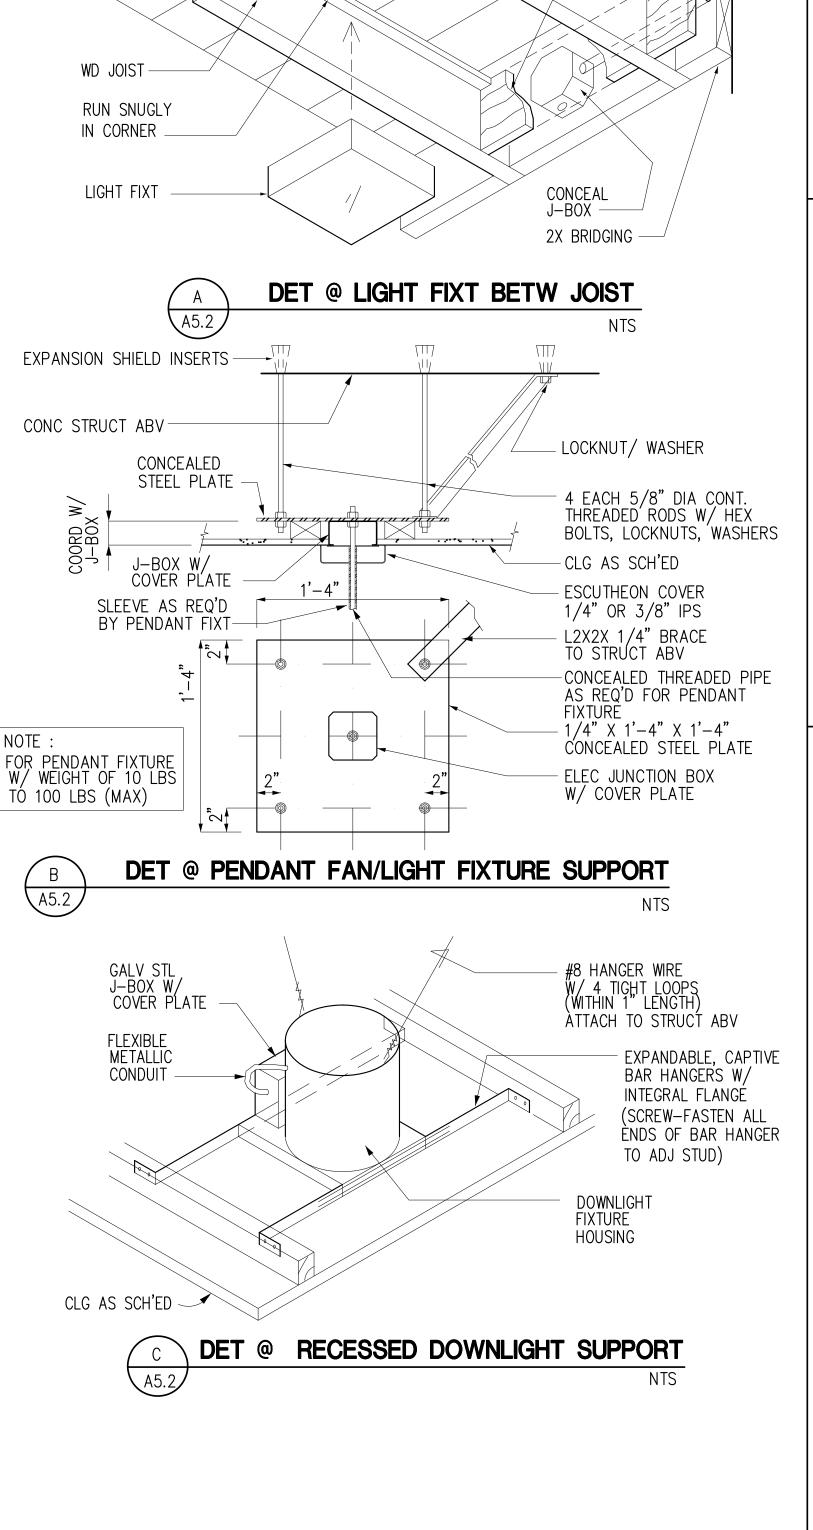

#### GENERAL NOTES FOR ARCHITECTURAL FINISHES SELECTION OF FINISHES BELOW ARE FOR THE SOLE PURPOSE OF CONVEYING AESTHETIC APPEARANCE ONLY. SUBJECT TO COMPLIANCE FINISH LEGEND W/ OTHER REQUIREMENTS, PROVIDE PRODUCTS TO MATCH APPEARANCE AS INDICATED BY SELECTION OF FINISHES BELOW. 2. ALL INTERIOR WALL AND CLG FINISHES SHALL COMPLY WITH CLASS "A" (FLAME SPREAD 0-25, SMOKE DEVELOPED 0-450, PER UBC/NFPA) 3. ALL INTERIOR FLOOR FINISHES SHALL COMPLY WITH CLASS "I" INTERIOR FLOOR FINISH PER UBC /NFPA. 4. STATIC COEFF OF FRICTION FOR ALL FLOOR FINISHES SHALL NOT BE LESS THAN 0.6, AND STATIC COEFF OF FRICTION OF 0.8 FOR RAMP FINISHES. 5. DYNAMIC COEFF OF FRICTION FOR ALL EXTERIOR FLOOR FINISHES SHALL NOT BE LESS THAN 0.4 DESCRIPTION COLOR/ MANUF SCOPE REMARKS LOCATION SYMBOL EXPOSED AGGREGATE (3/4" AGGREGATE) W/PENETRATING MATTE CLEAR SEALER PROVIDE MOCKUP FOR REVIEW CF-1 FIN "IPE" HDWD (ST-1) FINISH HDWD PLANK FLOORING (ST-1) SEE WOOD SPECIES SCHEDULE WD-112"X12" UNGLAZED UNFLASHED QUARRY PAVERS W/ MATTE CLEAR PENETRATING SEALER SENECA TILE CLAY GROUT: CUSTOM BUILDING PRODUCTS 150 FAWN QT-F1 8"X8" UNGLAZED UNFLASHED QUARRY PAVERS W/ MATTE CLEAR PENETRATING SEALER SENECA TILE CLAY GROUT: CUSTOM BUILDING PRODUCTS 150 FAWN BELDEN RED PAVERS: BELCREST 500 BRICK PAVER BP-1LAMPUS CO. ADA TRUNCATED DOME PAVERS RED CONCRETE PAVER (ADA) BP-2FIN HDWD W/ SEMITRANSPARENT MATTE SEE WOOD SPECIES SCHEDULE WB-1 FIN "REDWOOD" (ST-2) CLEAR STAIN FINISH WB-2CONTINUOUS RUBBER COVE BASE ROPPE P110 BROWN INTERIOR ACRYLIC PAINT EGGSHELL PT-1 BEHR HDC-NT-21 WEATHERED WHITE TYPICAL WALL/CLG INTERIOR ACRYLIC PAINT EGGSHELL BEHR HDC-CT-19 WINDRUSH CEILING (ACCENT) PT-2EXTERIOR ACRYLIC PAINT EGGSHELL EPT-1 FRAZEE CW053W NATURAL BISQUE TYPICAL WALL EXTERIOR ACRYLIC PAINT EGGSHELL SIDING (CHARGUALAF) BEHR PMD-100 AQUATONE EPT-2 EXTERIOR ACRYLIC PAINT EGGSHELL EPT-3 ACCENT TRIM (CHARGUALAF) BEHR 450 F-5 MARSH CREEK EXTERIOR ACRYLIC PAINT EGGSHELL EPT-4 FRAZEE 8806N TUDOR HOUSE ACCENT TRIM (LUJAN/FLORES) EXTERIOR ACRYLIC PAINT EGGSHELL EPT-5 FRAZEE 8203Y GOBI BIEGE ACCENT INFILL PANEL EXTERIOR ACRYLIC PAINT EGGSHELL EPT-6 TRIM (MENO) FRAZEE 8395D MONTEREY ROSE 8"X8" UNGLAZED UNFLASHED QUARRY PAVERS W/ TRANSPARENT MATTE PENETRATING SEALER QT-W1 GROUT: CUSTOM BUILDING PRODUCTS 150 FAWN SENECA TILES CLAY GROUT: CUSTOM BUILDING PRODUCTS 150 FAWN 4"X8" UNGLAZED UNFLASHED QUARRY PAVERS W/ QT-W2 W/ TRANSPARENT MATTE PENETRATING SEALER A-3602 6"X6" BULLNOSE @ EXPOSED EDGE DALTILE: WALL TILE MATTE BISCUIT K775 CT-W1 6"X6" CERAMIC WALL TILE W/ GROUT GROUT: CUSTOM BUILDING PRODUCTS 10 ANTIQUE WHITE IFIT/MERBAU AND IPE WOOD (SEE WOOD SPECIES SCHEDULE) WOOD SEALER: THOMPSON OR EQ CLEAR WOOD SEALER (MATTE) W/ ST-1 PASTE FINISHING WAX COAT WAX: MINWAX, PASTE FINISHING WAX, SPECIAL DARK 78600 ZAR: MOORISH TEAK 123 DARK OPAQUE WOOD STAIN SEE WOOD SPECIES SCHEDULE ST-2CEM PLAS/ 1"ø ANTIQUE BRONZE COVE BASE **BULLNOSE TILE** -CEM PLAS/ SHOWER ROD-PT-1 LOW WALL SEE ELEC DWGS QT-W2 @ TOP OF CURB 6 SEE A6.1 CONC COUNTERTOP -BULLNOSE TILE (OFFSET JT) DR ÀS DR AS SCHED SCHED -QUARRY TILE (QT-W1) ----−WALL BASE (WB−1)—— 2'-10" ιEWH INT ELEV @ UPPER LEVEL BATH A6.1 SCALE: 1/4"=1'-0" CEM PLAS /PT-1 (A8.1) (A8.1) - KIT HOOD - WASHER A BOX SEE A2.1

24" 30" /15"

WALL BASE

LIGHT FIXT SEE ELEC DWGS

-CEM PLAS/

PT-1

MED CAB W/ MIRROR DOOR 10 SEE A8.1

DR AS SCHED

FILLER

- LINT-TRAP/

-COORD AC LINE

−WASHER BOX SEE A A2.1

DIVIDER

-ELEC PANEL

A6.1

CEM PLAS/ PT-1

A6.1

#### ROOM FINISH SCHEDULE

- GENERAL NOTES FOR ROOM FINISHES
- SYMBOLS FOR WALL DIRECTIONS AS SHOWN IN THE INTERIOR ELEVATION MARKER ON THE FLOOR PLAN.
- 2. COORD FINISHES WITH INTERIOR ELEVATIONS, REFLECTED CLG PLAN AND CASEWORK. ALL DISCREPANCIES SHALL BE BROUGHT TO THE ATTENTION OF THE ARCHITECT BEFORE PROCEEDING WITH THE PARTICULAR WORK.

	ROOM	F	LOOR	WΔII			WAL	_		CEILIN	IG	DELLA DIVO
	DESCRIPTION	FIELD	BORDER	WALL BASE	Α	В	С	D	WAINSCOT	TYPE	FIN	REMARKS
	MAIN PORCH	QT-F1		_	HS-1/ EPT-5	EPT-2	_	EPT-2	_		EPT-2/3	
ÆL	FAMILY ROOM	•		•	PT-1	PT-1	PT-1	PT-1	PT-1		ST-1	
LOWER LEVEL	OUTDOOR KITCHEN			•	•	•			_	EPT-2/3		
LOWE	BACK TOILET			'	PT-1	PT-1	PT-1/ QT-W1	PT-1/ QT-W1		_	PT-2	
	SHOWER	QT-F2			QT-W1	QT-W1	QT-W1	QT-W1		PLAN		
1	STAIR CF-		BP-1	_	EPT-2/ EPT-3	EPT-2/ EPT-3	EPT-2/ EPT-3	EPT-2/ EPT-3		STO		
	UPPER PORCH	QT-F1		•	•	•		•		ECTED	EPT-2/3	
	LIVING	WD-1		WB-1	PT-1	PT-1	PT-1	PT-1		REFLE	ST-2	
	BEDROOM	•		•	•	•	•	•		SEE	•	
	REACH-IN CLOSET										PT-2	
LEVEL	PARLOR										•	
H H	KITCHEN				•		•					
UPPER	BATH	QT-F1		•	PT-1	PT-1	PT-1/ QT-W1	PT-1/ QT-W1			PT-2	
	SHOWER	QT-F2			QT-W1	QT-W1	QT-W1	QT-W1				
	STORAGE	QT-F1		WB-1	PT-1	PT-1	PT-1	PT-1	•			
SITE	FRONT PATIO	CF-1	BP-1/2									
S	SIDE PATIO	CF-1	BP-1								EPT-2/3	

#### ABBREVIATIONS FOR FINISH LEGEND

A8.1

SCALE: 1/4"=1'-0"

30" 36"

INT ELEV @ KITCHEN (LOWER LEVEL)

SYMBOL	DESCRIPTION
ACT BP	ACOUSTICAL CEILING TILE BRICK PAVER
CF	CONCRETE FINISH

SYMBOL DESCRIPTION HIGH MOISTURE RESISTANT PLASTIC LAMINATE PAINT

REMOVE CLG TRIM (AS REQ'D

TO CLEAR FCU UNIT) -

1/4" X 1 1/4" VERT FIN WD BATTEN @ 16" OC. 3 SEE A6.3

WALL BASE

√ CT-W1 FIN

SYMBOL DESCRIPTION QUARRY TILE STAIN SOLID PLASTIC VINYL BASE

- FIN WD VALANCE

7 A8.1

8 A8.1

SCALE: 1/4" = 1'-0"

SYMBOL DESCRIPTION VINYL TILE VINYL COMPOSITION TILE WD WOOD

SHOWER

1 1/2" CLEAR

A6.1

4) IFIT (INTSIA BEJUGA) IS A LOCAL OR GUAM COMMON NAME FOR A WOOD SPECIES

(SHO SIDE)

**DESIGN CONSULTANT:** Provido •Tan•Jones architects

-QT-W2

-GROUT – #3 HOR

QT-W1 (ON BOTH SIDES OF CONC CURB)

ROUGHEN SURF/ CONC BONDER

SCALE: NTS

DET @ SHO. CURB



Guahan

**GUAM** 

TRUST

INANGOKKON INADAHI GUAHAN P.O. BOX 3036, HAGATNA, GUAM 96932

**RECONSTRUCTION** 

ANTONIA C

**CHARGUALAF** 

HOUSE,

HISTORIC

DISTRICT OF

INARAJAN.

INARAJAN, GUAM

PROJECT TITLE:

**PRESERVATION** 

P.O. BOX 6463, TAMUNING, GUAM 96931 TEL: 671 646 1361 FAX: 671 646 2767

PTJA PROJECT NO: GPT.02 THIS WORK WAS DONE BY ME OR UNDER MY DIRECT SUPERVISION EXPIRATION DATE: APR, 2015

DRAWING NAME: FINISH SCHEDULE INTERIOR ELEVATIONS

DT DATE: NOV 2014 CHECKED: LP SCALE: AS NOTE

**REVISIONS:** DESCRIPTION

DRAWING SHEET NO:

A6.

SHEET \_\_\_ OF \_\_\_

## WOOD SPECIES **SCHEDIII E**

LINT BOX

INT ELEV @ KITCHEN, STOR (UPPER LEVEL)

SHOWER ROD-

LOW WALL

OF CURB 6 A6.1

-QUARRY TILE (QT-W1)

DIVIDER

±5'-6"

WALL BASE EQ EQ B

1"ø ANTIQUE BRONZE

INT ELEV @ LOWER LEVEL BATH

SCALE: 1/4"=1'-0"

SCALE: 1/4"=1'-0"

ADJUST SHELF

FIXED SHELVES


GENERAL NOTES 1) WOOD TO BE PRIMED/SEALED AND PROTECTED FROM MOISTURE 2) CUT EXPOSED END-GRAINS TO BE FIELD-SEALED FROM MOISTURE


5) SUBMIT SAMPLES OF WOOD SPECIES W/ SURFACE APPEARANCE AND STAINS/ FINISHES FOR REVIEW AND APPROVAL. 13) CUT EXPOSED END-GRAINS OF PRESS-TREATED WD TO BE TERMITE-TREATED CONTENTS EXTERIOR WOOD, 15% VD INTERIOR WOOD, 10% VD

INT ELEVATION @ BEDROOM

	LOCATION	SPECIES	GRADE	SURFACE APPEARANCE	FINISH		LOCATION SPECIES		GRADE	SURFACE APPEARANCE	FINISH
JRE	FLOOR JOIST	IFIT OR MERBAU	SELECT STRUCT	S4S	ST-1		STL POST WD CLADDING TRIMS	IFIT OR MERBAU	1 OR BETTE	R S4S	EPT-3
STRUCTURE	FLOOR/DECKING PLANKS (T-G)	IPE	1 OR BETTER	ROUGH SAWN SAND SMOOTH	•		EXT. BEAM/STIFFENER TRIMS				
ST						9	GABLE ROOF TRIMS/ MISC. WD TRIMS				
RK)	INTERIOR WALL WOOD STUDS	IFIT OR MERBAU	CONSTRUCTION	S4S		ADDING	EXT. WALL HORIZ SIDING (PAINTED)	IFIT OR MERBAU			EPT-2
INTERIOR WORKS (INCLUDES WOODWORK/ MILLWORK/ CABINETWORK)	INT. CASING TRIMS (DOORS/WDW)	REDWOOD	CLEAR ALL HEART /HEARTWOOD	S	ST-2	] (: ] C	DOOR FRAMES	IFIT OR MERBAU			ST-1
LUDES	WALL BASE		•			(EX	DOORS (STILE, RAIL, INFILL PANEL)				
K S S	WALL/CLG RUNNING TRIMS					EXTERIOR	SHUTTER FRAME				EPT-3
ORKS	CEILING T-G BOARDS (CLEAR FIN)				•	EXT	SHUTTER UNIT				EPT-2/3
NO   NO   NO   NO   NO   NO   NO   NO	CEILING T-G BOARDS (PAINTED)				PT-		EXT. CASING TRIMS (DOOR/WDW/SHUTTER)		•	<b>V</b>	EPT-3
VTERIO WORK	KITCHEN/BATH CABINETS	IFIT OR MERBAU	1 OR BETTER	•	ST-1		EXT. WDW FRAMES	ALUM —	— SEE WDV	V SCHEDULE ——	ARK BRONZE
W00D				·			EXT. WINDOW UNIT				

BEDROOM

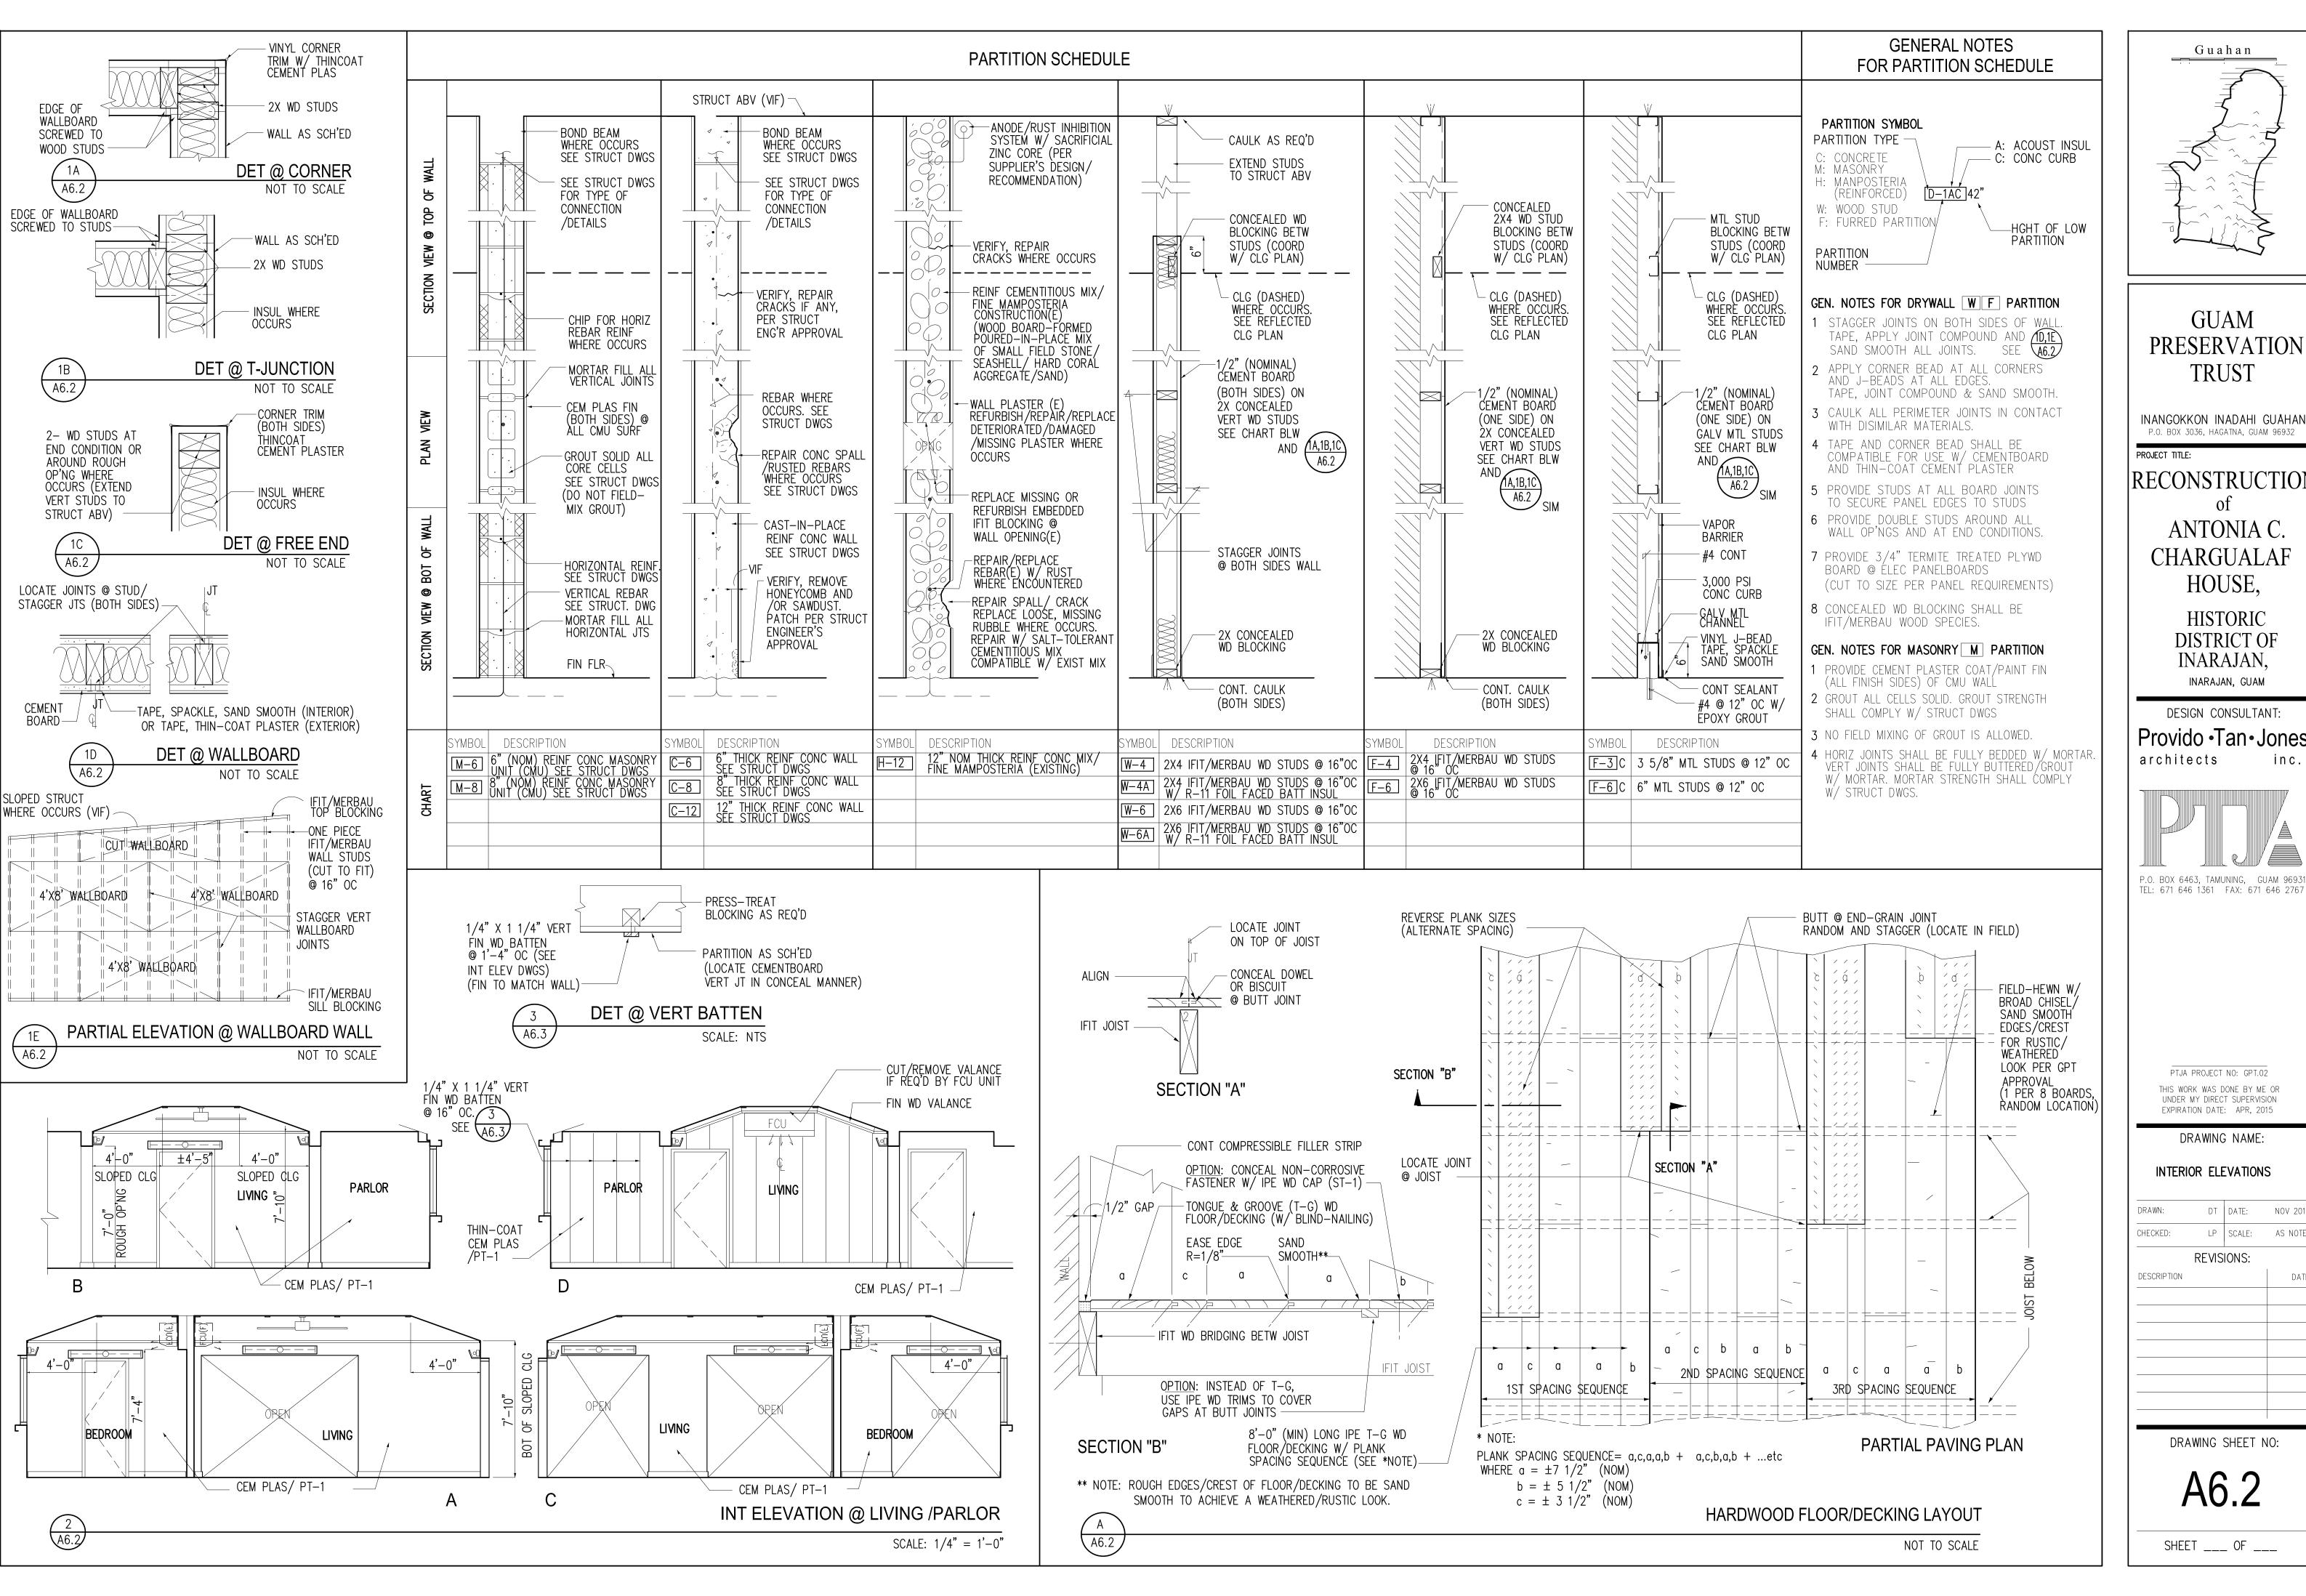

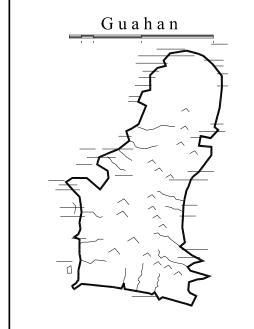

INANGOKKON INADAHI GUÅHAN P.O. BOX 3036, HAGATNA, GUAM 96932

PROJECT TITLE:

|RECONSTRUCTION ANTONIA C. **CHARGUALAF** HOUSE,

> HISTORIC DISTRICT OF INARAJAN. INARAJAN, GUAM

DESIGN CONSULTANT: Provido •Tan•Jones architects



PTJA PROJECT NO: GPT.02 THIS WORK WAS DONE BY ME OR UNDER MY DIRECT SUPERVISION EXPIRATION DATE: APR, 2015


DRAWING NAME:


DT DATE: NOV 2014 CHECKED: LP SCALE: AS NOTE

**REVISIONS:** DESCRIPTION

DRAWING SHEET NO:

A6.2

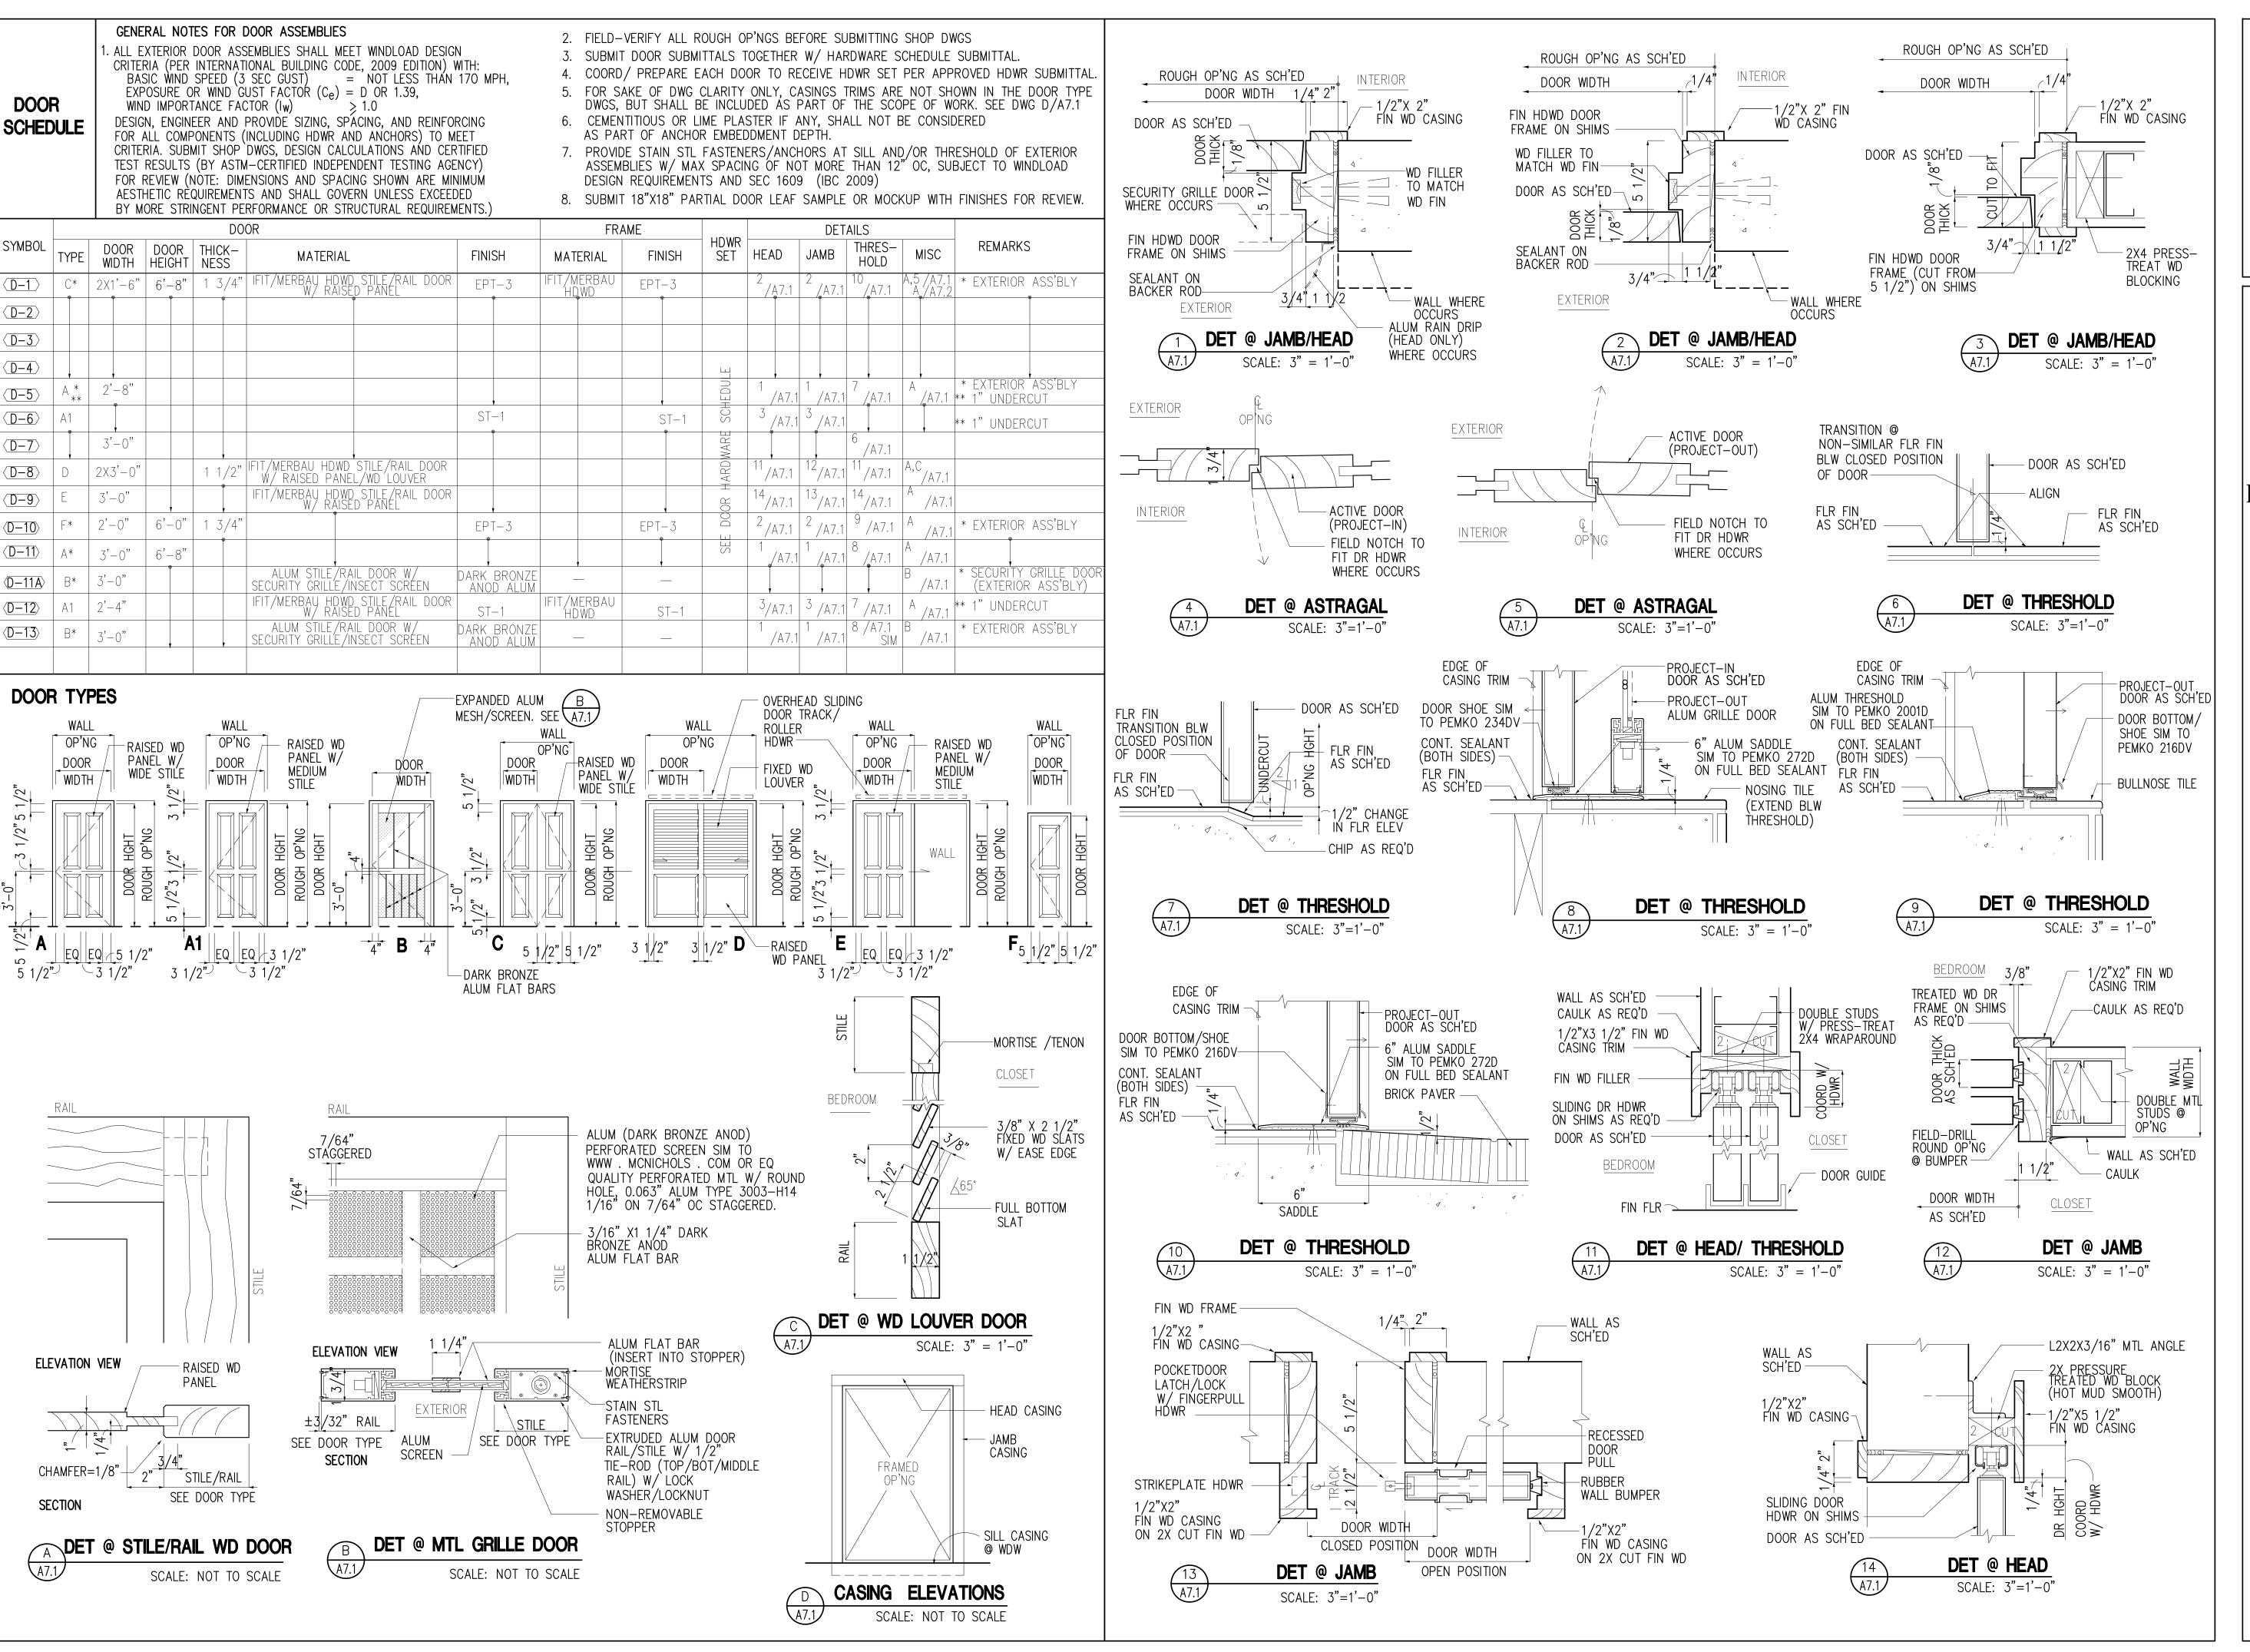

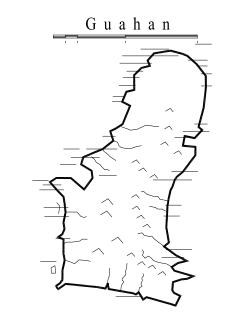

INANGOKKON INADAHI GUÅHAN P.O. BOX 3036, HAGATNA, GUAM 96932

PROJECT TITLE:


RECONSTRUCTION of ANTONIA C. CHARGUALAF HOUSE,

> HISTORIC DISTRICT OF INARAJAN INARAJAN, GUAM

DESIGN CONSULTANT:

Provido Tan Jones

architects inc.

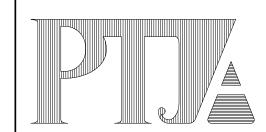

P.O. BOX 6463, TAMUNING, GUAM 96931 TEL: 671 646 1361 FAX: 671 646 2767

PTJA PROJECT NO: GPT.02

THIS WORK WAS DONE BY ME OR UNDER MY DIRECT SUPERVISION EXPIRATION DATE: APR, 2015

DRAWING NAME:

DOOR SCHEDULE

DRAWN: DT DATE: NOV 2014

CHECKED: LP SCALE: AS NOTED

REVISIONS:

DESCRIPTION DATE

PIPTION

DRAWING SHEET NO:

A7.1

#### GENERAL NOTES FOR WINDOWS / STOREFRONT ASSEMBLIES 1. EXTERIOR WDW/CURTAINWALL/LOUVER ASSEMBLIES SHALL MEET WINDLOAD DESIGN CRITERIA (PER INTERNATIONAL BUILDING CODE, 2009 EDITION) WITH: BASIC WIND SPEED (3 SEC GUST) = NOT LESS THAN 170 MPH, **WINDOW** EXPOSURE OR WIND GUST FACTOR ( $C_e$ ) = D OR 1.39, SCHEDULE WIND IMPORTANCE FACTOR $(I_w)$ > 1.0 = SEE STRUCT DWGS FOR CRITERIA WIND PRESSURE LOADING DESIGN, ENGINEER AND PROVIDE SIZING, SPACING, AND REINFORCING FOR ALL COMPONENTS (INCLUDING HDWR AND ANCHORS) TO MEET CRITERIA. SUBMIT SHOP DWGS, DESIGN CALCULATIONS AND CERTIFIED TEST RESULTS (BY ASTM-CERTIFIED INDEPENDENT TESTING AGENCY) FOR REVIEW (NOTE: DIMENSIONS AND SPACING SHOWN ARE MINIMUM AESTHETIC REQUIREMENTS AND SHALL GOVERN UNLESS EXCEEDED

WINDOW TYPES

REMOVABLE ROUGH OP'NG

BY MORE STRINGENT PERFORMANCE OR STRUCTURAL REQUIREMENTS.

- 2. SUBMIT SHOP DWGS BASED ON FIELD-VERIFIED ROUGH OP'NG DIMENSIONS. 3. FOR SAKE OF DWG CLARITY ONLY, CASING TRIMS ARE NOT SHOWN IN WDW TYPE
- DWGS BUT SHALL BE INCLUDED AS PART OF THE SCOPE OF WORK. SEE DWG D/A7.1 4. EXTERIOR GLASS/TINT TO HAVE COEFF OF SHADING: 0.5 (SUBMIT SAMPLE)
- 5. COORD EXTERIOR WDW ASSEMBLIES W/ STORM SHUTTERS TO AVOID ANY CONFLICTS DURING INSTALLATION.
- 6. CEMENTITIOUS AND/OR LIME PLASTER IF ANY, SHALL NOT BE CONSIDERED AS PART OF ANCHOR EMBEDDMENT DEPTH.
- 7. COORD W/ WDW HDWR IF ANY, AND PREPARE WDW FRAMES, SASH OR WALL STRUCT TO RECEIVE HDWR.
- 8. AT EXTERIOR ASSEMBLIES, PROVIDE STAIN STL FASTENENRS/ANCHORS AT SILL WITH MAX SPACING OF NOT MORE THAN 12" OC, SUBJECT TO WINDLOAD DESIGN REQUIREMENTS, AND SEC 1609 (IBC 2009)

2X4 FIN HDWD 1 1/2"

1 1/2"

STORM KEEPER

(ST-1)

9. SHGC= SOLAR HEAT GAIN COEFF


			WINDOV	V/LOUVE	ĪR .		F	RAME	(	SLASS				DE	TAILS		DEM	ADICO
SYMBOL		R.O. WIDTH	R.O. HEIGHT	SILL HEIGHT	MATERIAL	FINISH	MATERIAL	FINISH	MATERIA		TIN (OUTER	SURF)	HEAD	JAMB	SILL	MISC	KEW	ARKS
<u>W-1</u>	A*	±3'-0"(E) VIF	4'-0"	2'-10"	EXTRUDED ALUM	DARK BRONZE ANOD	EXTRUDED ALUM	DARK BRONZE ANOD	7/16" LAM GLASS	SAFETY	COEFF SHA	DE= 0.5	4 /A7.2	3 /A7.2	4 /A7.2		* EXTERI	OR ASS'BLY
<u>W-2</u>			5'-0"															
(W-3)	<u> </u>	3'-0"	4'-0"	•									<b></b>	<u> </u>				
(W-4)	B*	2'-0"	2'-0"	5'-0"					5/16" LAM FROSTED (	SAFETY SLASS	<del></del>		7 /A7.2	6 /A7.2	7 /A7.2			
W-5																		
<u>W-6</u>																		
(W-7)	<u> </u>	<u> </u>		<b>1</b>					<b>1</b> (10)				ļ	ļ .		<b>1</b>		
(W-8)	B* ●	3'-0"	4'-0"	3'-0"					7/16" LAM GLASS	SAFETY S	COEFF SHA	DE= 0.5	<sup>2</sup> /A7.2	1/A7.2	<sup>2</sup> /A7.2	—— •		
(W-9)																		
(W-10)																		
(W-11)														<sup>5</sup> /A7.2				
(W-12)																		
<u>W-13</u> )														<sup>1</sup> /A7.2				
(W-14)		<b> </b>							5 /4 0 <sup>2</sup> · · · · ·	- A								
(W-15)		2'-0"	1'-6"	4'-0"					5/16" LAM FROSTED (	SAFETY BLASS			/ <sub>A7.2</sub>	6 /A7.2				
<u>(W-16)</u>		3'-0"	3'-6"	3'-6"					7/16" LAM	) ) 	COEFF SHA	DE= 0.5	<sup>2</sup> /A7.2	<sup>1</sup> /A7.2	<sup>2</sup> /A7.2	<del></del>		
(W-17)																		


WOT TO SCRIPT


EDIZH G.MC

PROJECT-IN DOUBLE DOOR


AS SCH'ED -

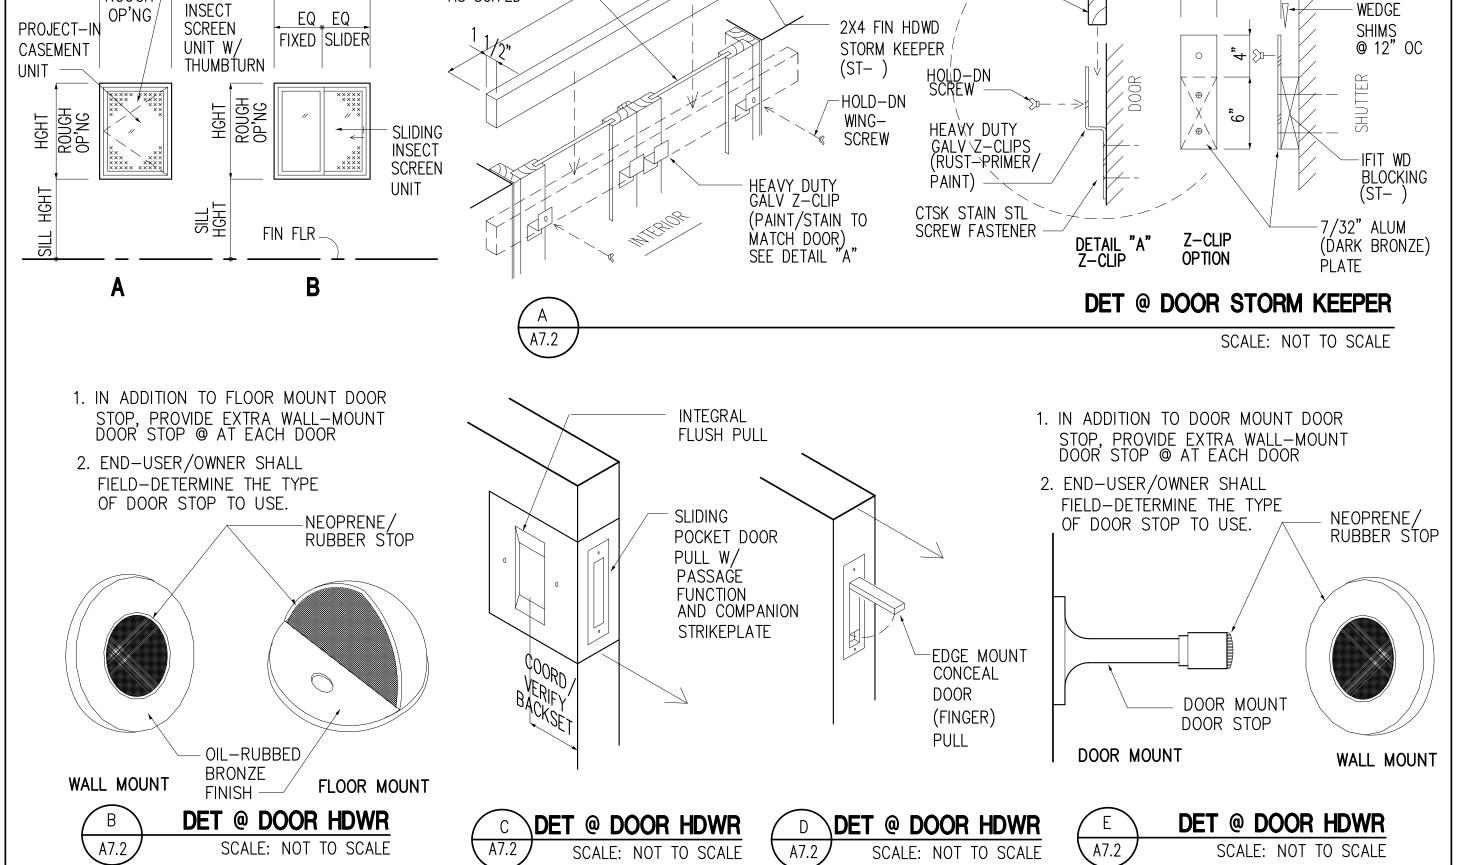


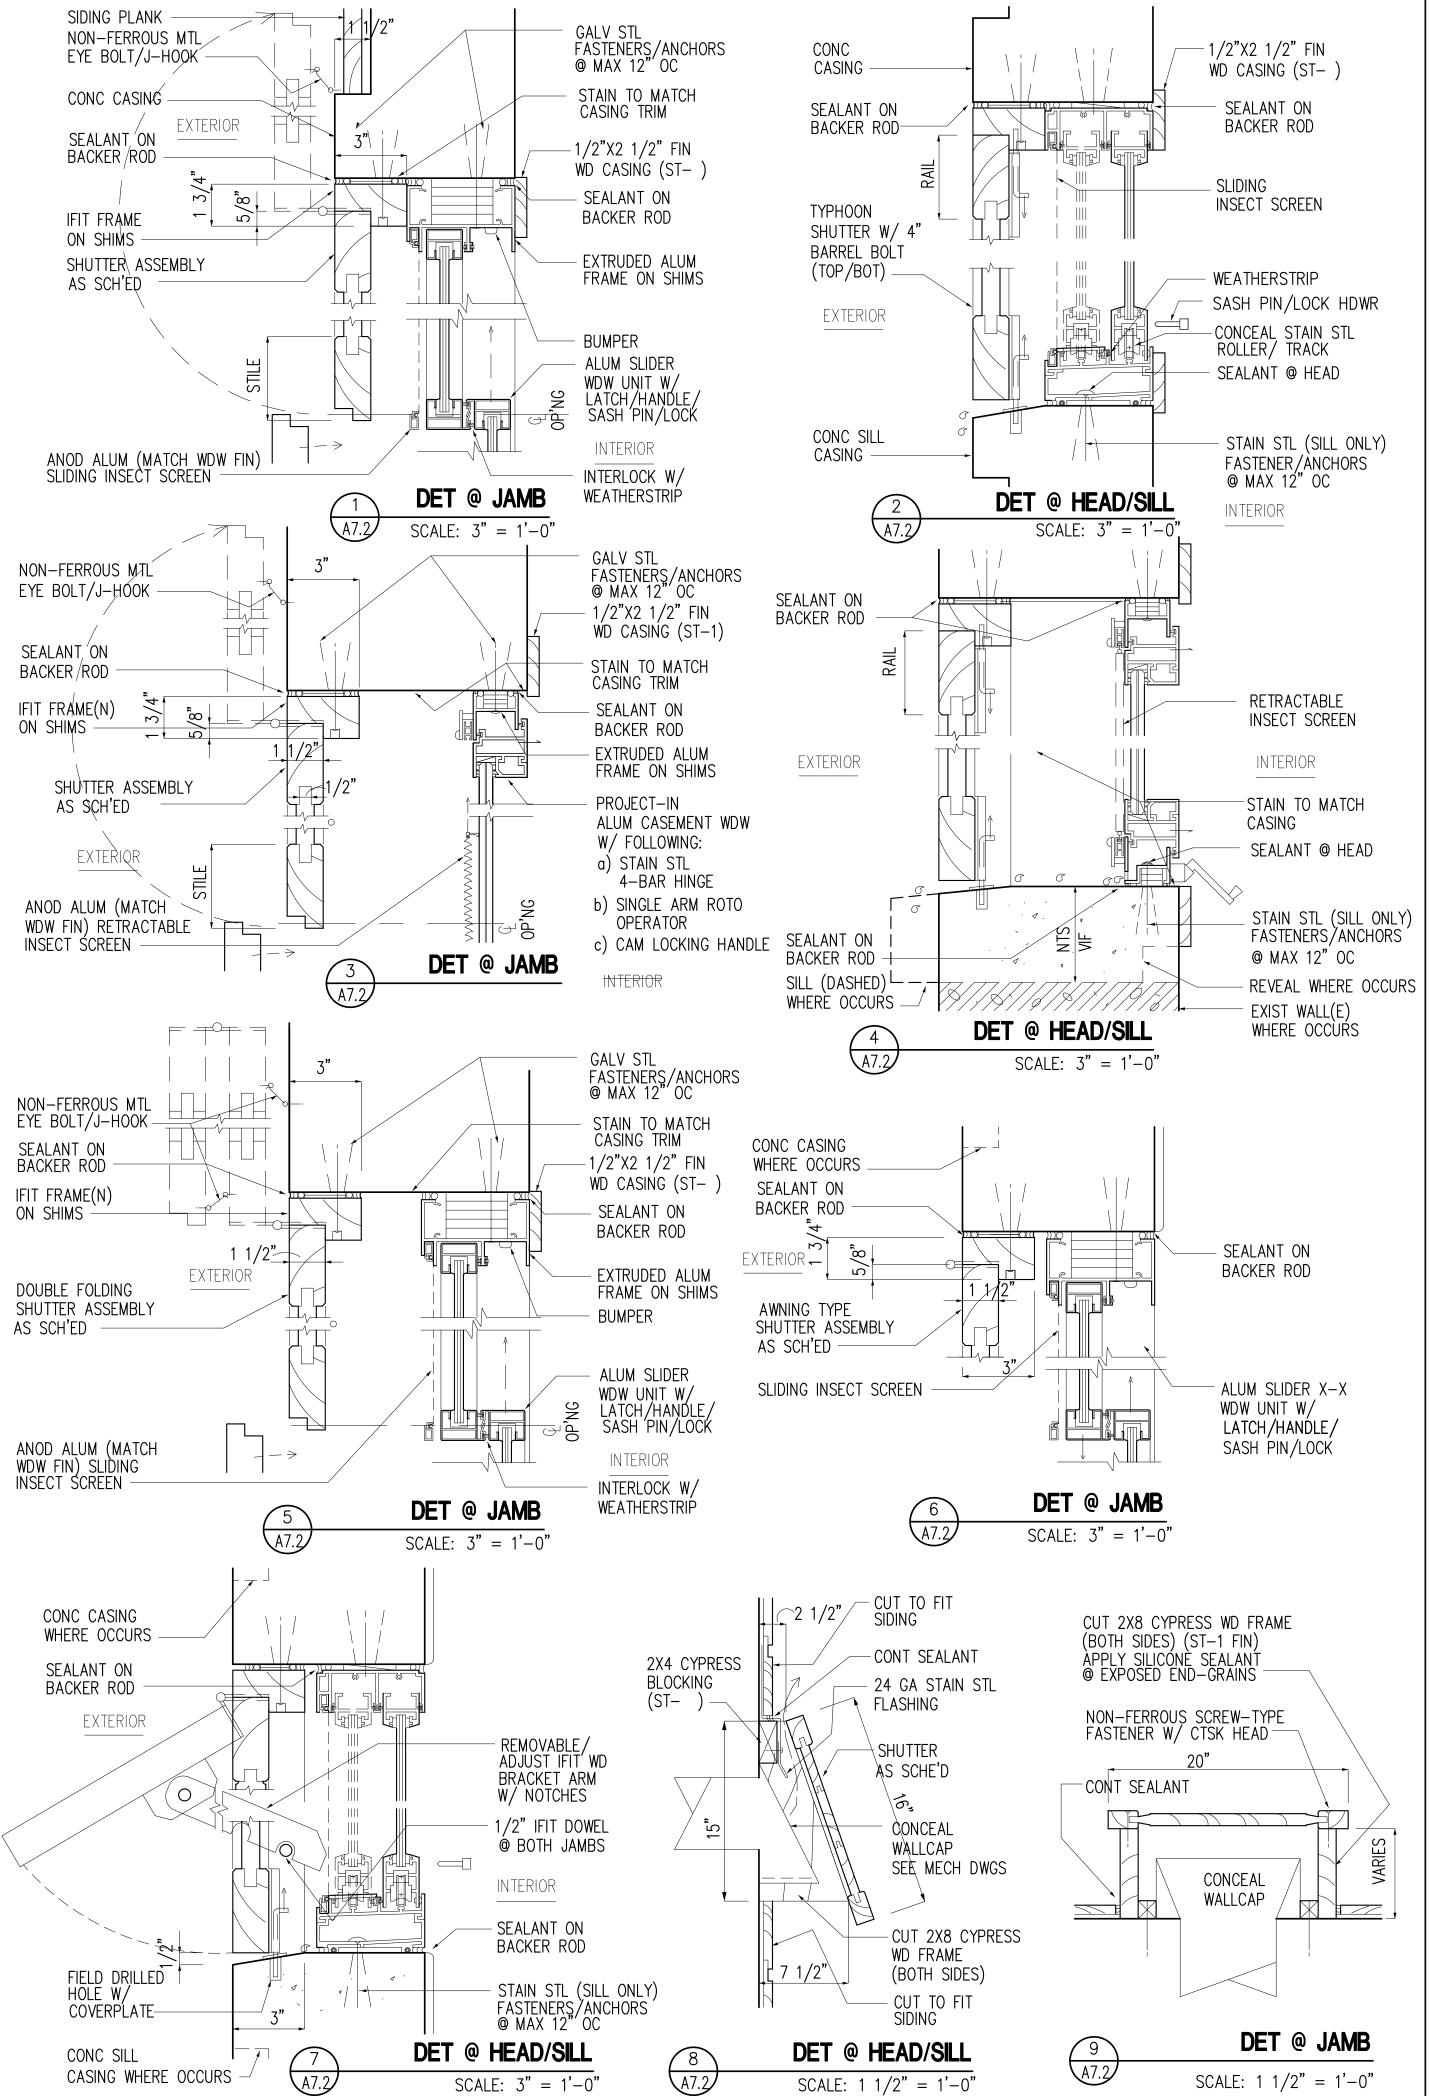

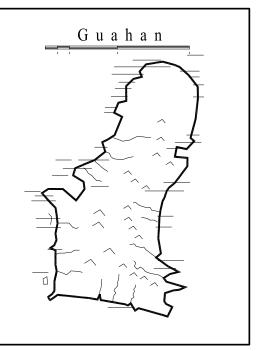

**GUAM PRESERVATION TRUST** INANGOKKON INADAHI GUÅHAN P.O. BOX 3036, HAGATNA, GUAM 96932 PROJECT TITLE: RECONSTRUCTION ANTONIA C. **CHARGUALAF** HOUSE, HISTORIC DISTRICT OF INARAJAN INARAJAN, GUAM DESIGN CONSULTANT: Provido · Tan · Jones architects inc. P.O. BOX 6463, TAMUNING, GUAM 96931 TEL: 671 646 1361 FAX: 671 646 2767 PTJA PROJECT NO: GPT.02 THIS WORK WAS DONE BY ME OR UNDER MY DIRECT SUPERVISION EXPIRATION DATE: APR, 2015 DRAWING NAME: WDW SCHEDULE DT DATE: NOV 201 CHECKED: LP | SCALE: AS NOTE **REVISIONS:** DESCRIPTION DRAWING SHEET NO:

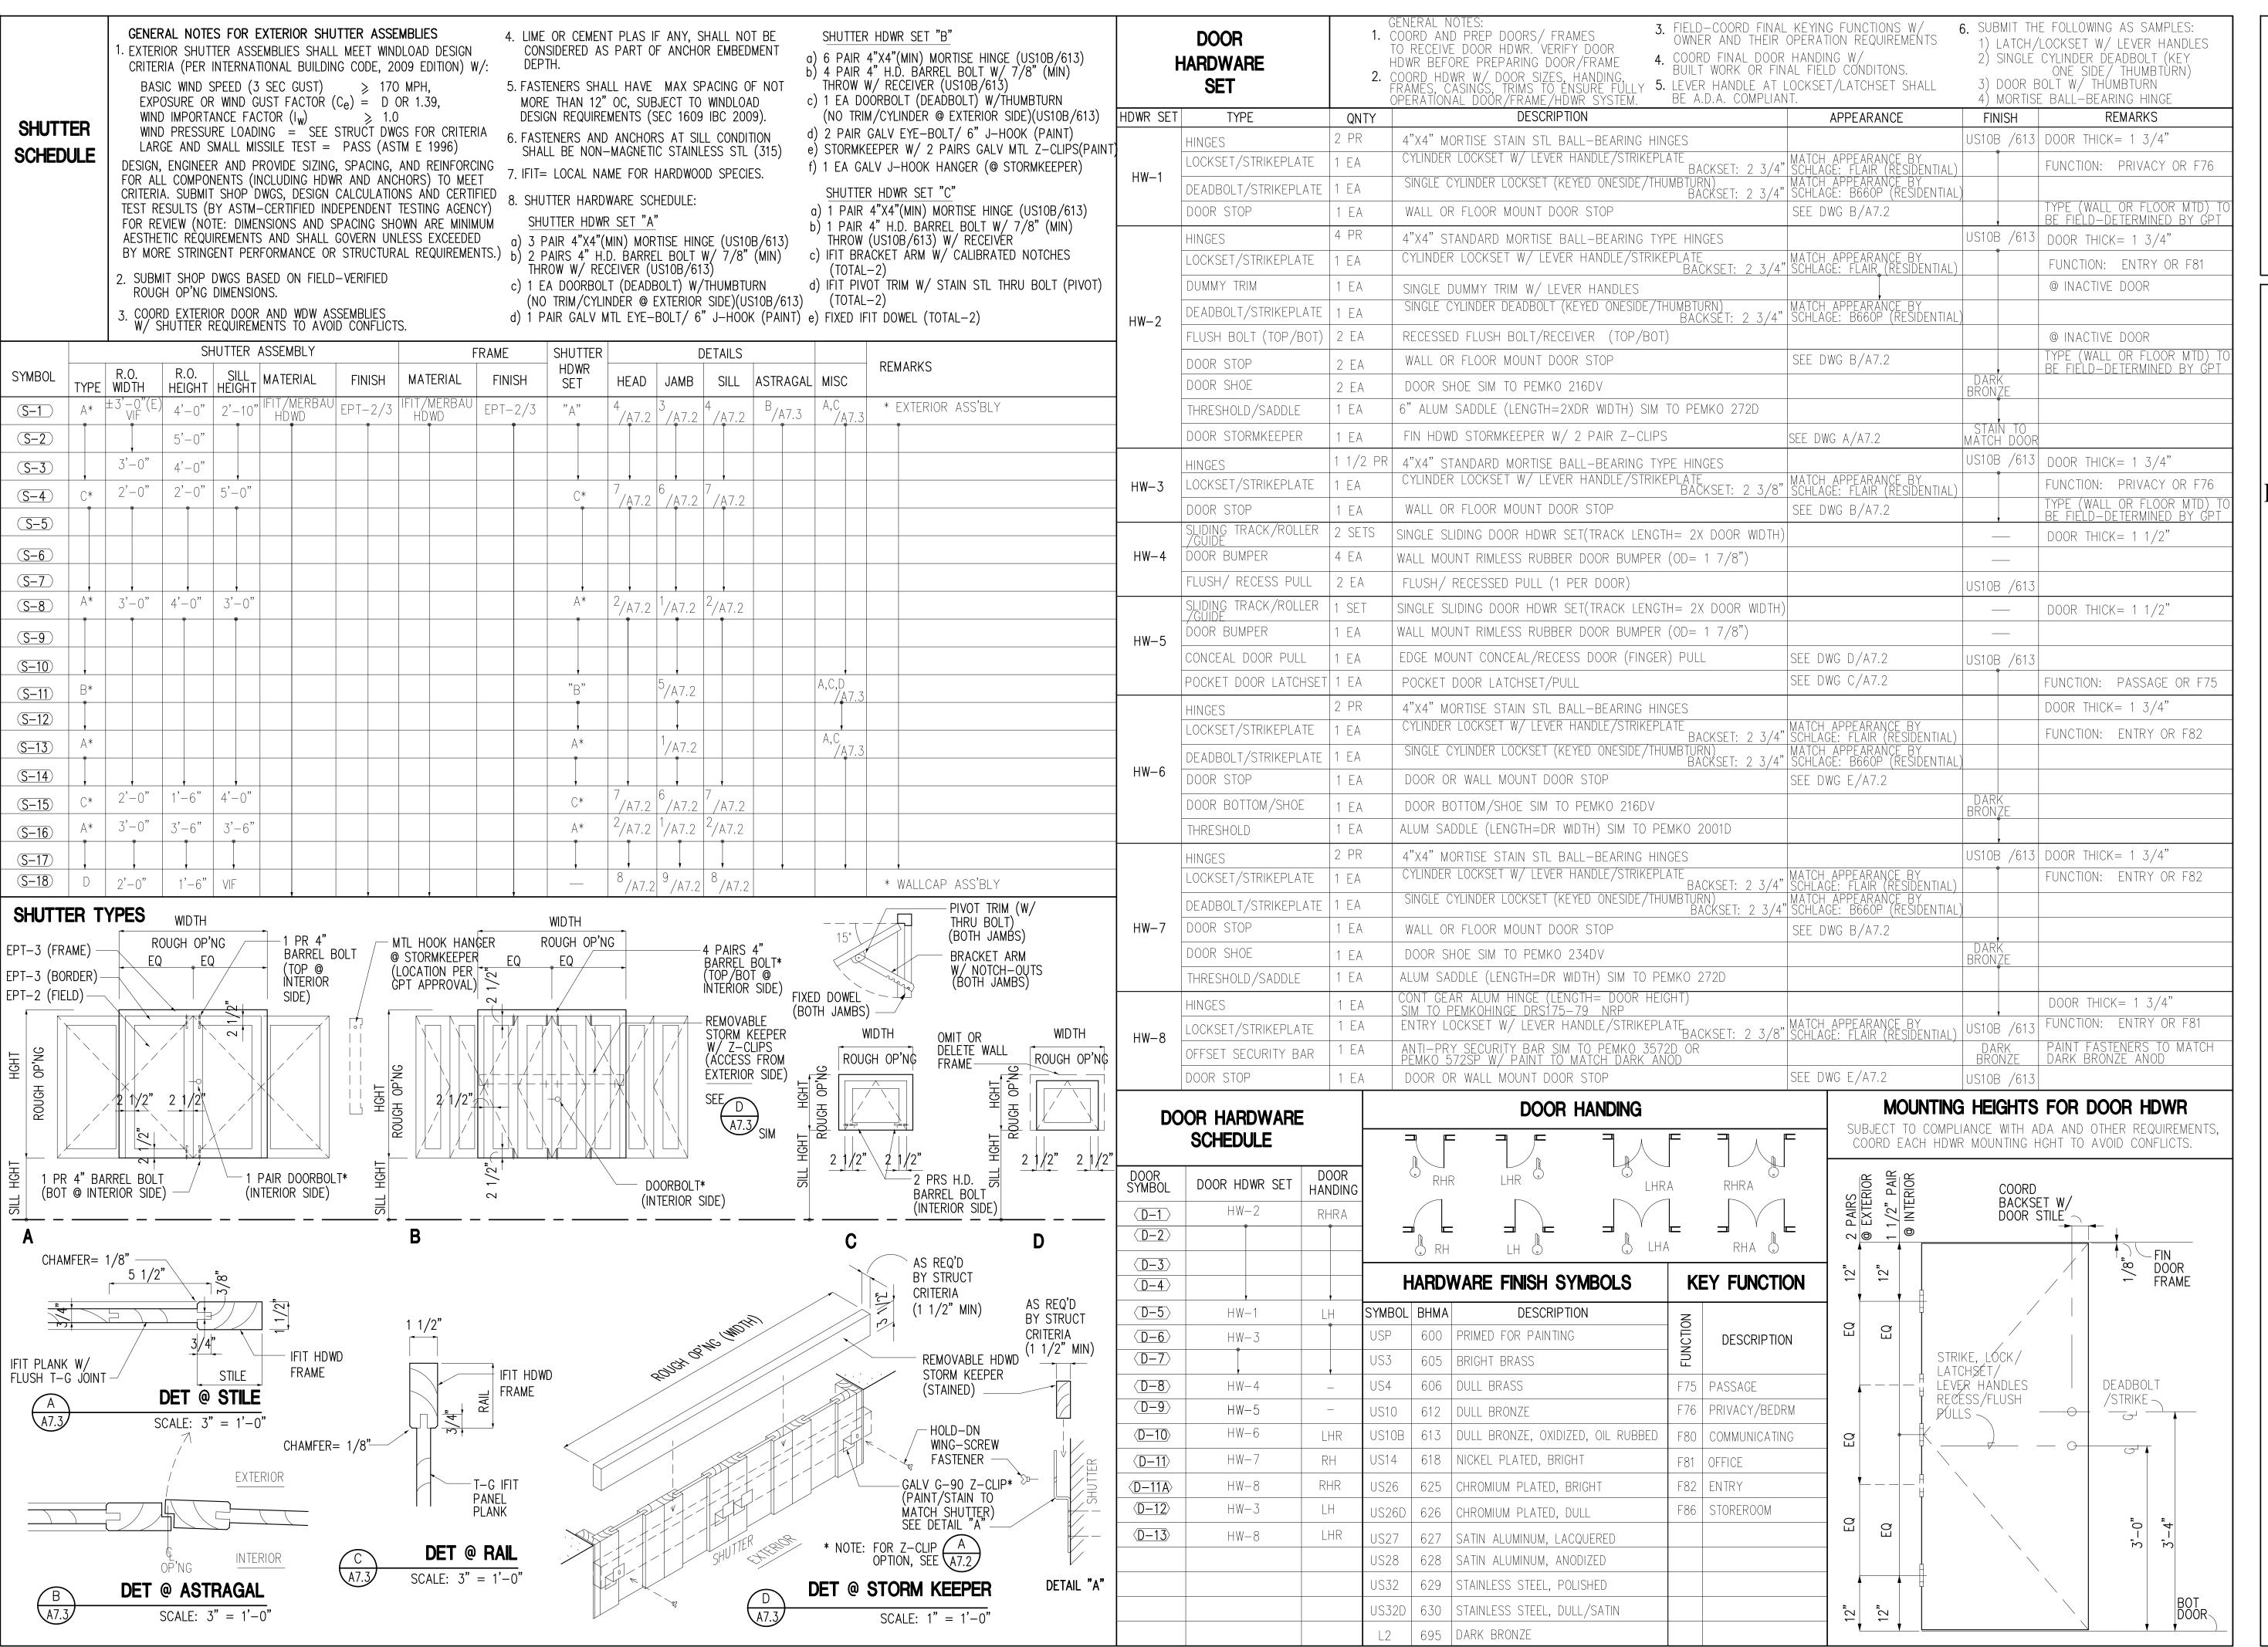

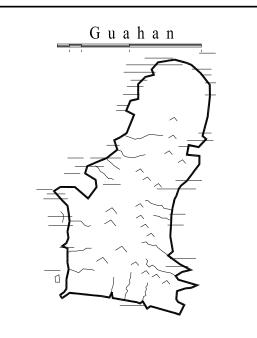

INANGOKKON INADAHI GUÅHAN P.O. BOX 3036, HAGATNA, GUAM 96932

OJECT TITLE:

RECONSTRUCTION of ANTONIA C. CHARGUALAF HOUSE,

> HISTORIC DISTRICT OF INARAJAN INARAJAN, GUAM

Provido Tan Jones
architects inc.



P.O. BOX 6463, TAMUNING, GUAM 96931 TEL: 671 646 1361 FAX: 671 646 2767

PTJA PROJECT NO: GPT.02

THIS WORK WAS DONE BY ME OR UNDER MY DIRECT SUPERVISION EXPIRATION DATE: APR, 2015

DRAWING NAME:

SHUTTER SCHEDULE


DRAWN: DT DATE: NOV 201
CHECKED: LP SCALE: AS NOTED


REVISIONS:

DESCRIPTION

DRAWING SHEET NO:

A7.3

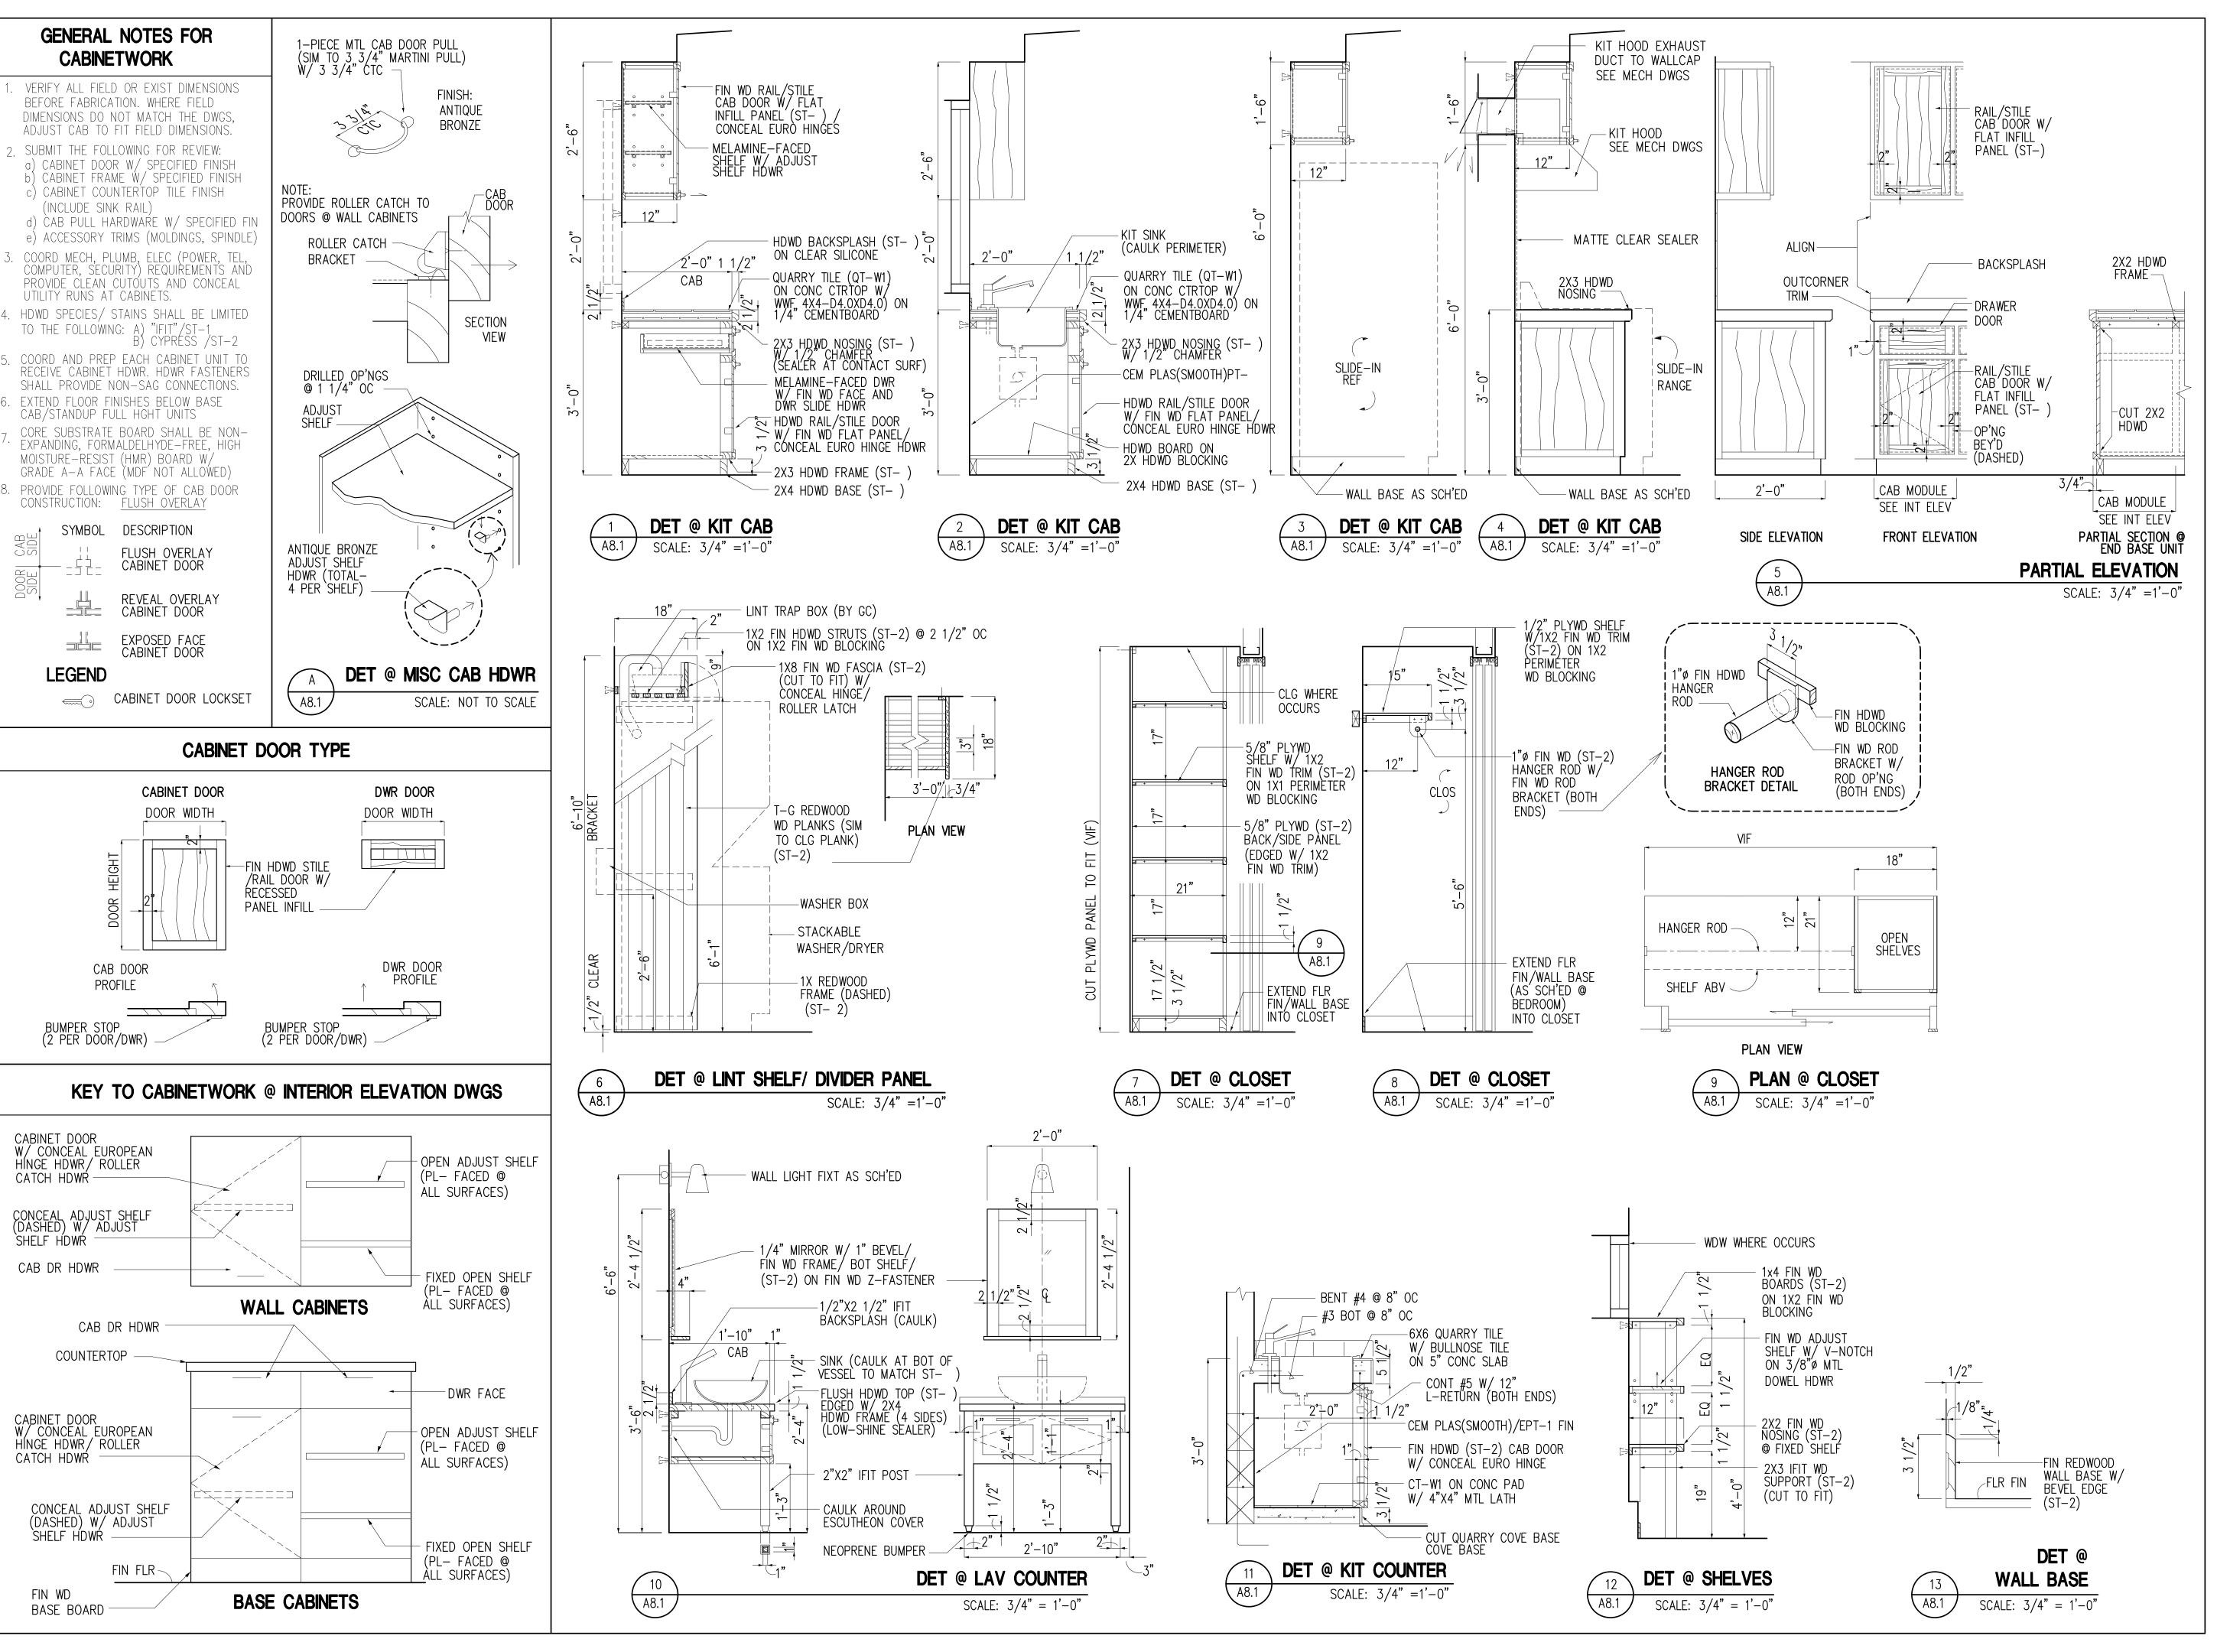

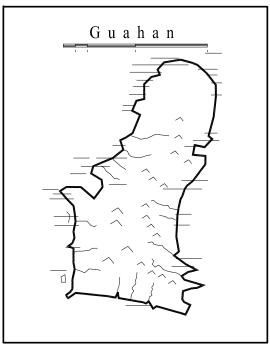

INANGOKKON INADAHI GUAHAN P.O. BOX 3036, HAGATNA, GUAM 96932


PROJECT TITLE:

RECONSTRUCTION of ANTONIA C. CHARGUALAF HOUSE,

> HISTORIC DISTRICT OF INARAJAN INARAJAN, GUAM

DESIGN CONSULTANT:

Provido • Tan • Jones
architects inc.

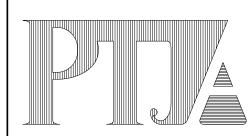

P.O. BOX 6463, TAMUNING, GUAM 96931 TEL: 671 646 1361 FAX: 671 646 2767

PTJA PROJECT NO: GPT.02

THIS WORK WAS DONE BY ME OR UNDER MY DIRECT SUPERVISION EXPIRATION DATE: APR, 2015

CABINETWORK

DRAWING NAME:

DRAWN: DT DATE: NOV 2014

CHECKED: LP SCALE: AS NOTED

REVISIONS:


DESCRIPTION

DRAWING SHEET NO:

A8.1

#### ACI 318-08 MINIMUM DEVELOPMENT REQUIREMENTS OF STANDARD HOOKS IN TENSION (fy=60,000 psi FOR UNCOATED OR GALVANIZED COATED DEFORMED BARS)


BAR SIZE	MINIMUM HO (HL) REQUIF (INC)		l ah= "C" (DEVEL REQUIREMENT FROM (INC+	MINIMUM BEND DIAMETER (D) (INCHES)	
	90° (a)	180° (b)	3000 psi (c)	4000 psi (c)	
#3	6	4	6	6	2  /4"
#4	8	5	8	7	3"
#5	10	5	10	9	3 3/4"
#6	12	6	12	10	4 1/2"
#7	14	7	14	12	5 1/4"
#8	16	8	16	14	6"
#9	20	II	18	15	9"
#10	22	12	20	ΙΤ	10"

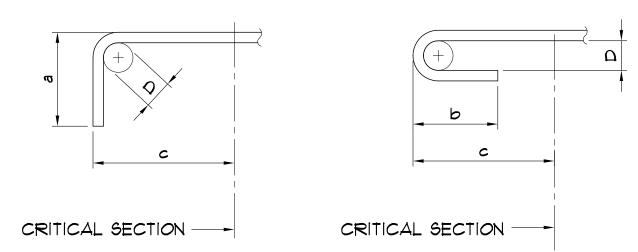

#### PRIMARY REINFORCING TYPICAL BENDS SCALE: NOT TO SCALE

ACI 318-08 (SECTION 7.1.3) MINIMUM DEVELOPMENT REQUIREMENTS OF HOOPS
AND CROSS TIES
(fy=60,000 psi FOR UNCOATED OR GALVANIZED COATED DEFORMED BARS)
MINIMUM HOOK LENGTH (HL) REQUIREMENTS MINIMUM BEND

1			
BAR SIZE	MINIMUM HOOK LENGT (INCH	MINIMUM BEND DIAMETER (D)	
)	90°(d)	135° (e)	(INCHES)
#3	4	5	2 1/4"
#4	5	5	3"
<b>*</b> 5	٦	٦	3 3/4"
#6	14	9	4 ½"
#7	16	11	5 1/4"
#8	18	12	6"

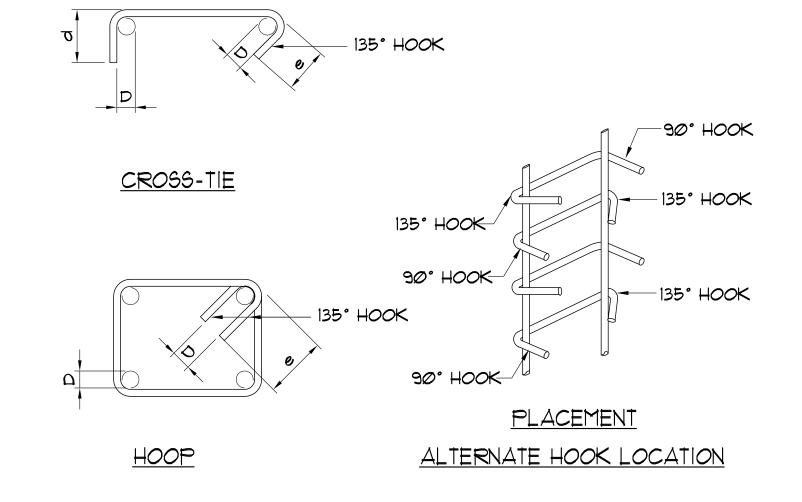

#### ACI 318-08 MINIMUM DEVELOPMENT (EMBEDMENT AND LAP REQUIREMENTS) (fy=60,000 psi FOR UNCOATED OR GALVANIZED COATED DEFORMED BARS)

BAR	MINIMUM EMBEDMENT			MINIMUM LAP REQUIREMENTS (INCHES)						BAR			
SIZE	REQUIREMENTS (INCHES)				CLASS "A" SPLICE			CLASS "B" SPLICE			SIZE		
	f'c = 3000 psi f'c = 4000 psi			f'c = 3000 psi f'c = 4000 psi		f'c = 3000 psi f'c = 4000 psi			000 psi				
	TOP 2	OTHERS	TOP 2	OTHERS	TOP 2	OTHERS	TOP 2	OTHERS	TOP 2	OTHERS	TOP 2	OTHERS	
#3	21	16	18	14	21	16	18	14	27	21	23	18	#3
#4	28	22	25	19	28	22	25	19	36	29	33	25	#4
#5	36	27	31	24	36	27	31	24	47	35	40	31	#5
#6	43	33	37	28	43	33	37	28	56	43	48	36	#6
#7	62	48	54	42	62	48	54	42	81	62	70	55	#7
#8	71	55	62	47	71	55	62	47	92	72	81	61	#8
#9	80	62	70	54	80	62	70	54	104	81	91	70	#9
#10	90	70	78	60	90	70	78	60	117	91	101	78	#10

#### EMBEDMENT AND LAP NOTES

- PROVIDE STANDARD ACI 90 DEGREE BEND OR HOOK IF EMBEDMENT LENGTH IS LESS THAN REQUIRED MINIMUM AS SHOWN IN TABLE, REINFORCEMENT IN WALLS, SLAB, BEAM, ETC. SHALL BE EMBEDDED INTO SUPPORTING OR INTERSECTING STRUCTURAL ELEMENTS.
- 2. TOP BARS ARE DEFINED WHERE HORIZONTAL REINFORCEMENT IS PLACED SUCH THAT MORE THAN 12 INCHES OF FRESH CONCRETE IS CAST BELOW THE DEVELOPMENT LAP OR SPLICE.
- 3. FOR SLABS, LOCATE LAPS WITHIN THE MIDDLE THIRD OF THE SPANS FOR TOP BARS AND AT SUPPORTS FOR BOTTOM BARS. USE "CLASS A" SPLICE IF LAPS ARE STAGGERED. OTHERWISE USE "CLASS B" SPLICE.
- 4. FOR WALLS, LOCATE LAPS ANYWHERE AND USE "CLASS B" SPLICE, FOR DOUBLE CURTAIN REINFORCEMENT, STAGGER LOCATION OF LAP FROM ONE CURTAIN TO ANOTHER.
- 5. FOR BEAMS AND COLUMNS, LOCATE LAPS AS SHOWN IN DETAILS, USE "CLASS B" SPLICES UNLESS NOTED OTHERWISE.
- 6. FOR DEVELOPMENT LENGTH FOR INDIVIDUAL BARS WITHIN A BUNDLE, THE DEVELOPMENT LENGTH SHALL BE THAT OF THE INDIVIDUAL BAR, INCREASED 20 PERCENT FOR THE THREE-BAR BUNDLES AND 33 PERCENT FOR THE FOUR BAR BUNDLES.

#### GENERAL STRUCTURAL NOTES

- REFER TO ARCHITECTURAL DRAWINGS FOR ALL MAMPOSTERIA WALL DAMAGES AND/OR DEFECTS AND RECOMMENDED REPAIRS.
- 2. PRIOR TO START OF CONSTRUCTION THE CONTRACTOR SHALL CONDUCT ITS OWN INDEPENDENT INSPECTIONS TO IDENTIFY AND DOCUMENT ALL DAMAGES AND DEFECTS TO THE MAMPOSTERIA WALL STRUCTURE TO DATE. THE CONTRACTOR SHALL IMMEDIATELY SUBMIT ITS FINDINGS TO THE ARCHITECT AND SHALL IDENTIFY AND NOTIFY THE ARCHITECT OF ANY DISCREPANCIES THAT WILL DRASTICALLY AFFECT THE DESIGN INTENT AND COST OF THIS PROJECT.
- 3. "GENERAL NOTES AND TYPICAL DETAILS" APPLY TO ALL DRAWINGS UNLESS NOTED OR SHOWN OTHERWISE.
- 4. FEATURES OF CONSTRUCTIONS SHOWN ARE TYPICAL AND THEY SHALL APPLY GENERALLY THROUGHOUT FOR SIMILAR CONDITIONS.
- 5. BUILDING DIMENSIONS SHALL BE COORDINATED WITH ARCHITECTURAL DRAWINGS UNLESS SHOWN OTHERWISE. CONTRACTOR SHALL VERIFY ALL DIMENSIONS BEFORE COMMENCEMENT WORK IS BEGUN.
- 6. REFER TO ARCHITECTURAL DRAWINGS FOR LIMITS AND SCOPE OF WORK FOR ALL DEMOLITION WORK.
- 7. REFER TO THE ARCHITECTURAL DRAWINGS FOR THE LIMITS AND ALL EXISTING MAMPOSTERIA WALLS INDICATED "TO REMAIN."
- 8. CONTRACTOR SHALL REPLACE ALL BOLTED, SCREWED AND/OR NAILED CONNECTIONS AFFECTED BY THE REPLACEMENT OF ALL NEW WOOD MEMBERS AND SHALL MATCH THE EXISTING "IN-KIND." ALL REPLACEMENT CONNECTIONS SHALL BE MADE OF STAINLESS STEEL OR APPROVED EQUAL.
- 9. CONTRACTOR SHALL INSPECT ALL EXPOSED AND/OR UNCOVERED BOLTED, SCREWED AND/OR NAILED CONNECTIONS AND SHALL REPLACE ALL SEVERELY CORRODED CONNECTIONS TO MATCH EXISTING "IN-KIND." ALL REPLACEMENT CONNECTIONS SHALL BE MADE OF STAINLESS STEEL OR APPROVED EQUAL.

#### STRUCTURAL DESIGN CRITERIA

- I. BASIS OF DESIGN: 2009 INTERNATIONAL BUILDING CODE, ASCE 7-05
- 2. LIVE LOAD

RESIDENTIAL ROOM = 40 PSF **ROOF = 20 PSF** STAIRS & BALCONY = 100 PSF

3. WIND FORCE: (ASCE 7-05) BASIC WIND SPEED = 170 MPH

EXPOSURE CATEGORY: C IMPORTANCE FACTOR, IN = 1.0

WIND PRESSURE, P = qz GCp - qh (GCpi)

GUST FACTOR, G = 0.85

Cp = EXTERNAL PRESSURE COEFFICIENT FROM ASCE 7-05 FIG. 6-6 OR 6-8

(GCDI) = INTERNAL PRESSURE COEFFICIENT FROM ASCE 7-05 FIG. 6-5

VELOCITY PRESSURE, qz = 0.00256 Kz Kzt Kd Iw  $V^2$  PSF

WHERE: TOPOGRAPHIC FACTOR, Kzt = 1.0

WIND DIRECTIONALITY FACTOR, Kd = 0.85

Kz IS THE VELOCITY PRESSURE EXPOSURE COEFFICIENT Kz = 2.01  $(z/zg)^{2/C}$  FOR IS FEET  $\le z \le zg$  Kz = 2.01  $(15/zg)^{2/C}$  FOR z < 15 FEET

Z = THE VERTICAL DISTANCE FROM SPECIFIED GROUND LEVEL TO ELEMENT CENTROID

za AND € ARE SPECIFIED IN ASCE 7-05 TABLE 6-2

gh = THE VELOCITY PRESSURE AT MEAN ROOF HEIGHT

#### 4. SEISMIC FORCE (IBC 2009)

ECCENTRICITY RATIO = 5% RESPONSE MODIFICATION FACTOR, R = 5 OCCUPANCY IMPORTANCE FACTOR = 1.0 0.2 SECOND SPECTRAL RESPONSE ACCELERATION (5% OF CRITICAL DAMPING), Ss = 1.5 q I SECOND SPECTRAL RESPONSE ACCELERATION (5% OF CRITICAL DAMPING), SI = 0.60 a

SITE CLASS: D OCCUPANCY CATEGORY: II

LONG-PERIOD TRANSITION PERIOD = 12

SEISMIC DESIGN CATEGORY: D

Sds = 1.0 a  $5dl = 0.6 \ a$ 

5. REINFORCED CONCRETE

FOOTING: f'c = 3,000 PSI SLAB ON GRADE: f'c = 3,000 PSI COLUMNS, WALLS, BEAMS, SUSPENDED SLAB: - f'c = 4.000 PSI f'c = 4,000 PSI

6. MASONRY

f'm = 1,350 PSI f'c = 2,000 PSI

ALL CELLS GROUTED, SPECIAL INSPECTION REQUIRED

7. REINFORCEMENT

REINFORCING STEEL -FY = 60,000 PSI

#### 8. LOAD COMBINATIONS (IBC 2009)

1.4 (DL) DL = DEAD LOAD 1.2 (DL) + 1.6 (FL) + 0.5 (RL) FL = FLOOR LOAD 1.2 (DL) + 1.6 (RL) + 1.0 (FL) OR 0.8 (WLX / WLY) RL = ROOF LOAD 1.2 (DL) + 1.6 (WLX / WLY) + 1.0 (FL) + 0.5 (RL) ML = MIND LOAD 1.4 (DL) + 1.0 (EQX / EQY) + 1.0 (FL) EQ = EARTHQUAKE LOAD


0.9 (DL) + 1.6 (WLX / WLY) COMB6: WR = ROOF WIND LOAD 0.7 (DL) + 1.0 (EQX / EQY)

#### 9. CONCRETE COVERING

TOP OF ROOF SLABS BOTTOM OF ROOF SLABS TOP & BOTTOM INTERIOR TOP & BOTTOM EXTERIOR FLOOR & ROOF SLABS WALLS (SMALLER THAN 10") WALLS (10" AND WIDER) BEAMS (12" OR SMALLER) BEAMS (WIDER THAN 12") COLUMNS WALL EXPOSED TO EARTH FORMED FOOTINGS FOOTINGS CAST AGAINST EARTH

IO. ALLOWABLE SOIL BEARING PRESSURES

DL + LL DL + LL + Wind (Earthquake) 2,000 psf 3,500 psf

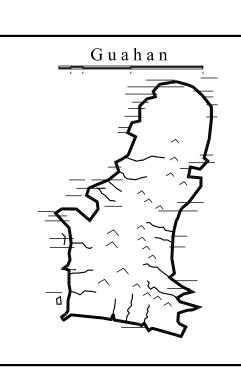

#### **GUAM PRESERVATION TRUST**


INANGOKKON INADAHI GUAHAN P.O. BOX 3036, HAGATNA, GUAM 96932

#### PROJECT TITLE:

RECONSTRUCTION ANTONIA C. CHARAGUALAF HOUSE, HISTORIC DISTRICT

> INARAJAN INARAJAN, GUAM

DESIGN CONSULTANT: │ Provido •Tan • Jones

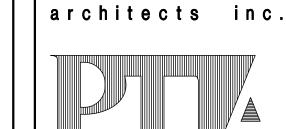

P.O. BOX 6463, TAMUNING, GUAM 96931 TEL: 671 646 1361 FAX: 671 646 2767



BY ME OR UNDER MY DIRECT SUPERVISION

#### DRAWING NAME:

STRUCTURAL DESIGN CRITERIA GENERAL NOTES TYPICAL DETAILS

DATE: MARCH 2015

SCALE: AS NOTED **REVISIONS:** 


SONII IION	UA.


DRAWING SHEET NO:

**S0.1** 

SHEET \_\_\_\_ OF \_\_\_

TYP. HOOPS AND CROSS-TIES DETAIL SCALE: NOT TO SCALE

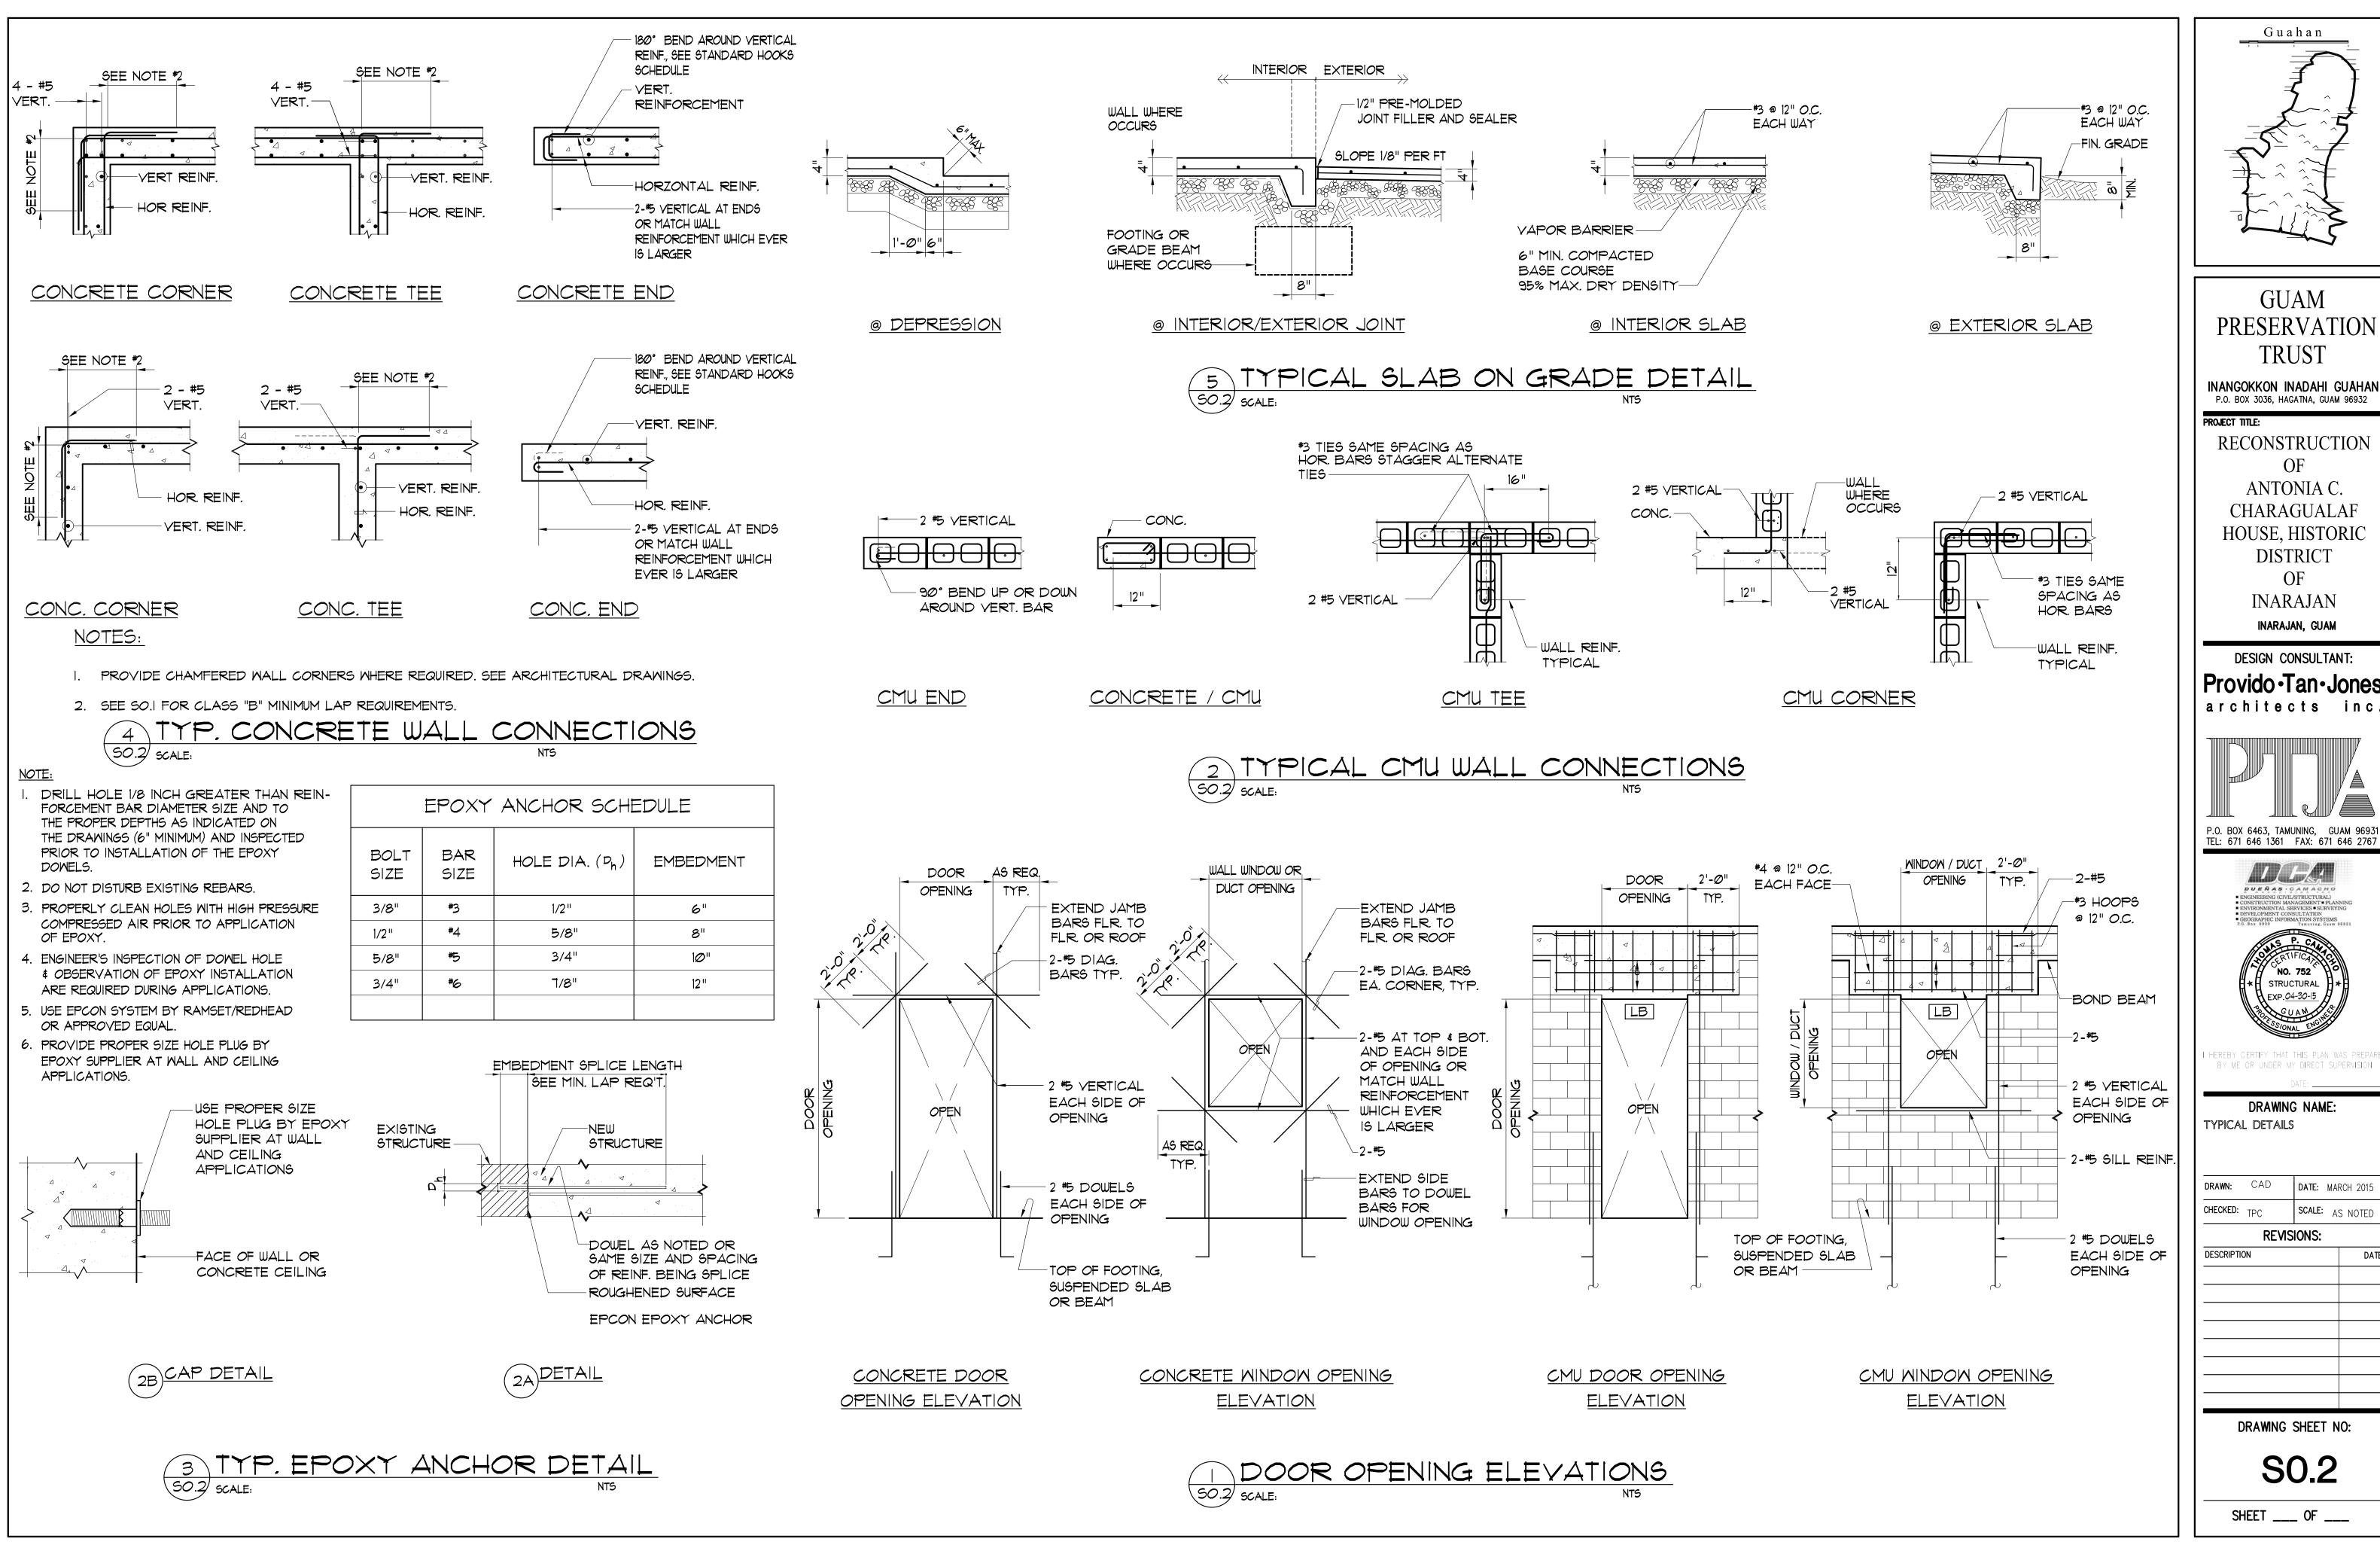

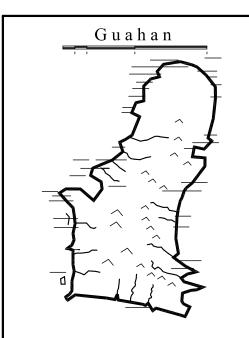


INANGOKKON INADAHI GUAHAN P.O. BOX 3036, HAGATNA, GUAM 96932

#### PROJECT TITLE:

RECONSTRUCTION ANTONIA C. CHARAGUALAF HOUSE, HISTORIC DISTRICT

INARAJAN INARAJAN, GUAM

#### DESIGN CONSULTANT: Provido · Tan · Jones

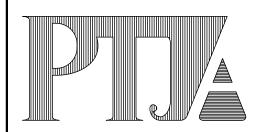

P.O. BOX 6463, TAMUNING, GUAM 96931 TEL: 671 646 1361 FAX: 671 646 2767



DRAWING NAME: TYPICAL DETAILS


BY ME OR UNDER MY DIRECT SUPERVISION


DRAWN: CAD DATE: MARCH 2015 SCALE: AS NOTED

**REVISIONS:** DESCRIPTION

DATE

DRAWING SHEET NO:

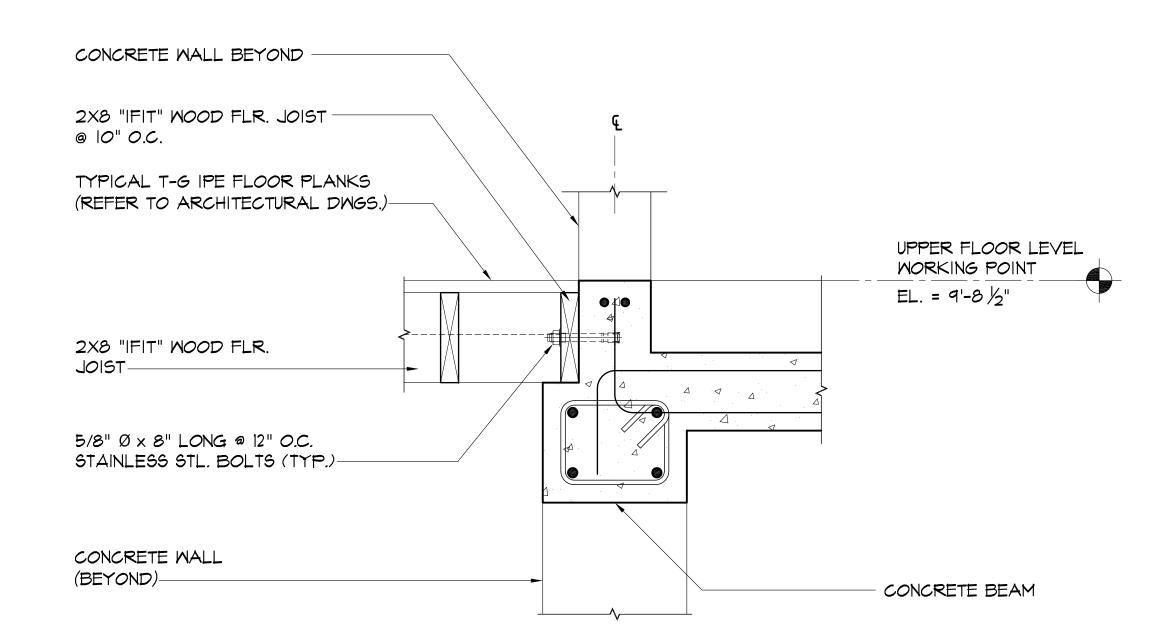


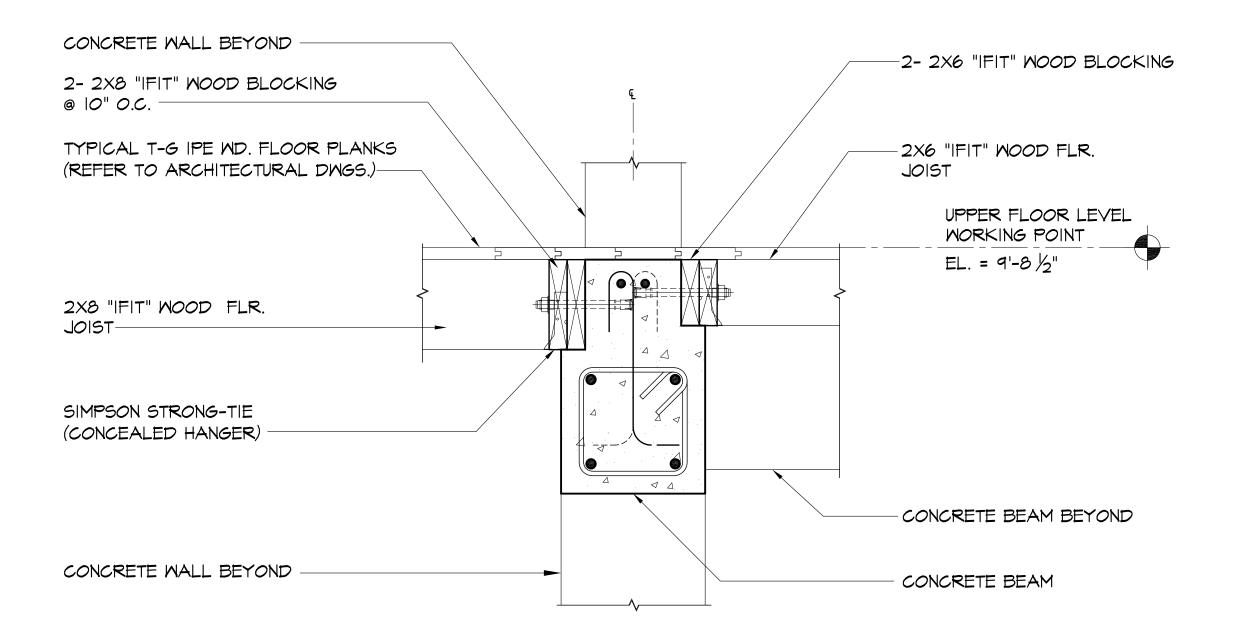

2 @ JOIST SIDE TO FLOOR BEAM

50.3 SCALE: TYP. CONNECTION DETAIL

TYP. CONNECTION DETAIL @ JOIST END TO FLOOR BEAM 50.3 SCALE: | |/2"= |'-0"

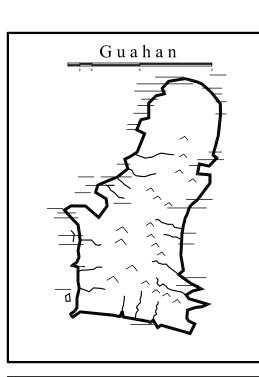

#### **GUAM PRESERVATION TRUST**

INANGOKKON INADAHI GUAHAN P.O. BOX 3036, HAGATNA, GUAM 96932

#### PROJECT TITLE:

RECONSTRUCTION ANTONIA C. CHARAGUALAF HOUSE, HISTORIC DISTRICT INARAJAN INARAJAN, GUAM

#### DESIGN CONSULTANT: Provido ·Tan · Jones architects inc.





DRAWING NAME:

TYPICAL DETAILS


DRAWN: AGC DATE: MARCH 2015 CHECKED: TPC SCALE: AS NOTED

**REVISIONS:** 

DESCRIPTION	D

DRAWING SHEET NO:

**S0.3** SHEET \_\_\_\_ OF \_\_\_\_

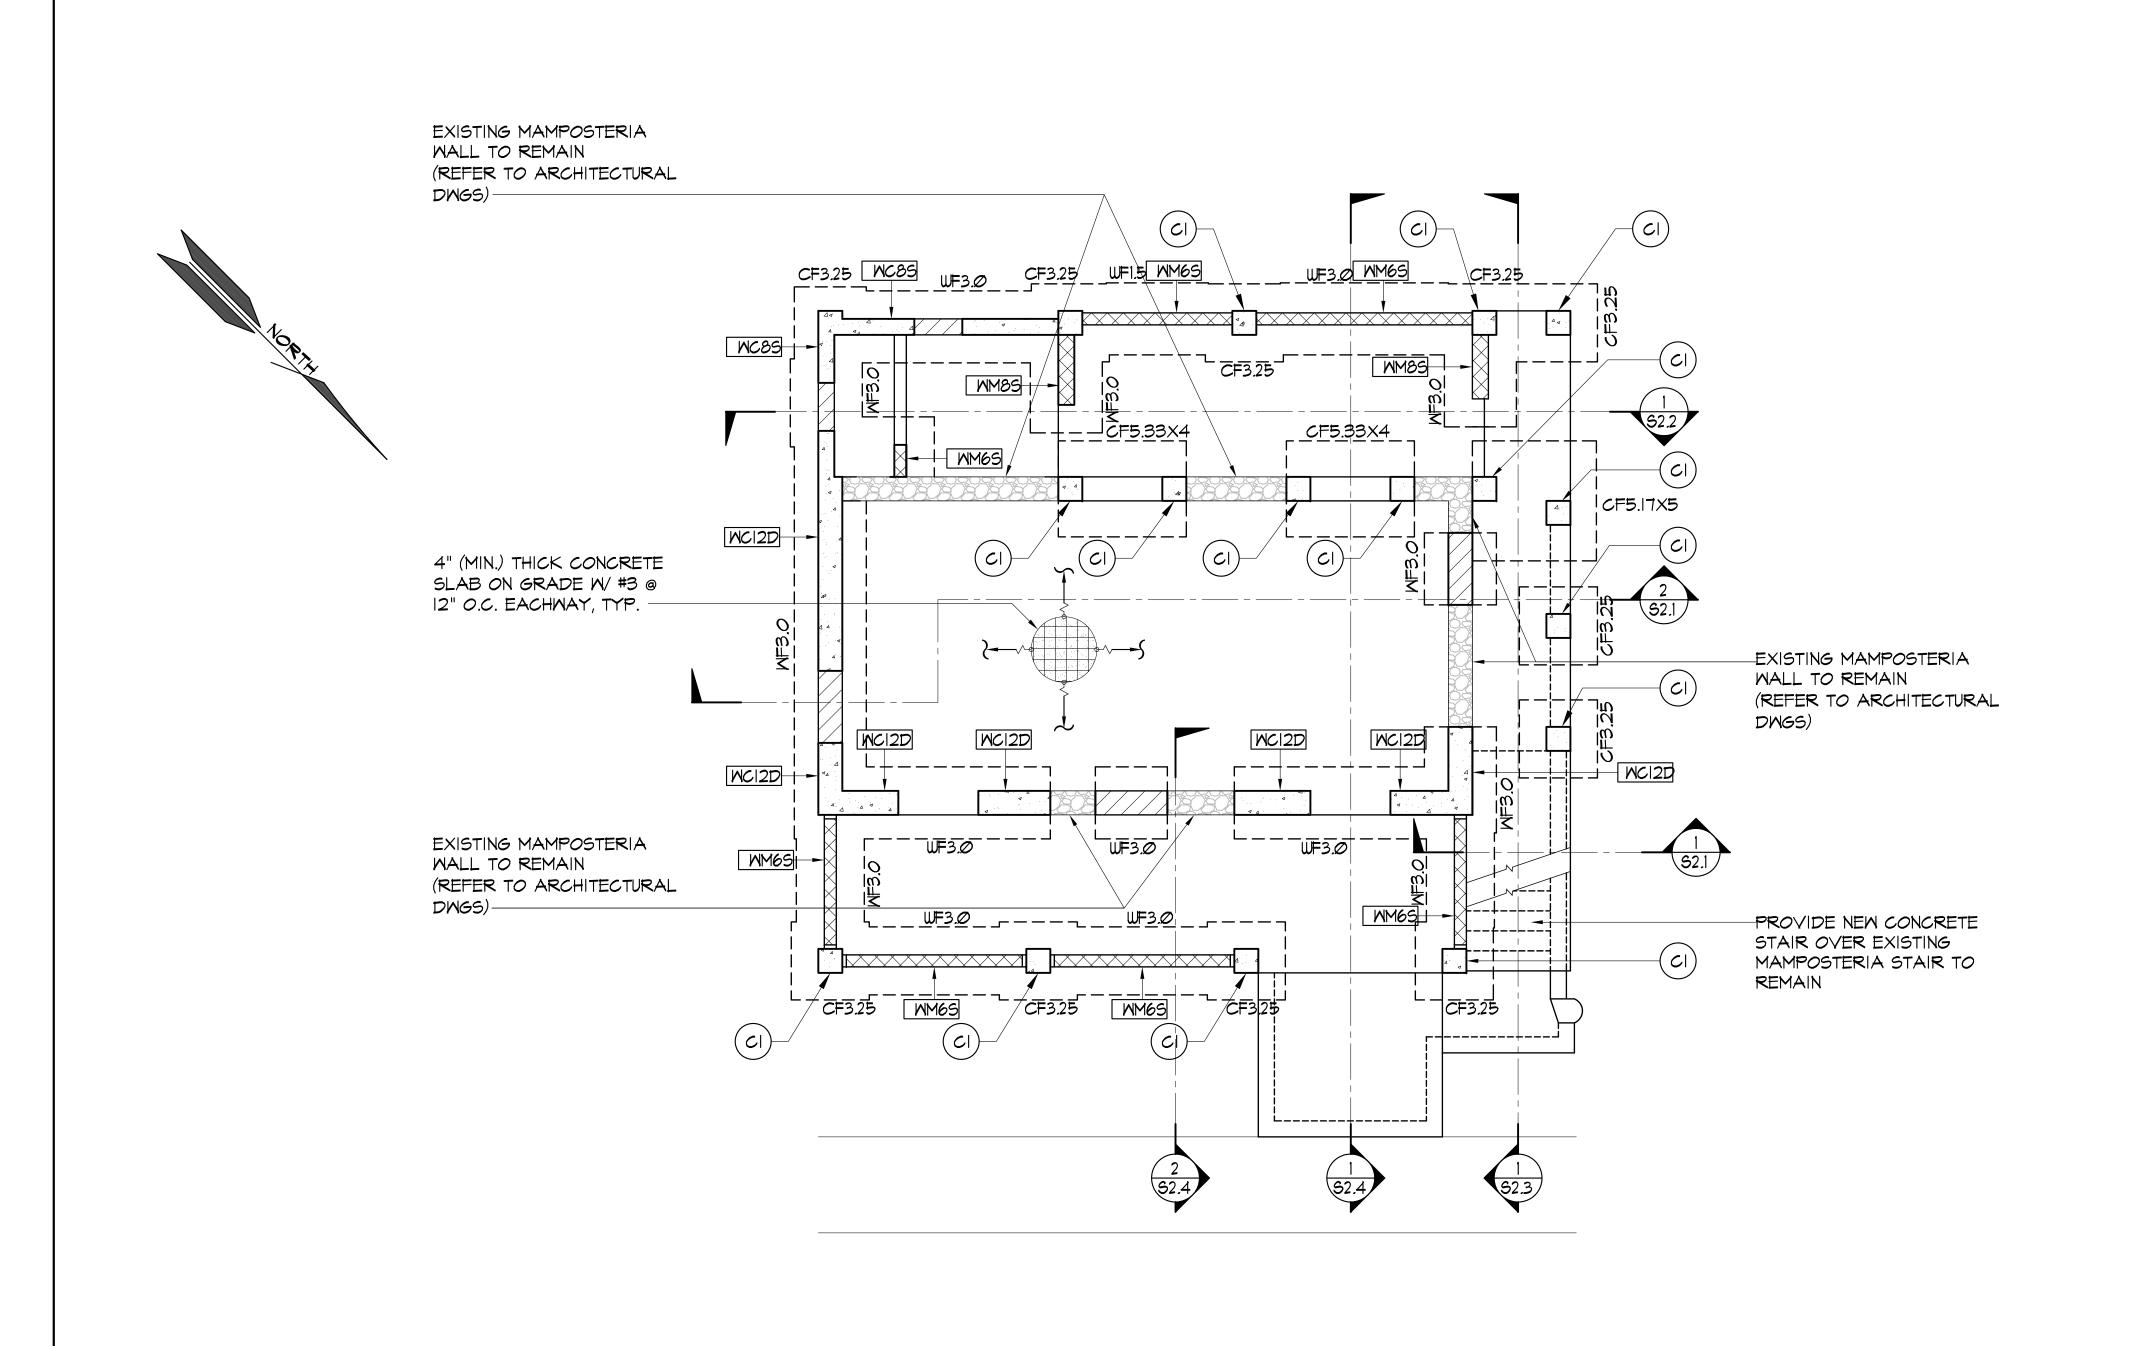


FOUNDATION PLAN

1/4"=1'-0"

SI.I SCALE:

#### WALL DESIGNATION:

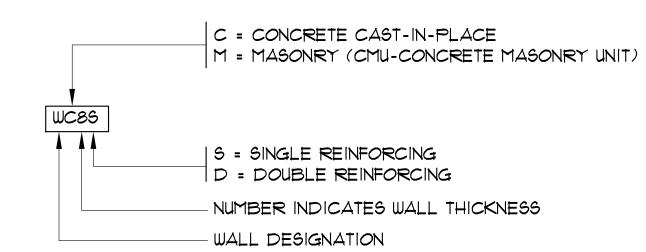

#### FOUNDATION LEGEND:

WF3.0 WALL FOOTING DESIGNATION, SEE SHEET S4.1

WC89 WALL DESIGNATION, SEE SHEET S4.1

(CI) CONCRETE COLUMN DESIGNATION, SEE SHEET 53.1


CF3.0 COLUMN FOOTING DESIGNATION, SEE SHEET S3.1

WALL OPENING

EXISTING MAMPOSTERIA TO REMAIN

#### NOTES

- 1. REFER TO ARCHITECTURAL DRAWING FOR SCOPE OF WORK AND LIMITS OF DEMOLITION WORK.
- 2. SEE SØ2 FOR SLAB DETAILS

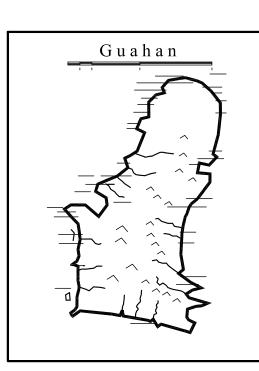

#### GUAM PRESERVATION TRUST

INANGOKKON INADAHI GUAHAN P.O. BOX 3036, HAGATNA, GUAM 96932


#### PROJECT TITLE:

RECONSTRUCTION
OF
ANTONIA C.
CHARAGUALAF
HOUSE, HISTORIC
DISTRICT
OF
INARAJAN

INARAJAN, GUAM

## DESIGN CONSULTANT: Provido Tan-Jones

architects inc.

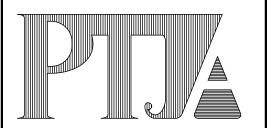

P.O. BOX 6463, TAMUNING, GUAM 96931 TEL: 671 646 1361 FAX: 671 646 2767



DRAWING NAME: FOUNDATION PLAN

BY ME OR UNDER MY DIRECT SUPERVISION

DRAWN: AGC DATE: MARCH 2015


CHECKED: TPC SCALE: AS NOTED

REVISIONS:


DESCRIPTION DATE

DRAWING SHEET NO:


**S1.1** 

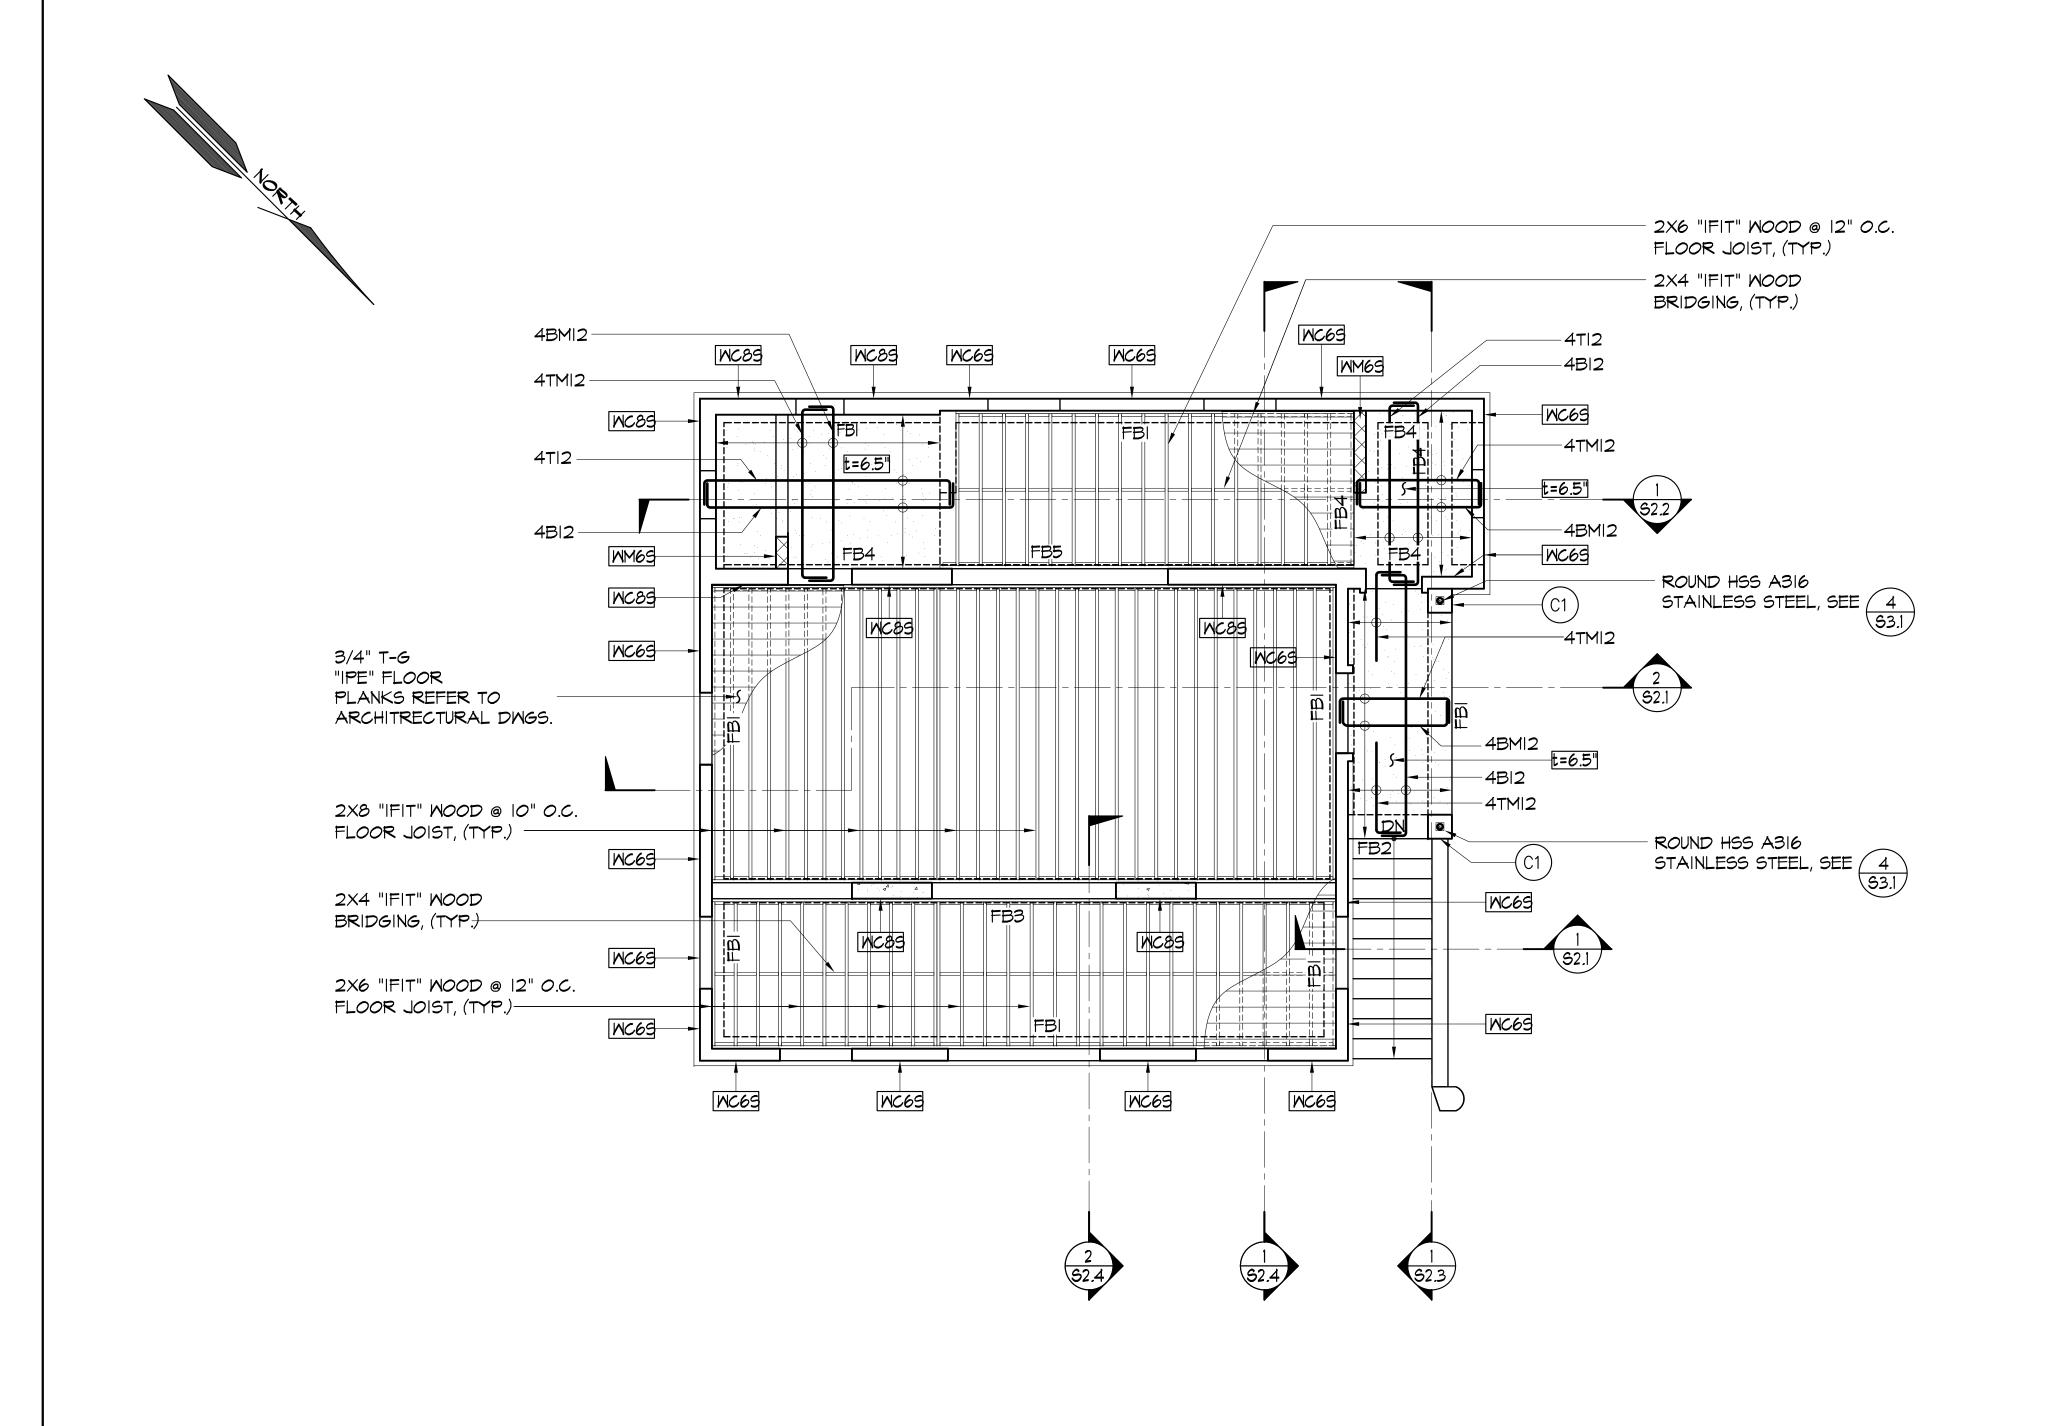

#### SLAB REINFORCING

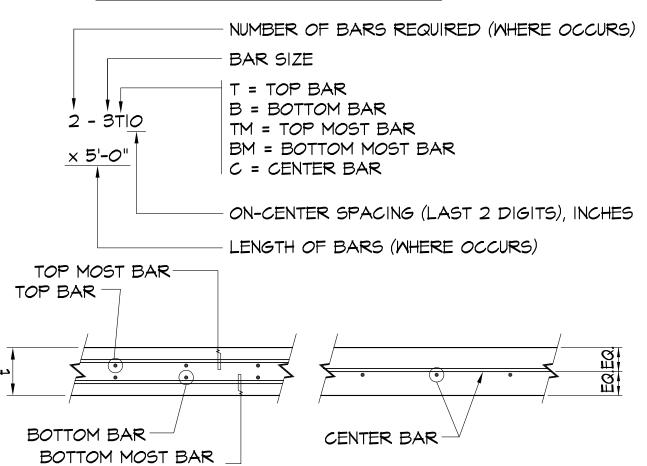

#### WALL DESIGNATION:

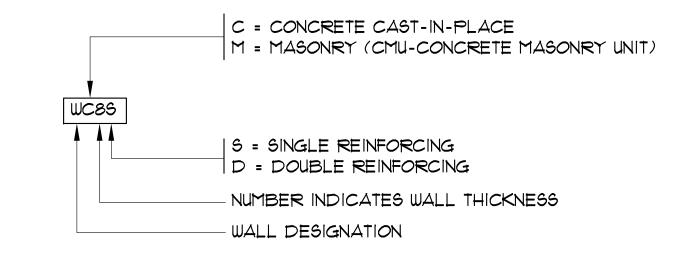


#### LEGEND:



EXISTING MAMPOSTERIA TO REMAIN FLOOR BEAM DESIGNATION, SEE SHEET S5.1

#### <u>NOTES</u>

- 1. REFER TO ARCHITECTURAL DRAWING FOR SCOPE OF WORK AND LIMITS OF DEMOLITION WORK.
- 2. SEE SØ2 FOR SLAB DETAILS

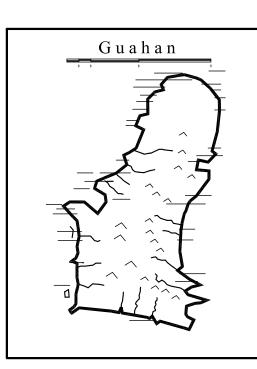


#### **GUAM PRESERVATION TRUST**

INANGOKKON INADAHI GUAHAN P.O. BOX 3036, HAGATNA, GUAM 96932

#### PROJECT TITLE:

RECONSTRUCTION ANTONIA C. CHARAGUALAF HOUSE, HISTORIC DISTRICT INARAJAN INARAJAN, GUAM

#### DESIGN CONSULTANT: | Provido · Tan · Jones architects inc.

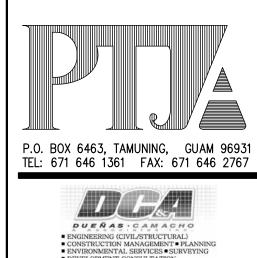



BY ME OR UNDER MY DIRECT SUPERVISION

DRAWING NAME:

UPPER LEVEL FRAMING PLAN

DRAWN: AGC DATE: MARCH 2015 SCALE: AS NOTED


**REVISIONS:** DESCRIPTION DATE


DRAWING SHEET NO:

**S1.2** 

SHEET \_\_\_ OF \_\_\_

UPPER LEVEL FRAMING PLAN SI.2 SCALE:

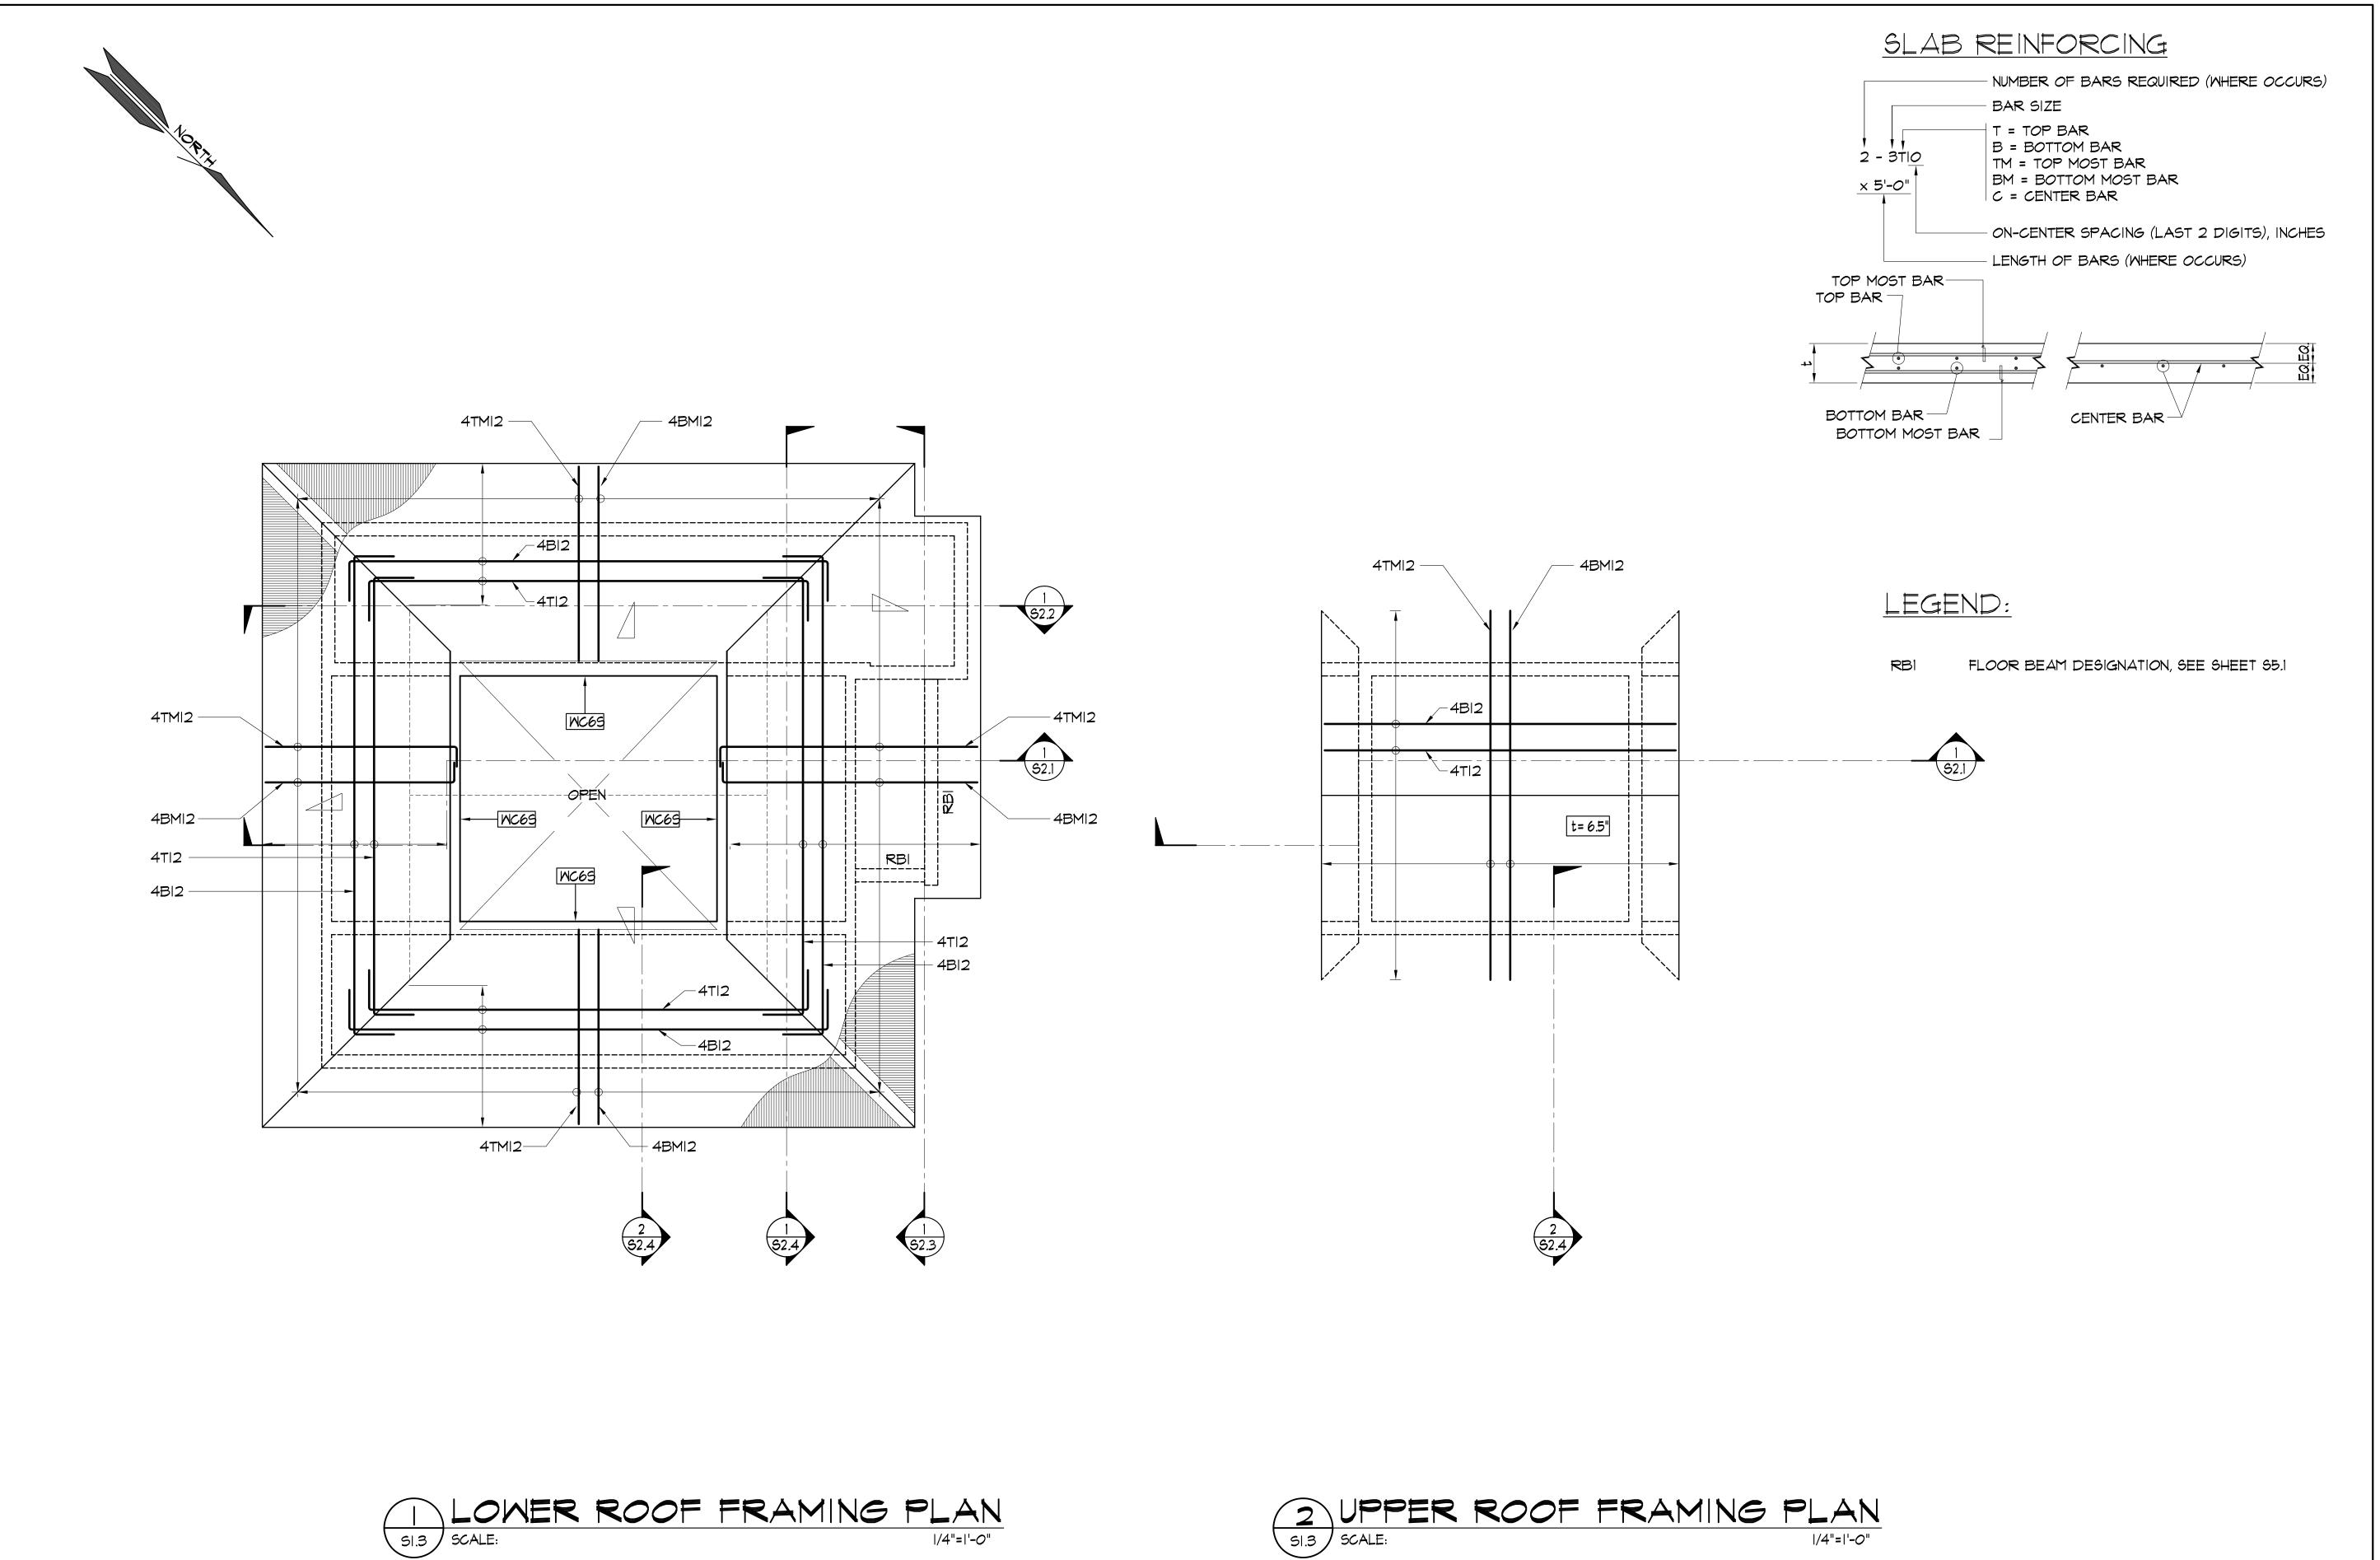

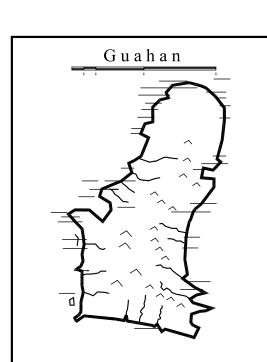


INANGOKKON INADAHI GUAHAN P.O. BOX 3036, HAGATNA, GUAM 96932

#### PROJECT TITLE:


RECONSTRUCTION
OF
ANTONIA C.
CHARAGUALAF
HOUSE, HISTORIC
DISTRICT
OF
INARAJAN

INARAJAN, GUAM

## DESIGN CONSULTANT: Provido • Tan • Jones architects inc.

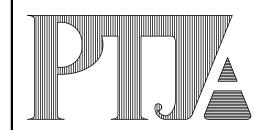

P.O. BOX 6463, TAMUNING, GUAM 96931 TEL: 671 646 1361 FAX: 671 646 2767

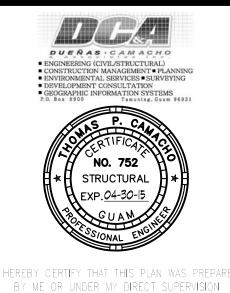

DRAWING NAME:

LOWER ROOF FRAMING PLAN
UPPER ROOF FRAMING PLAN

DRAWN: AGC DATE: MARCH 2015


CHECKED: TPC SCALE: AS NOTED


REVISIONS:

DESCRIPTION DATE

DRAWING SHEET NO:

**S1.3** 

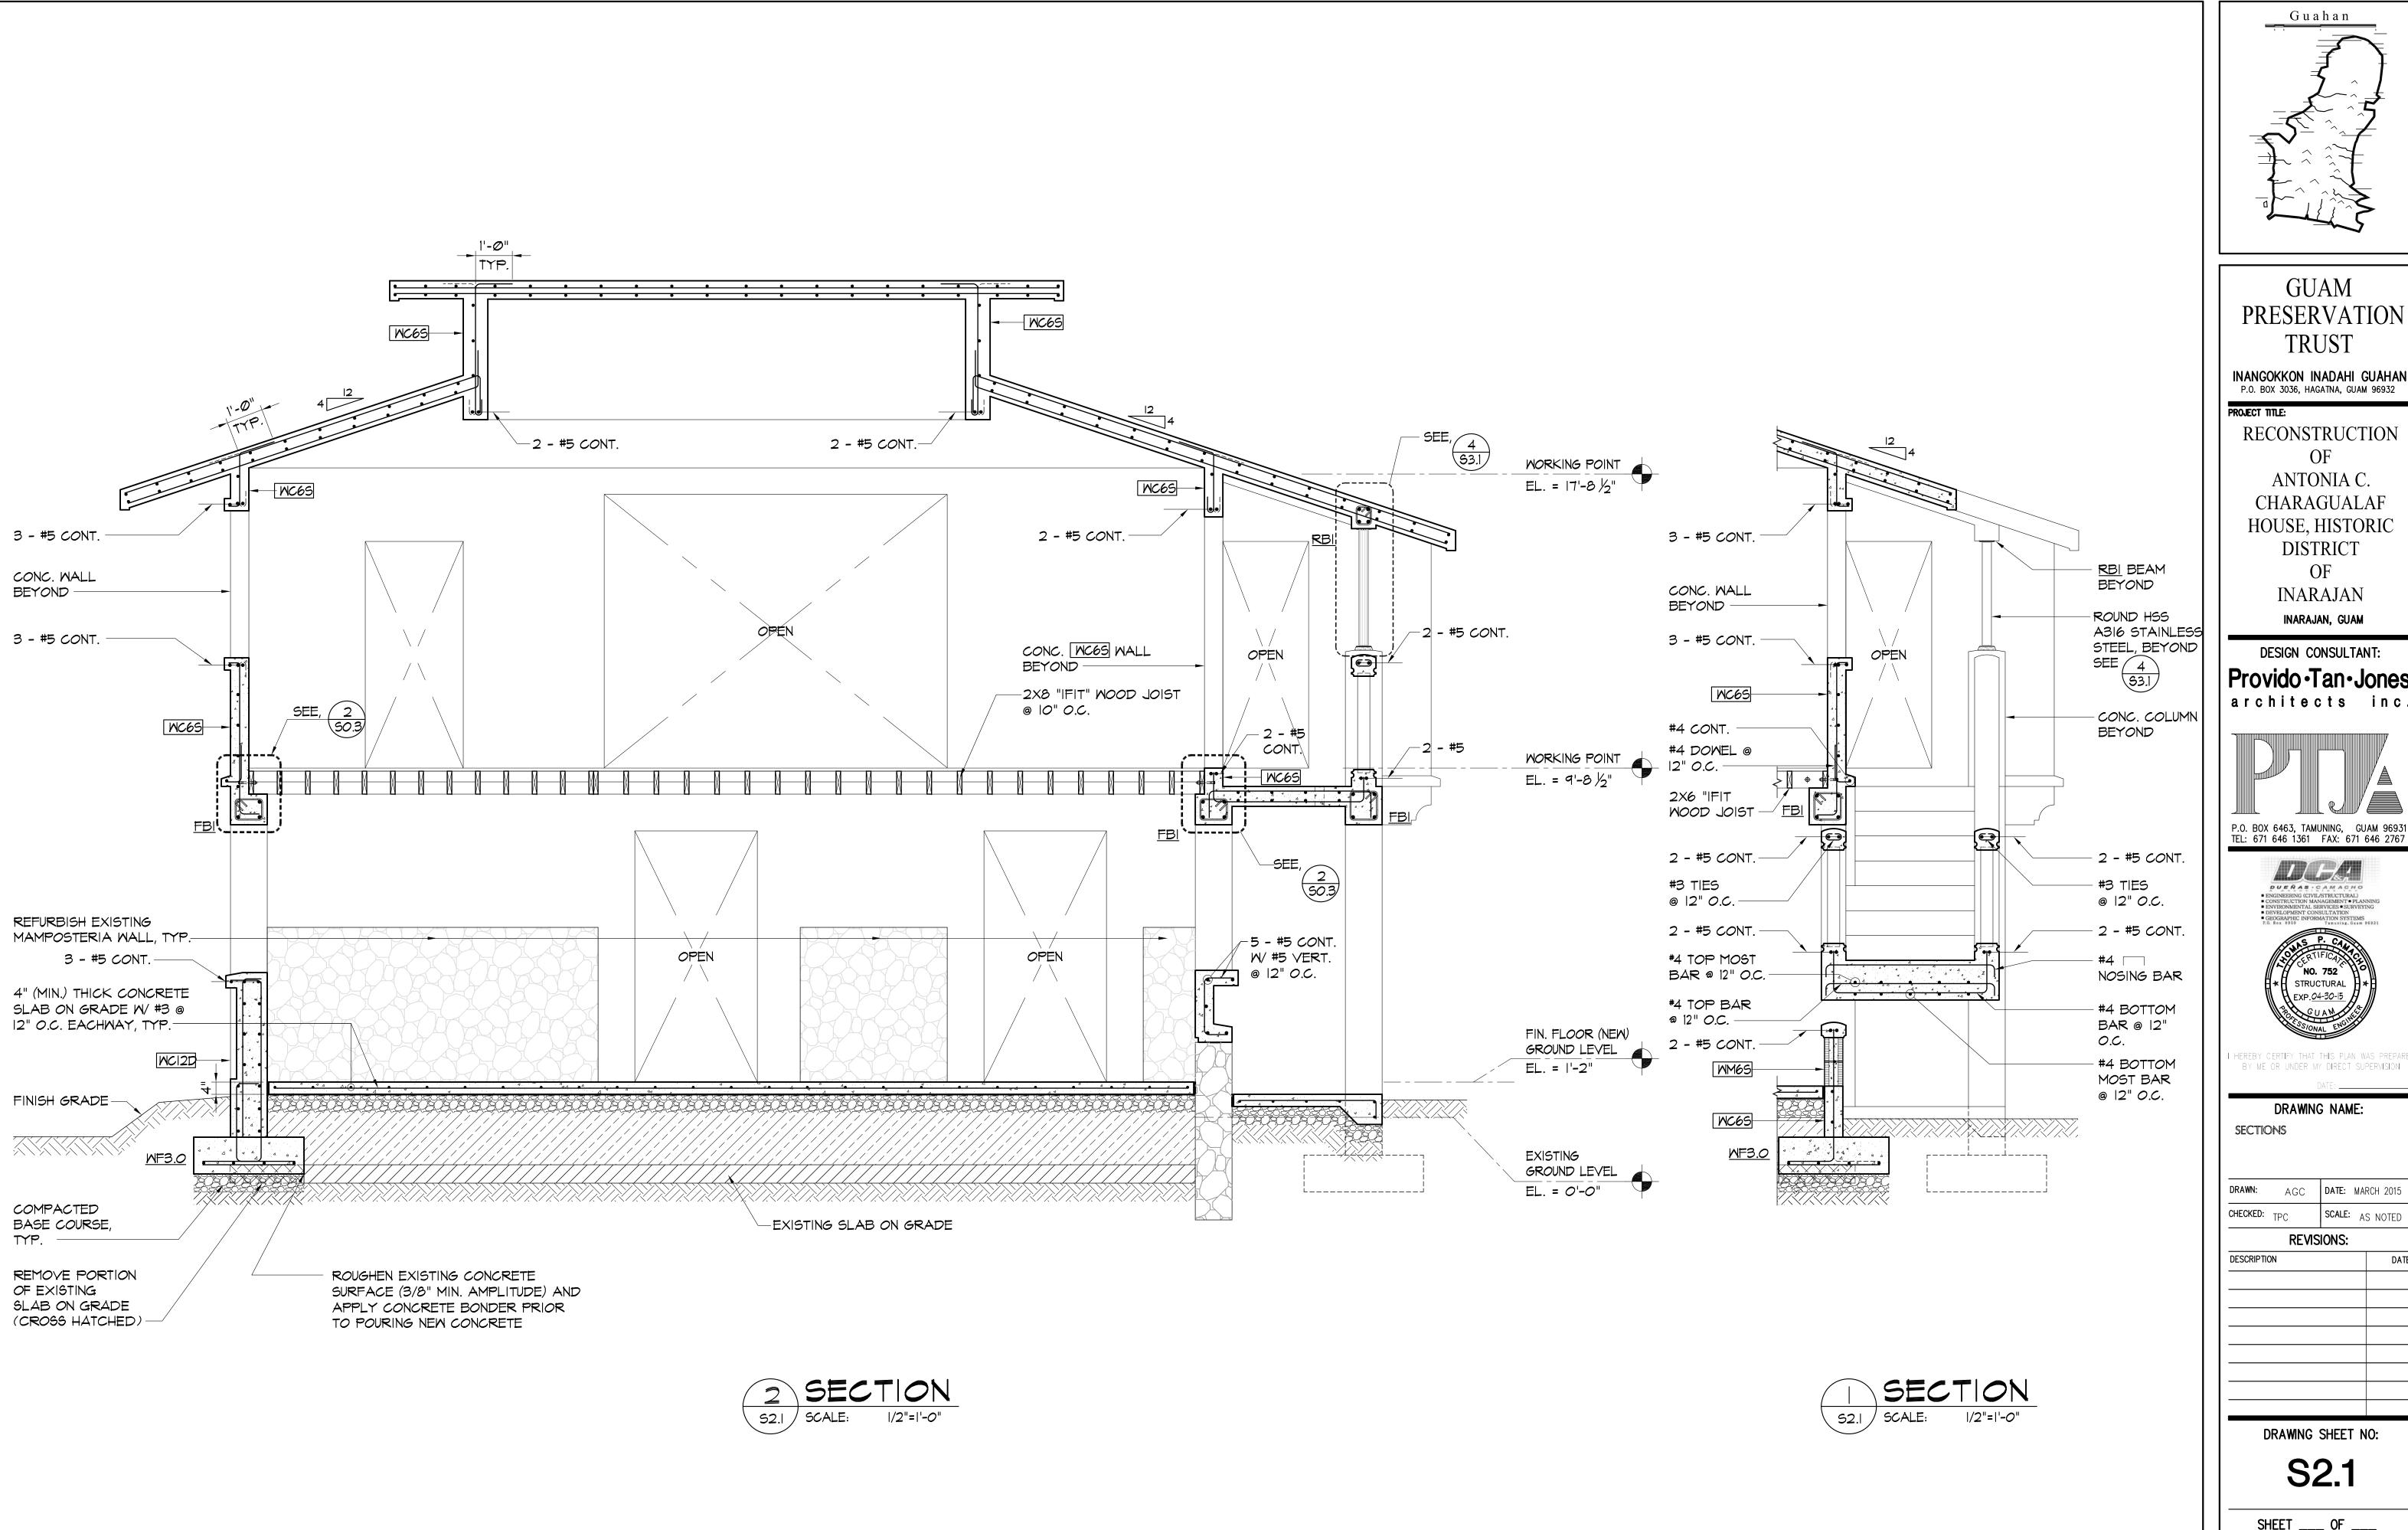

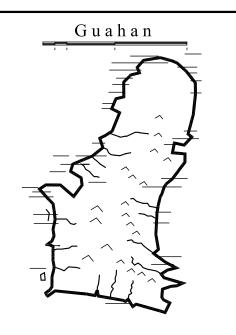


INANGOKKON INADAHI GUAHAN P.O. BOX 3036, HAGATNA, GUAM 96932

## PROJECT TITLE:

RECONSTRUCTION ANTONIA C. CHARAGUALAF HOUSE, HISTORIC DISTRICT INARAJAN

INARAJAN, GUAM

#### DESIGN CONSULTANT: Provido · Tan · Jones architects inc.

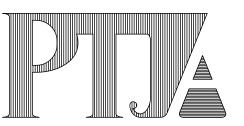

P.O. BOX 6463, TAMUNING, GUAM 96931 TEL: 671 646 1361 FAX: 671 646 2767




DRAWING NAME: SECTIONS


AGC DATE: MARCH 2015 SCALE: AS NOTED

DATE

**REVISIONS:** DESCRIPTION

DRAWING SHEET NO: **S2.1** 

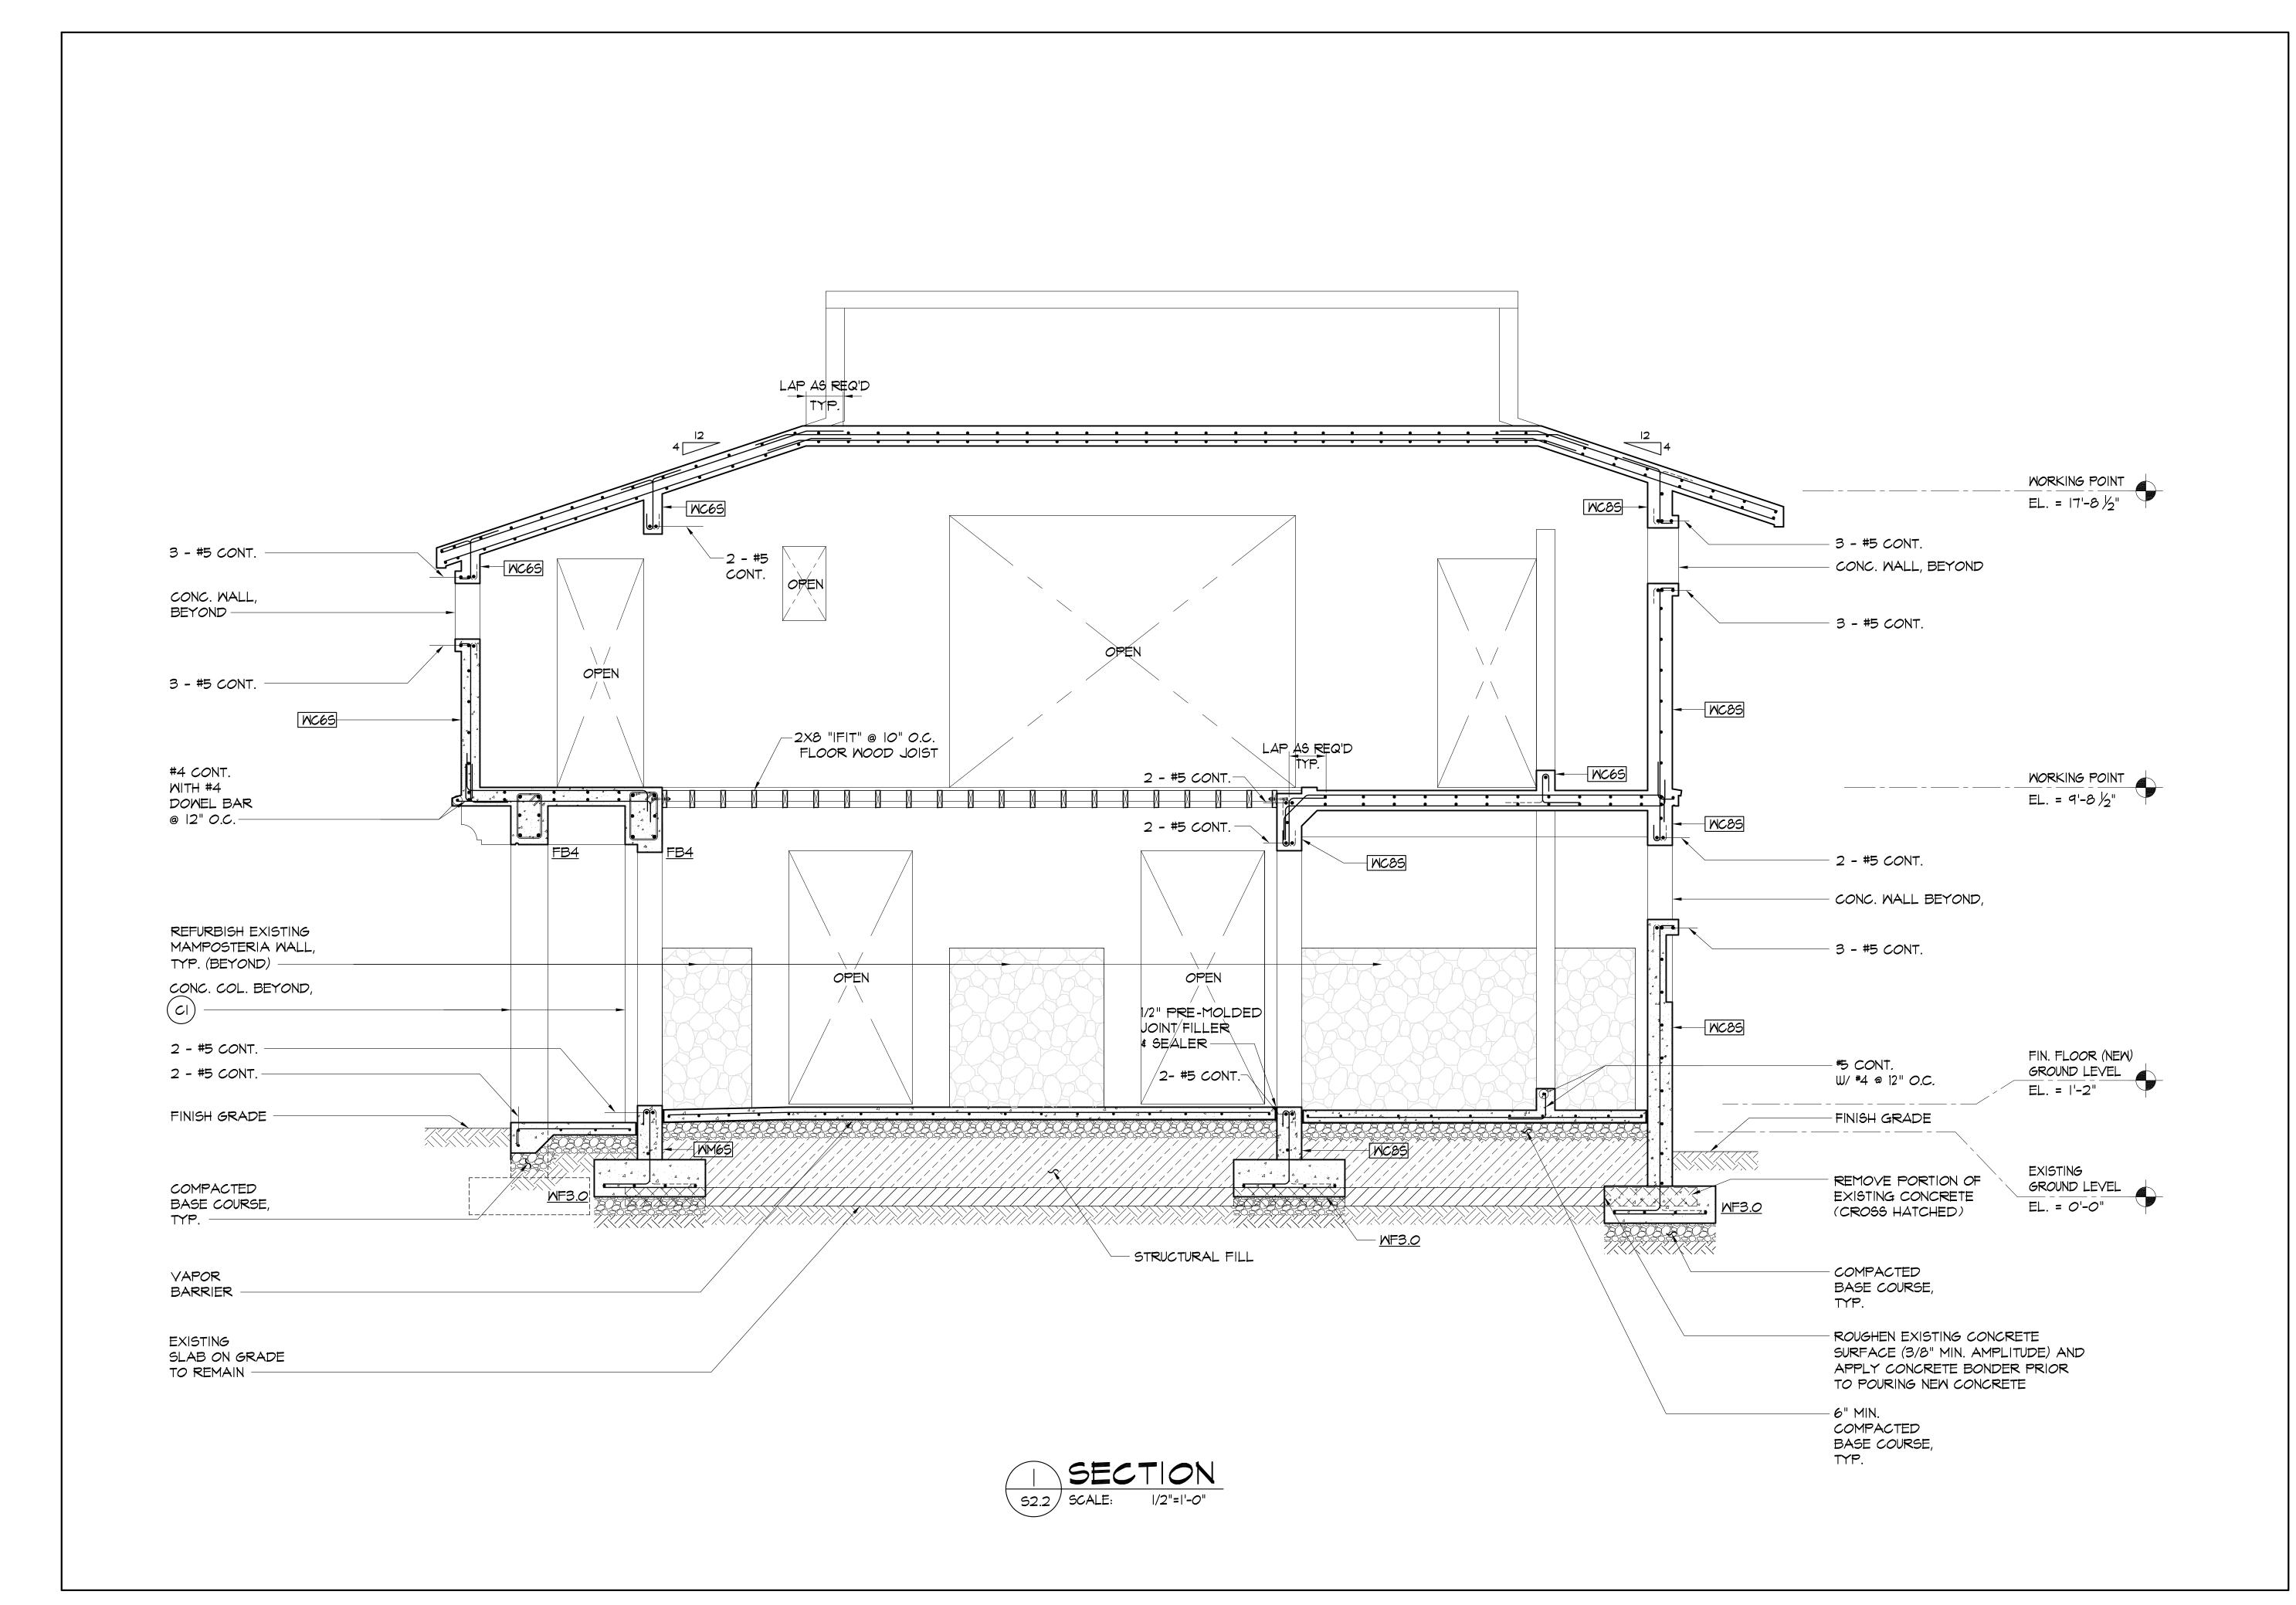

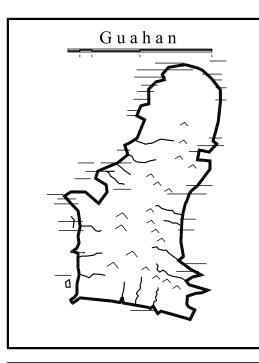

INANGOKKON INADAHI GUAHAN P.O. BOX 3036, HAGATNA, GUAM 96932


#### PROJECT TITLE:

RECONSTRUCTION ANTONIA C. CHARAGUALAF HOUSE, HISTORIC DISTRICT INARAJAN INARAJAN, GUAM

#### DESIGN CONSULTANT: Provido · Tan · Jones architects inc.



P.O. BOX 6463, TAMUNING, GUAM 96931 TEL: 671 646 1361 FAX: 671 646 2767

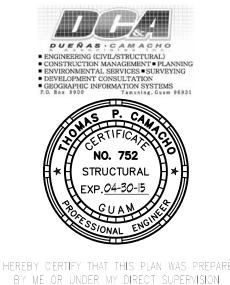

#### DRAWING NAME:

SECTION


DRAWN: AGC DATE: MARCH 2015 SCALE: AS NOTED CHECKED: TPC


#### **REVISIONS:**

DESCRIPTION DATE

DRAWING SHEET NO:

**S2.2** 

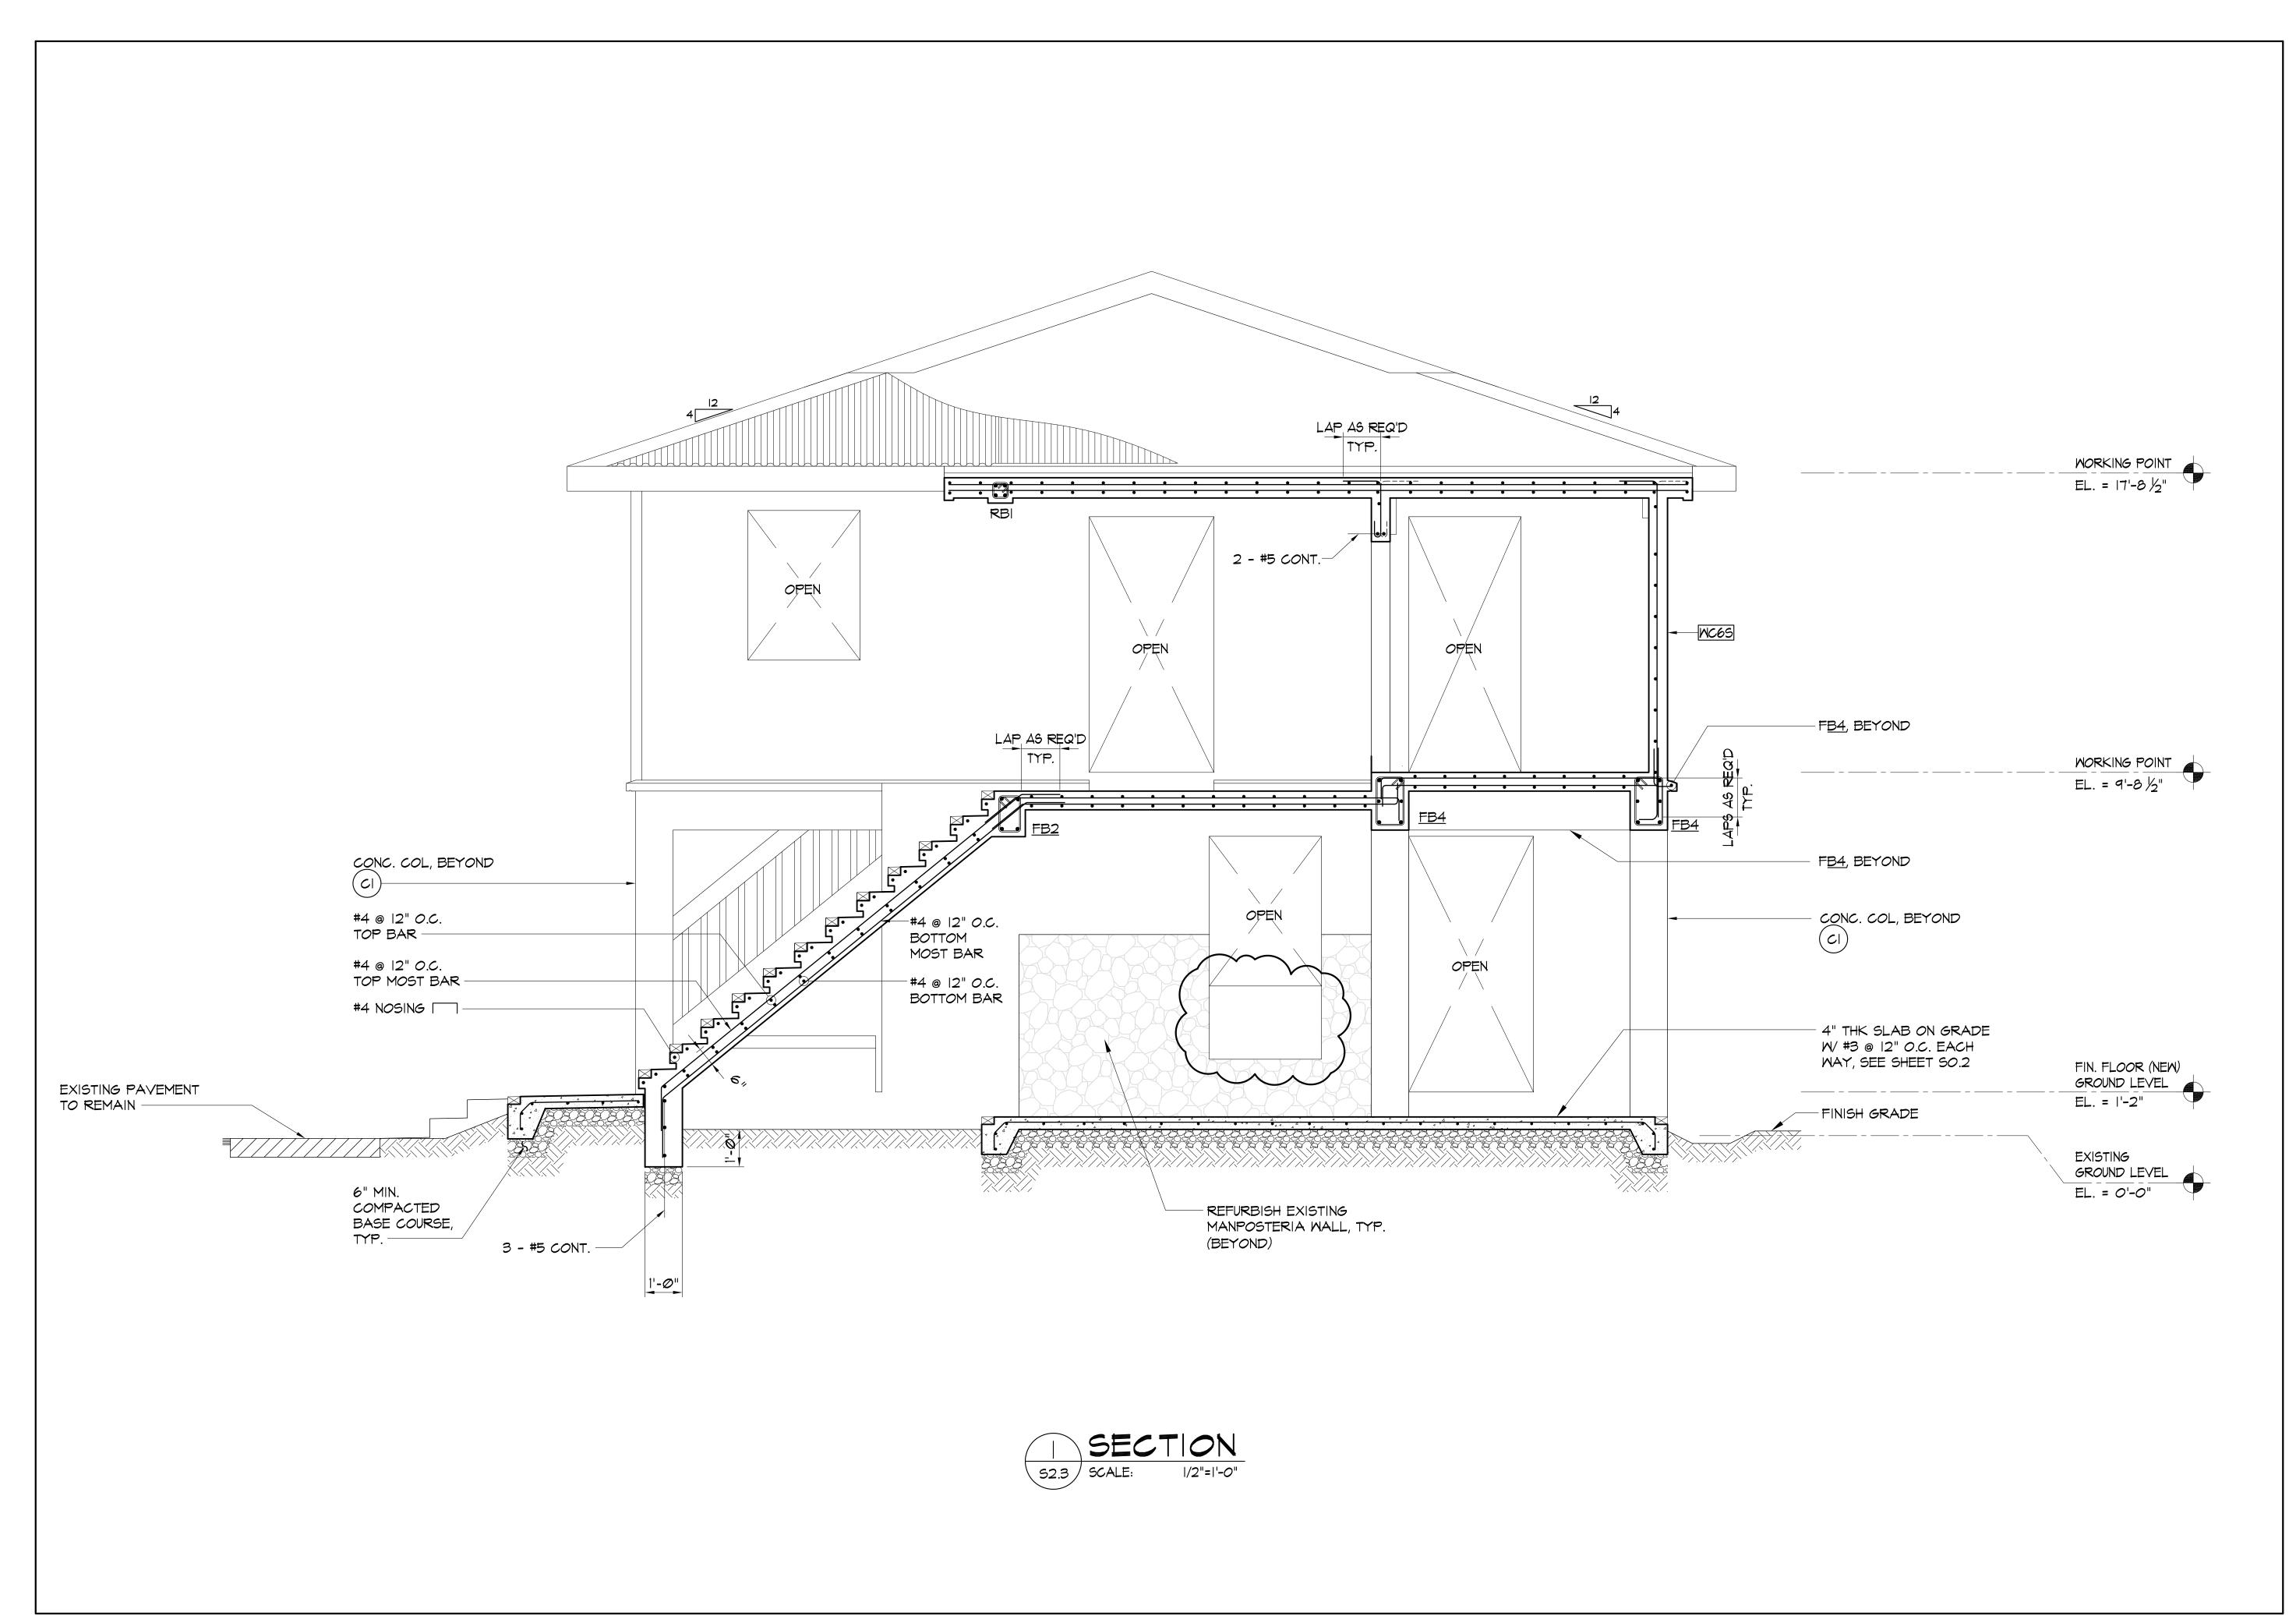

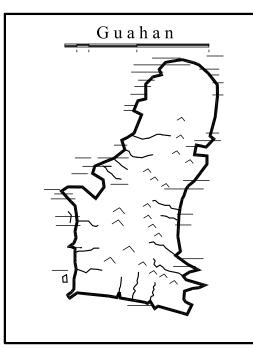

INANGOKKON INADAHI GUAHAN P.O. BOX 3036, HAGATNA, GUAM 96932


#### PROJECT TITLE:

RECONSTRUCTION
OF
ANTONIA C.
CHARAGUALAF
HOUSE, HISTORIC
DISTRICT
OF
INARAJAN
INARAJAN, GUAM

# Provido Tan Jones architects inc.



P.O. BOX 6463, TAMUNING, GUAM 96931 TEL: 671 646 1361 FAX: 671 646 2767

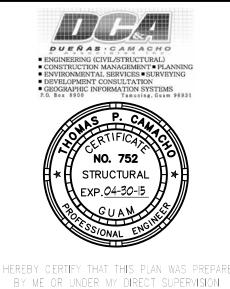

DRAWING NAME:

SECTION

DRAWN: AGC DATE: MARCH 2015


CHECKED: TPC SCALE: AS NOTED


REVISIONS:


SCRIPTION	DAT


DRAWING SHEET NO:


**S2.3** 

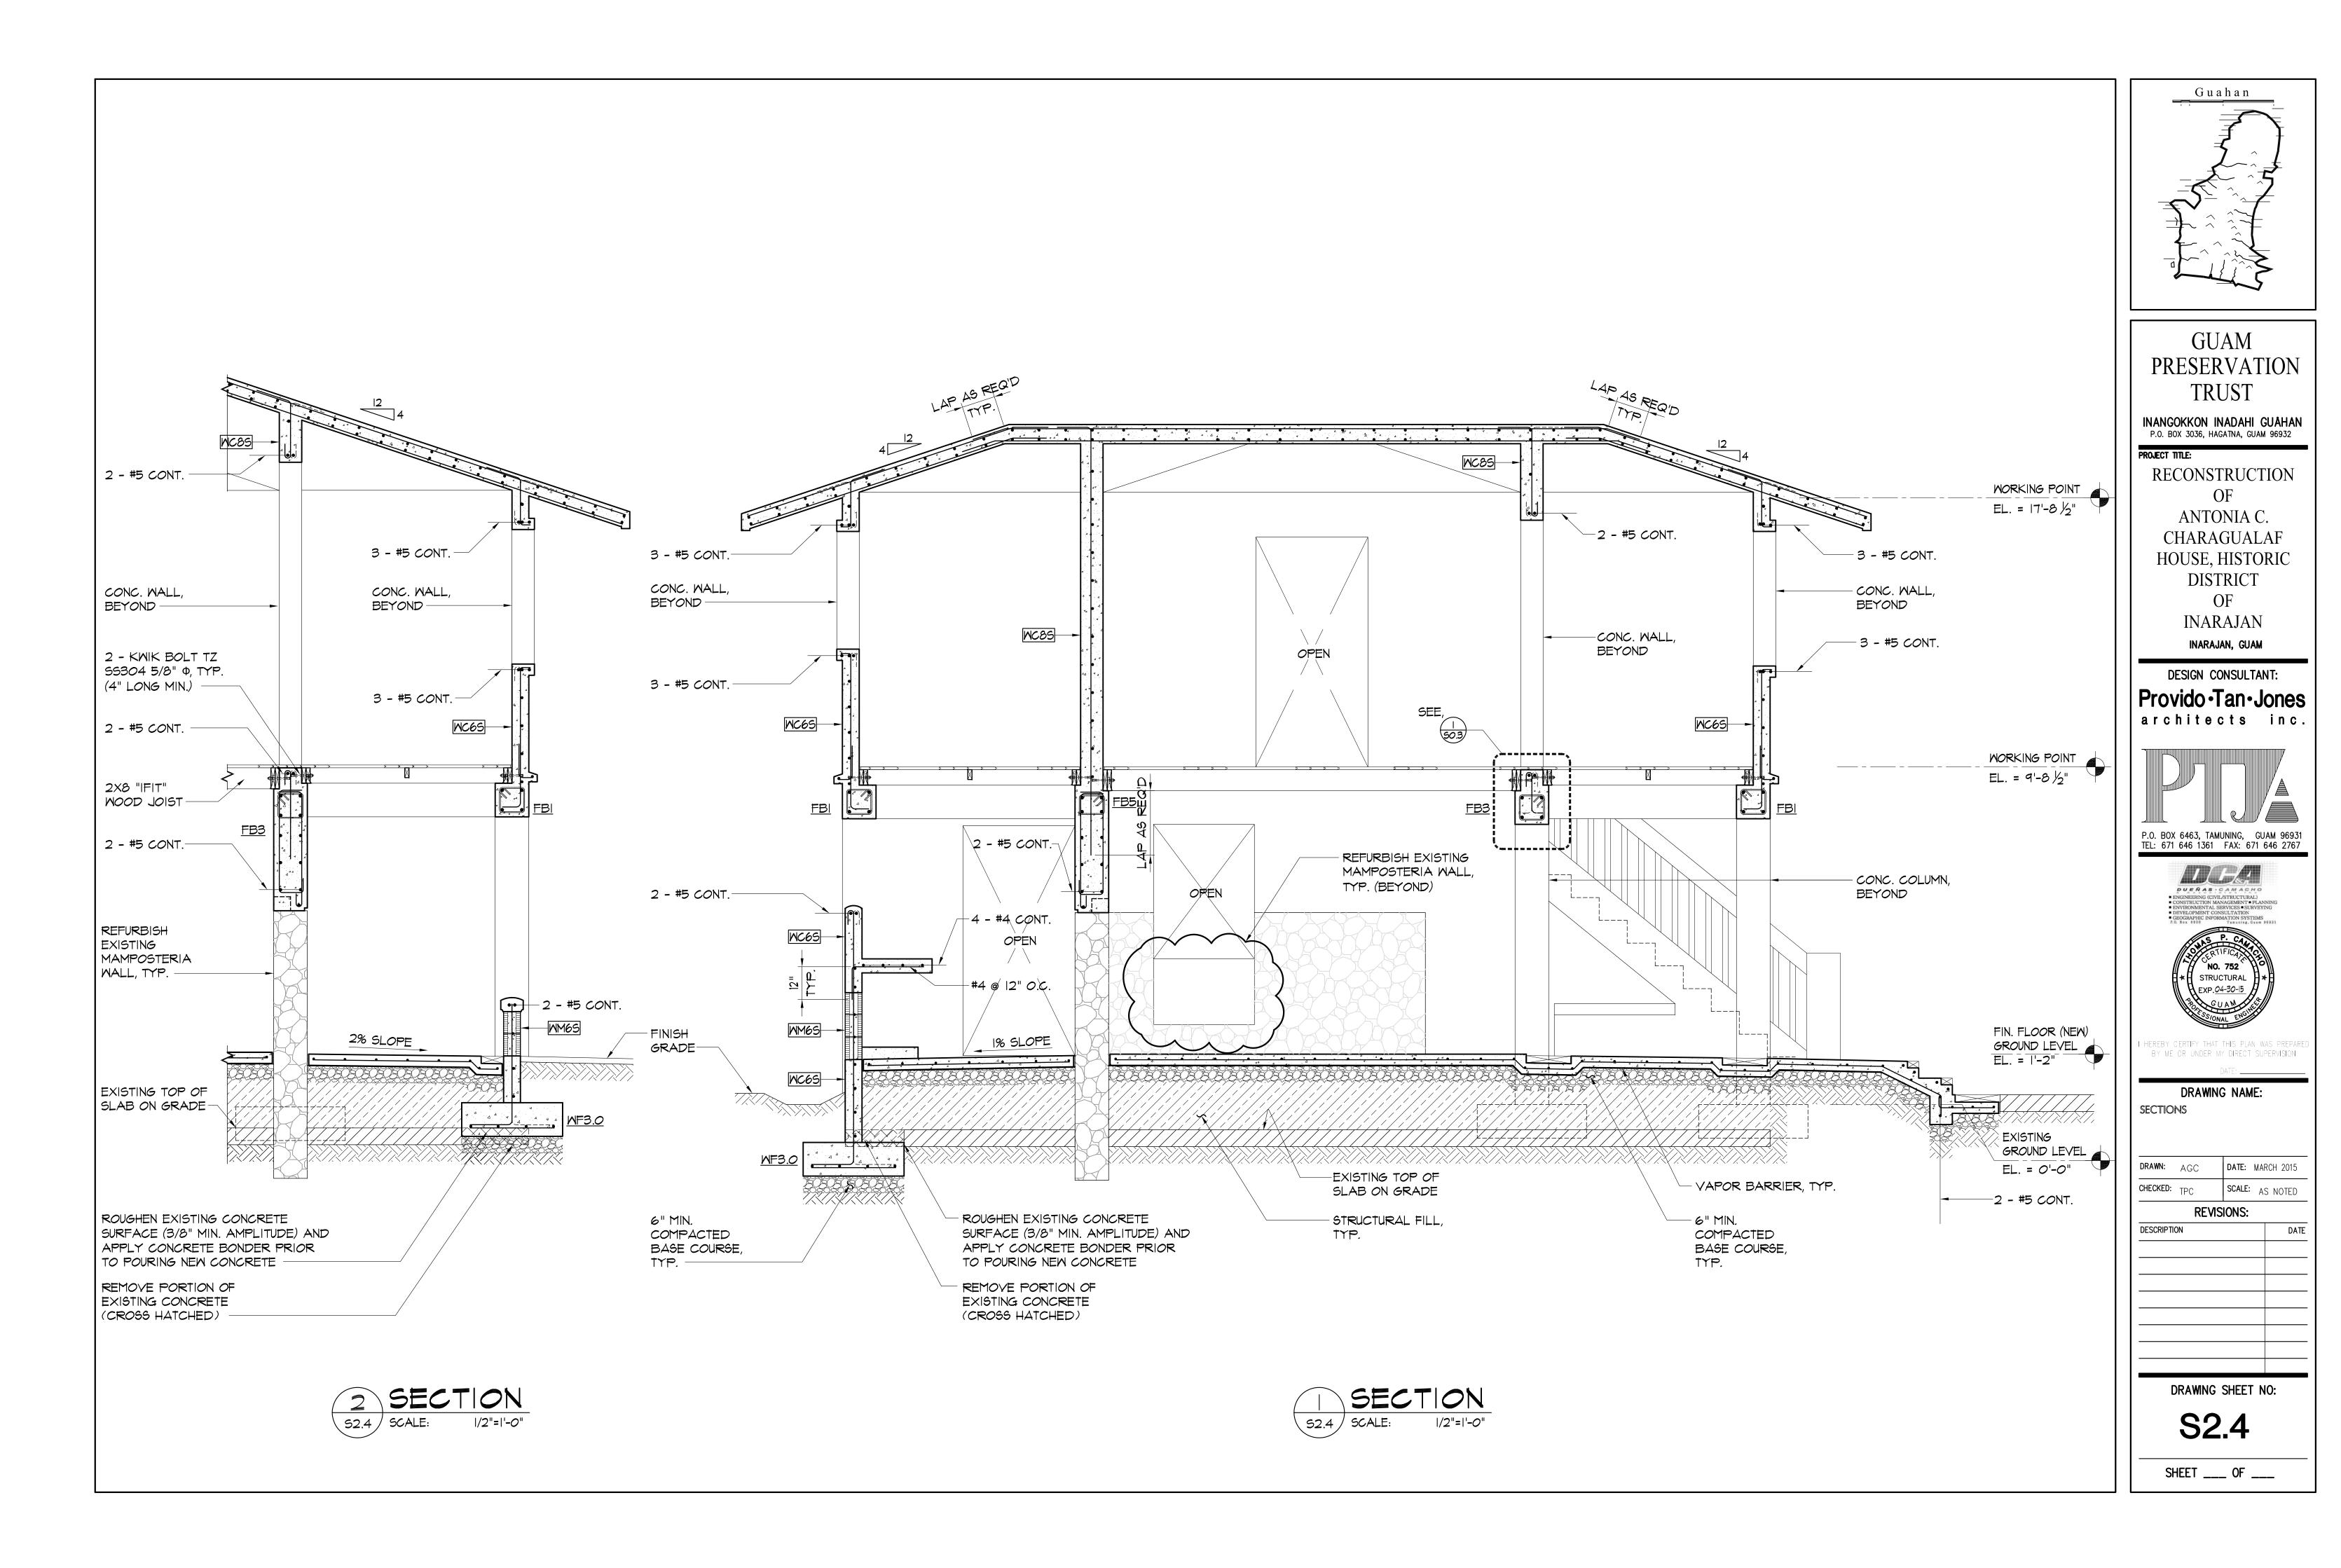


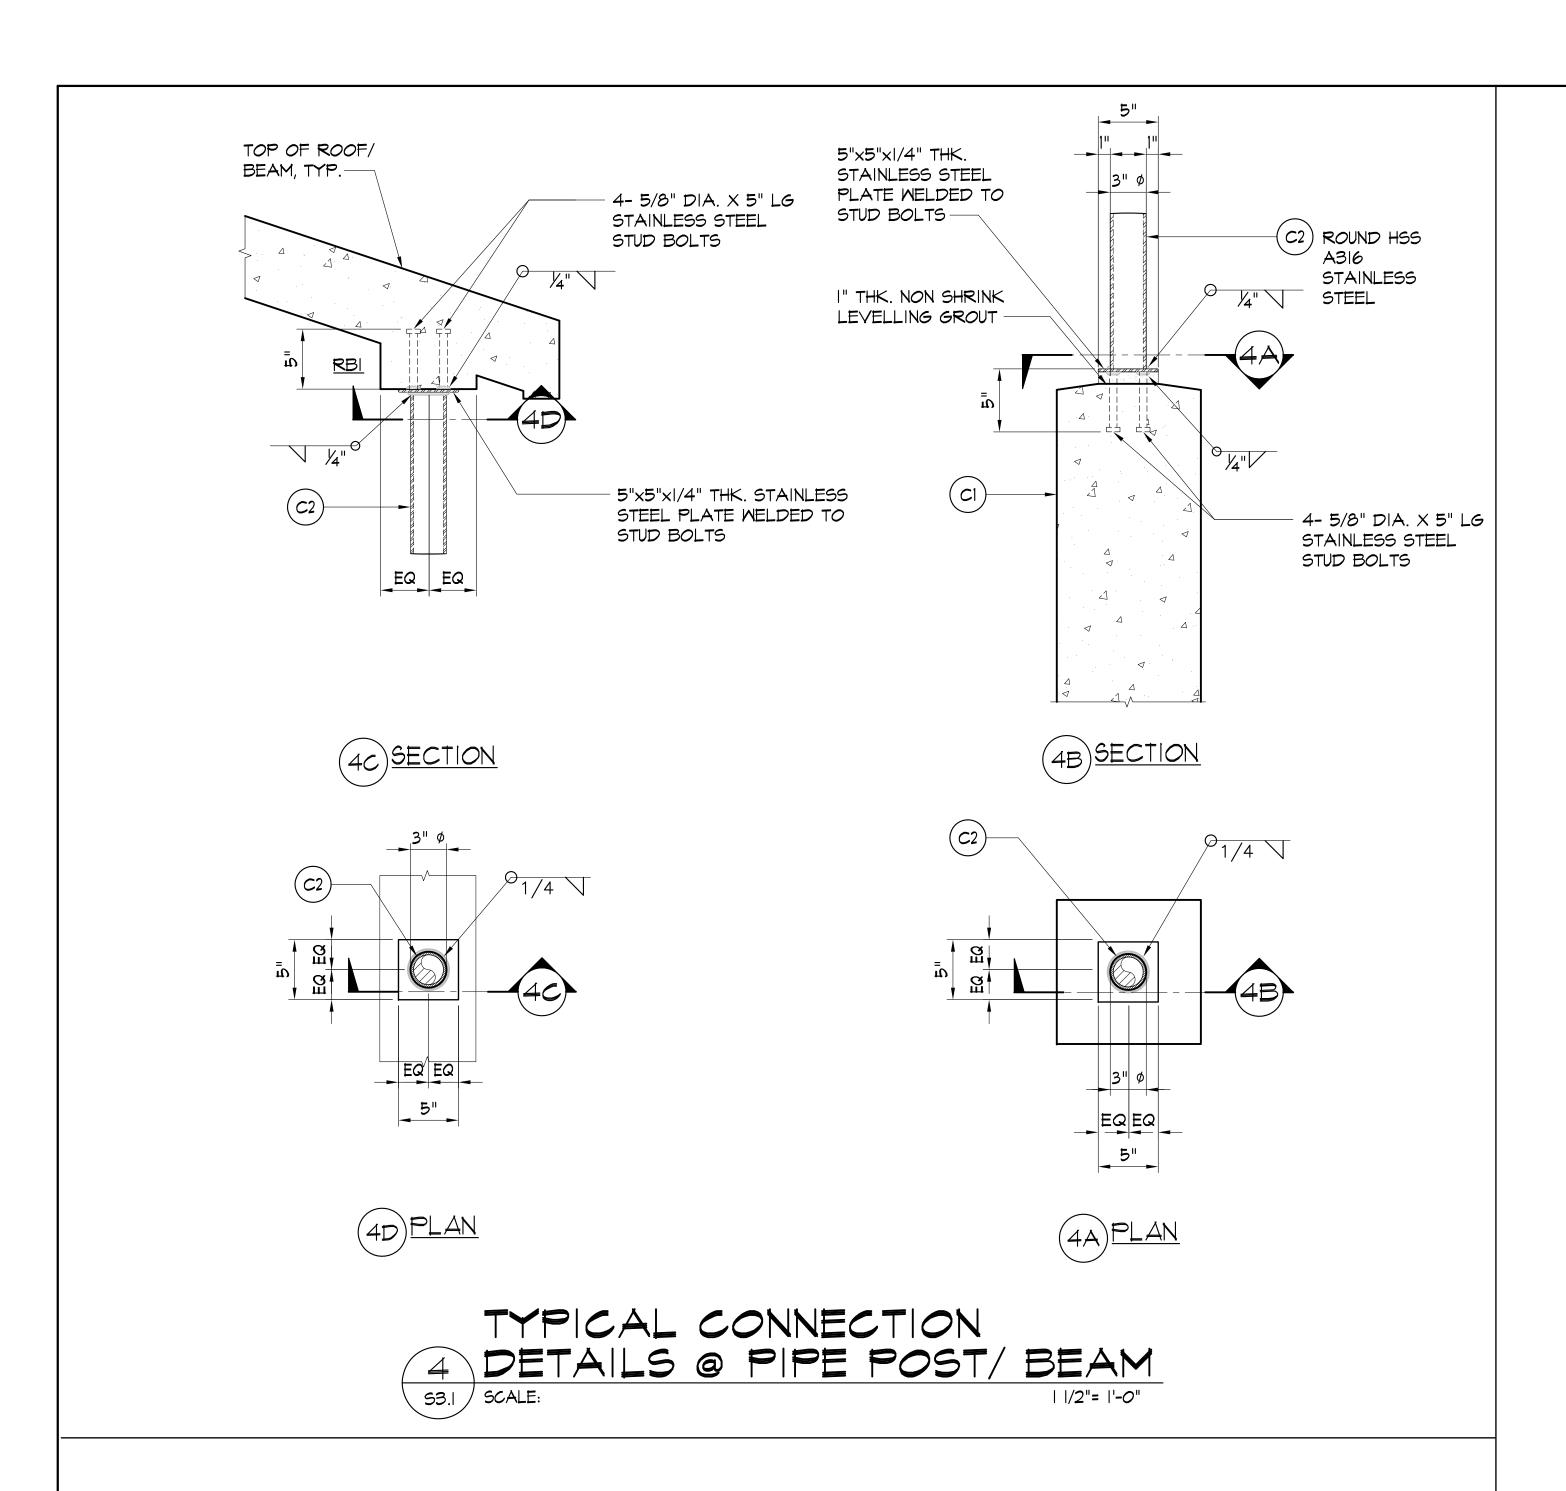

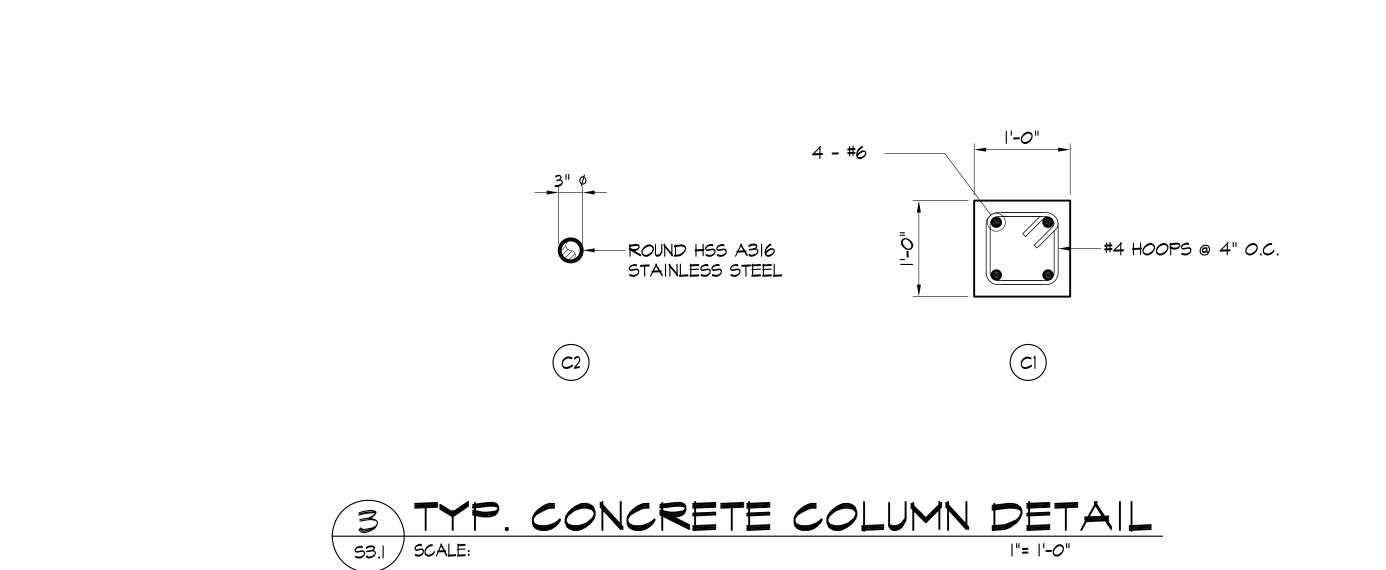


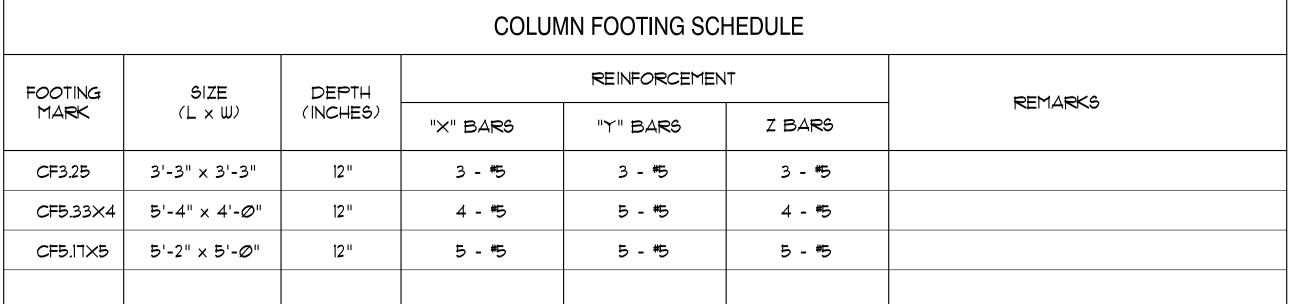

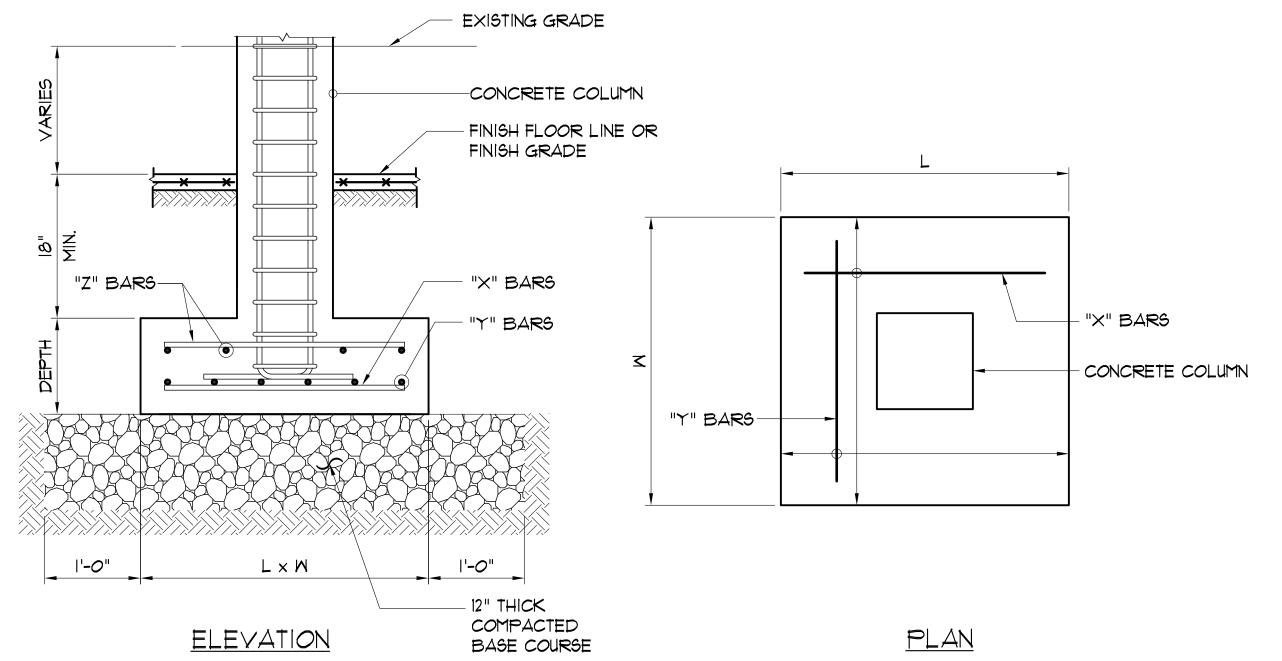

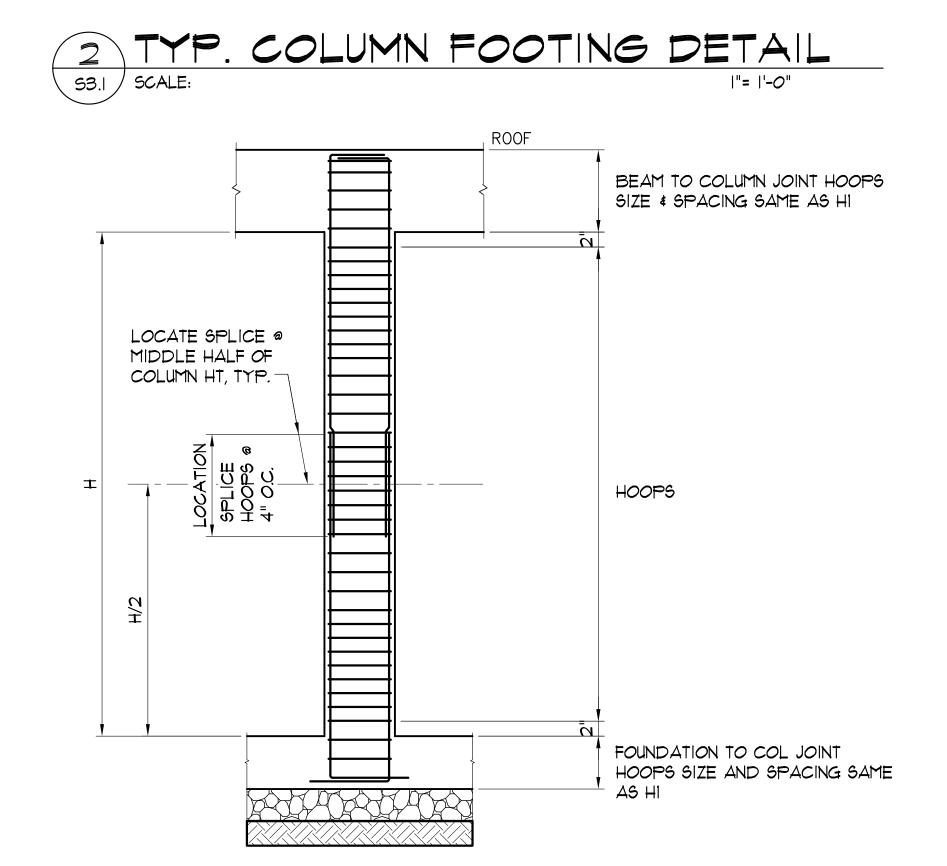



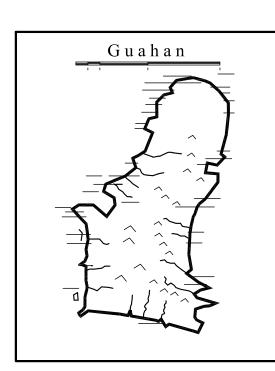


INANGOKKON INADAHI GUAHAN P.O. BOX 3036, HAGATNA, GUAM 96932

#### PROJECT TITLE:

RECONSTRUCTION ANTONIA C. CHARAGUALAF HOUSE, HISTORIC DISTRICT INARAJAN INARAJAN, GUAM

#### DESIGN CONSULTANT: Provido · Tan · Jones architects inc.

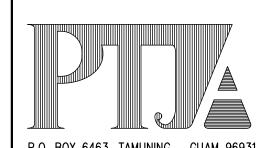

## P.O. BOX 6463, TAMUNING, GUAM 96931 TEL: 671 646 1361 FAX: 671 646 2767



#### DRAWING NAME:


TYPICAL COLUMN & COLUMN FOOTING DETAILS

DATE: MARCH 2015 SCALE: AS NOTED

## **REVISIONS:**

DRAWING SHEET NO:

**S3.1** 

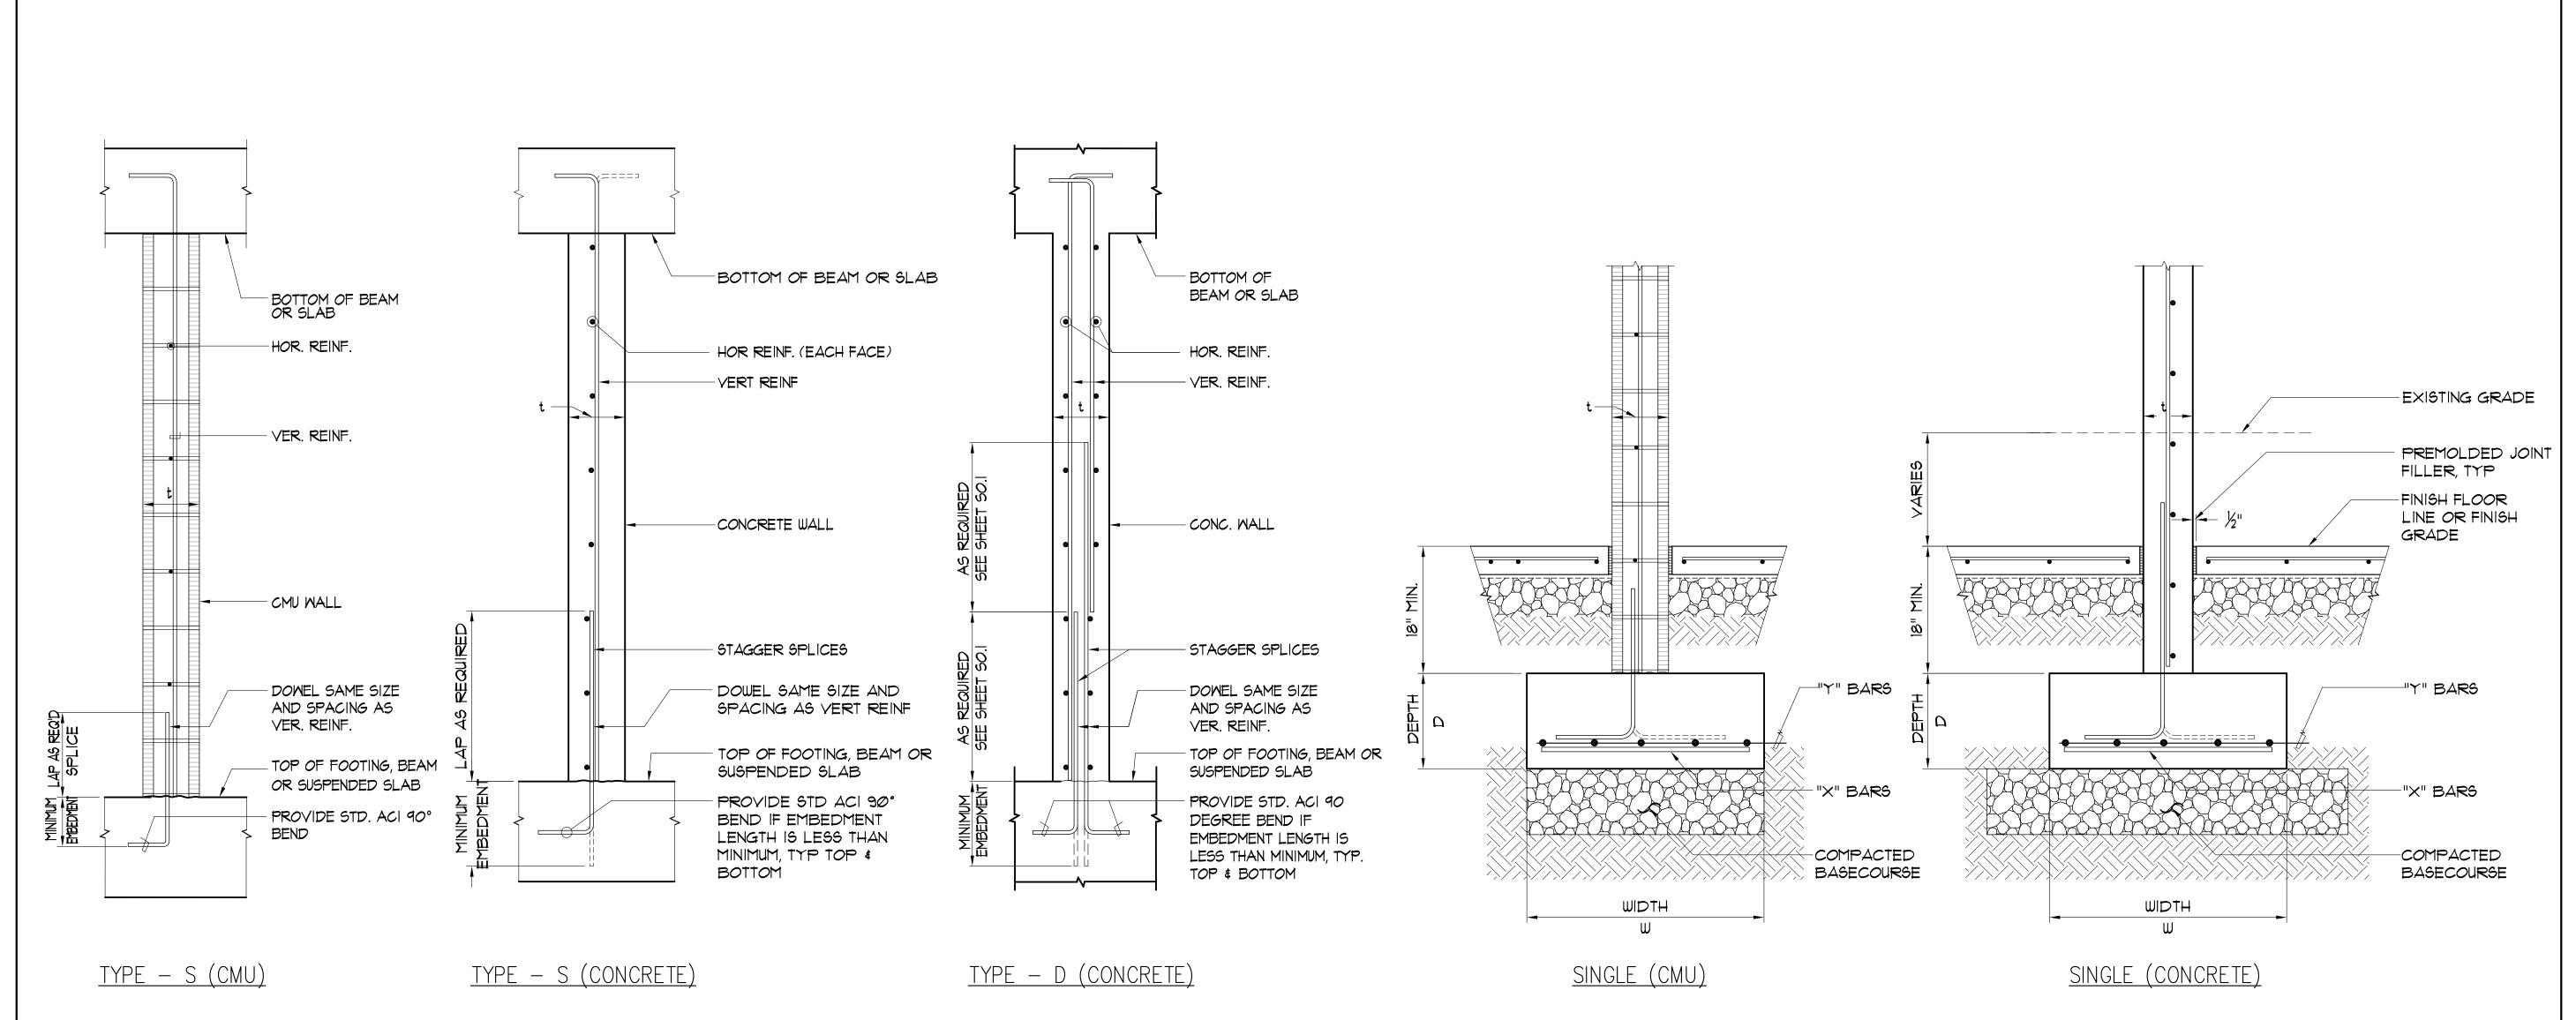


WALL SCHEDULE								
1	THICKNESS	TYPE	REIN	FORCEMENT	REMARKS			
	" t "		VERT. BARS	HOR. BARS	REMARKS			
WM65	6"	5	#5 @ 16" O.C.	#4 @  6" O.C.				
MM85	6"	5	#5 @ 16" O.C.	#4 @  6" O.C.				
MC6S	6"	5	#4 @ IO" O.C.	#4 @ IO" O.C.				
MC8S	8"	5	#4 @ IO" O.C.	#4 @ IO" O.C.				
MC12D	12"	D	#4 @ IO" O.C.	#4 @ IO" O.C.				

WALL FOOTING SCHEDULE							
FOOTING	WIDTH W	DEPTH D	REINF	PEMARKO			
MARK			"X" BARS	"Y" BARS	REMARKS		
WF3.0	3'-0"	12"	#5 @  2" <i>O.C</i> .				



TYPICAL WALL FOOTING DETAIL

S4.1 NOT TO SCALE:

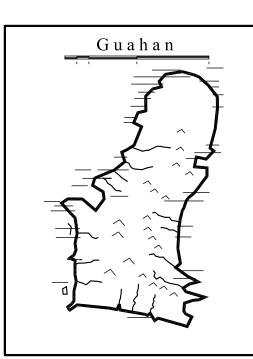

#### GUAM **PRESERVATION TRUST**

INANGOKKON INADAHI GUAHAN P.O. BOX 3036, HAGATNA, GUAM 96932


#### PROJECT TITLE: RECONSTRUCTION

ANTONIA C. CHARAGUALAF HOUSE, HISTORIC DISTRICT

> INARAJAN INARAJAN, GUAM

#### DESIGN CONSULTANT: | Provido Tan Jones

architects inc.

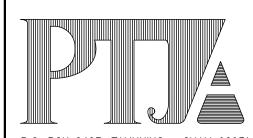

P.O. BOX 6463, TAMUNING, GUAM 96931 TEL: 671 646 1361 FAX: 671 646 2767



BY ME OR UNDER MY DIRECT SUPERVISION

### DRAWING NAME:

TYPICAL WALL & WALL FOOTING DETAILS


DRAWN: CAD DATE: MARCH 2015 SCALE: AS NOTED


**REVISIONS:** 


ME VISIONS.	
DESCRIPTION	D
	·


DRAWING SHEET NO:


**S4.1** 

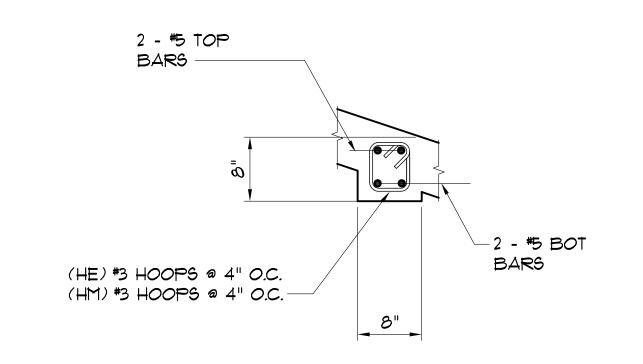


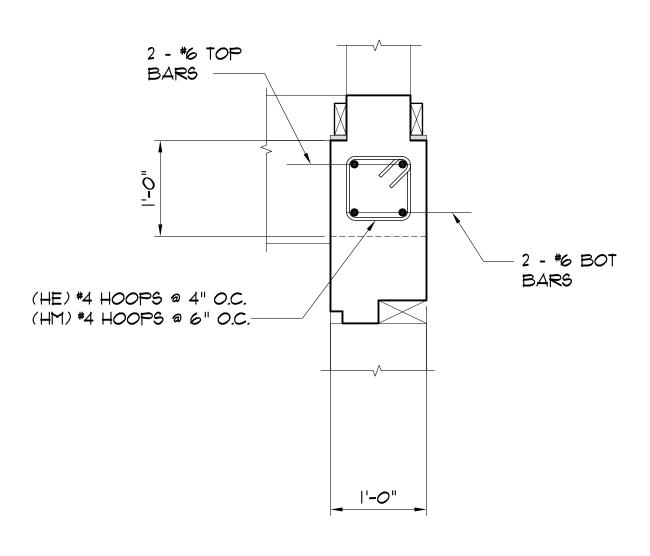


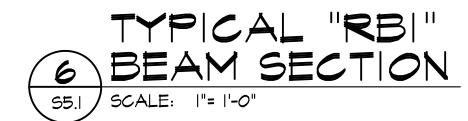

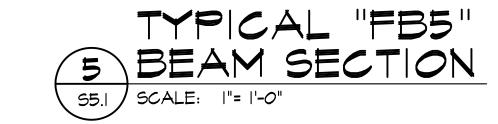

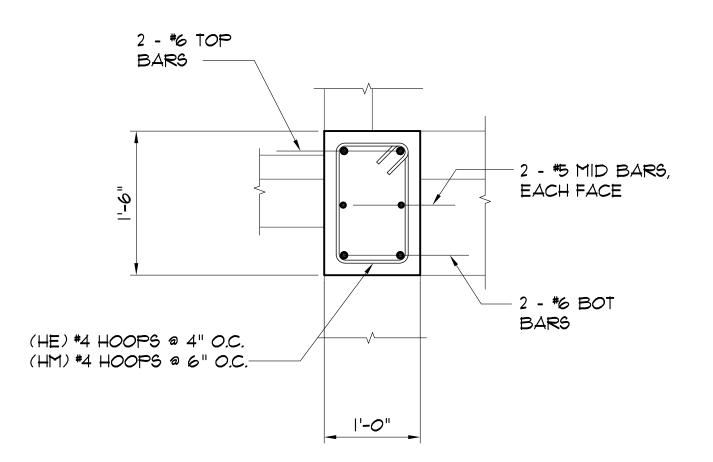

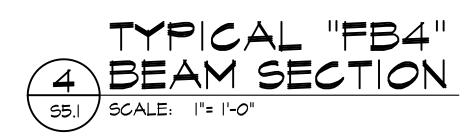


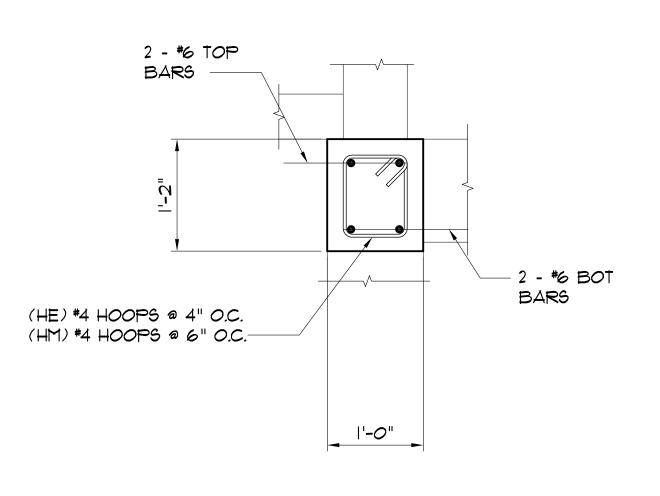

TYPICAL "FB3"


3 BEAM SECTION

55.1 SCALE: 1"= 1'-0"

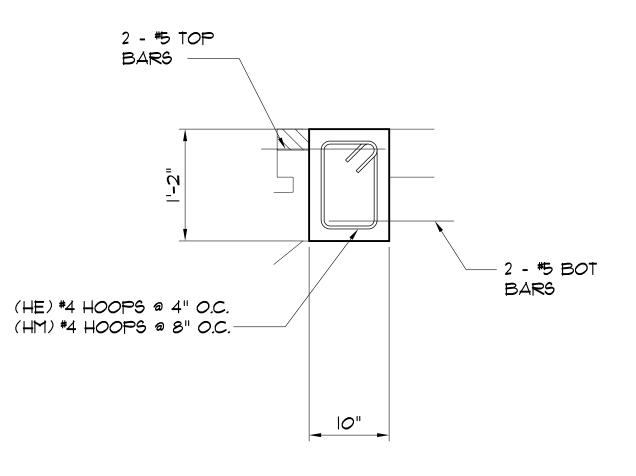


TYPICAL "FB2" 2 BEAM SECTION

S5.1 SCALE: 1"= 1'-0"

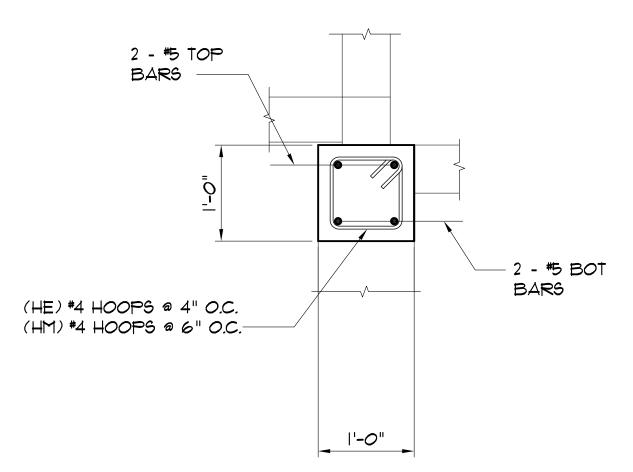

TYPICAL "FBI" BEAM SECTION SCALE: |"= |'-0"

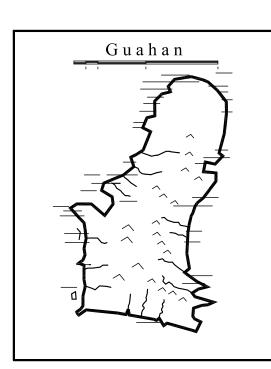


#### GUAM PRESERVATION **TRUST**

INANGOKKON INADAHI GUAHAN P.O. BOX 3036, HAGATNA, GUAM 96932

PROJECT TITLE: RECONSTRUCTION OF ANTONIA C. CHARAGUALAF HOUSE, HISTORIC DISTRICT INARAJAN INARAJAN, GUAM

## DESIGN CONSULTANT:

Provido · Tan · Jones architects inc.

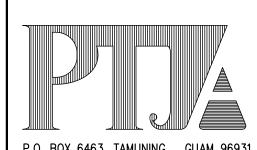

P.O. BOX 6463, TAMUNING, GUAM 96931 TEL: 671 646 1361 FAX: 671 646 2767




DRAWING NAME: TYPICAL BEAM SECTIONS


DATE: MARCH 2015 SCALE: AS NOTED

**REVISIONS:** DESCRIPTION DATE

DRAWING SHEET NO:

**S5.1** 

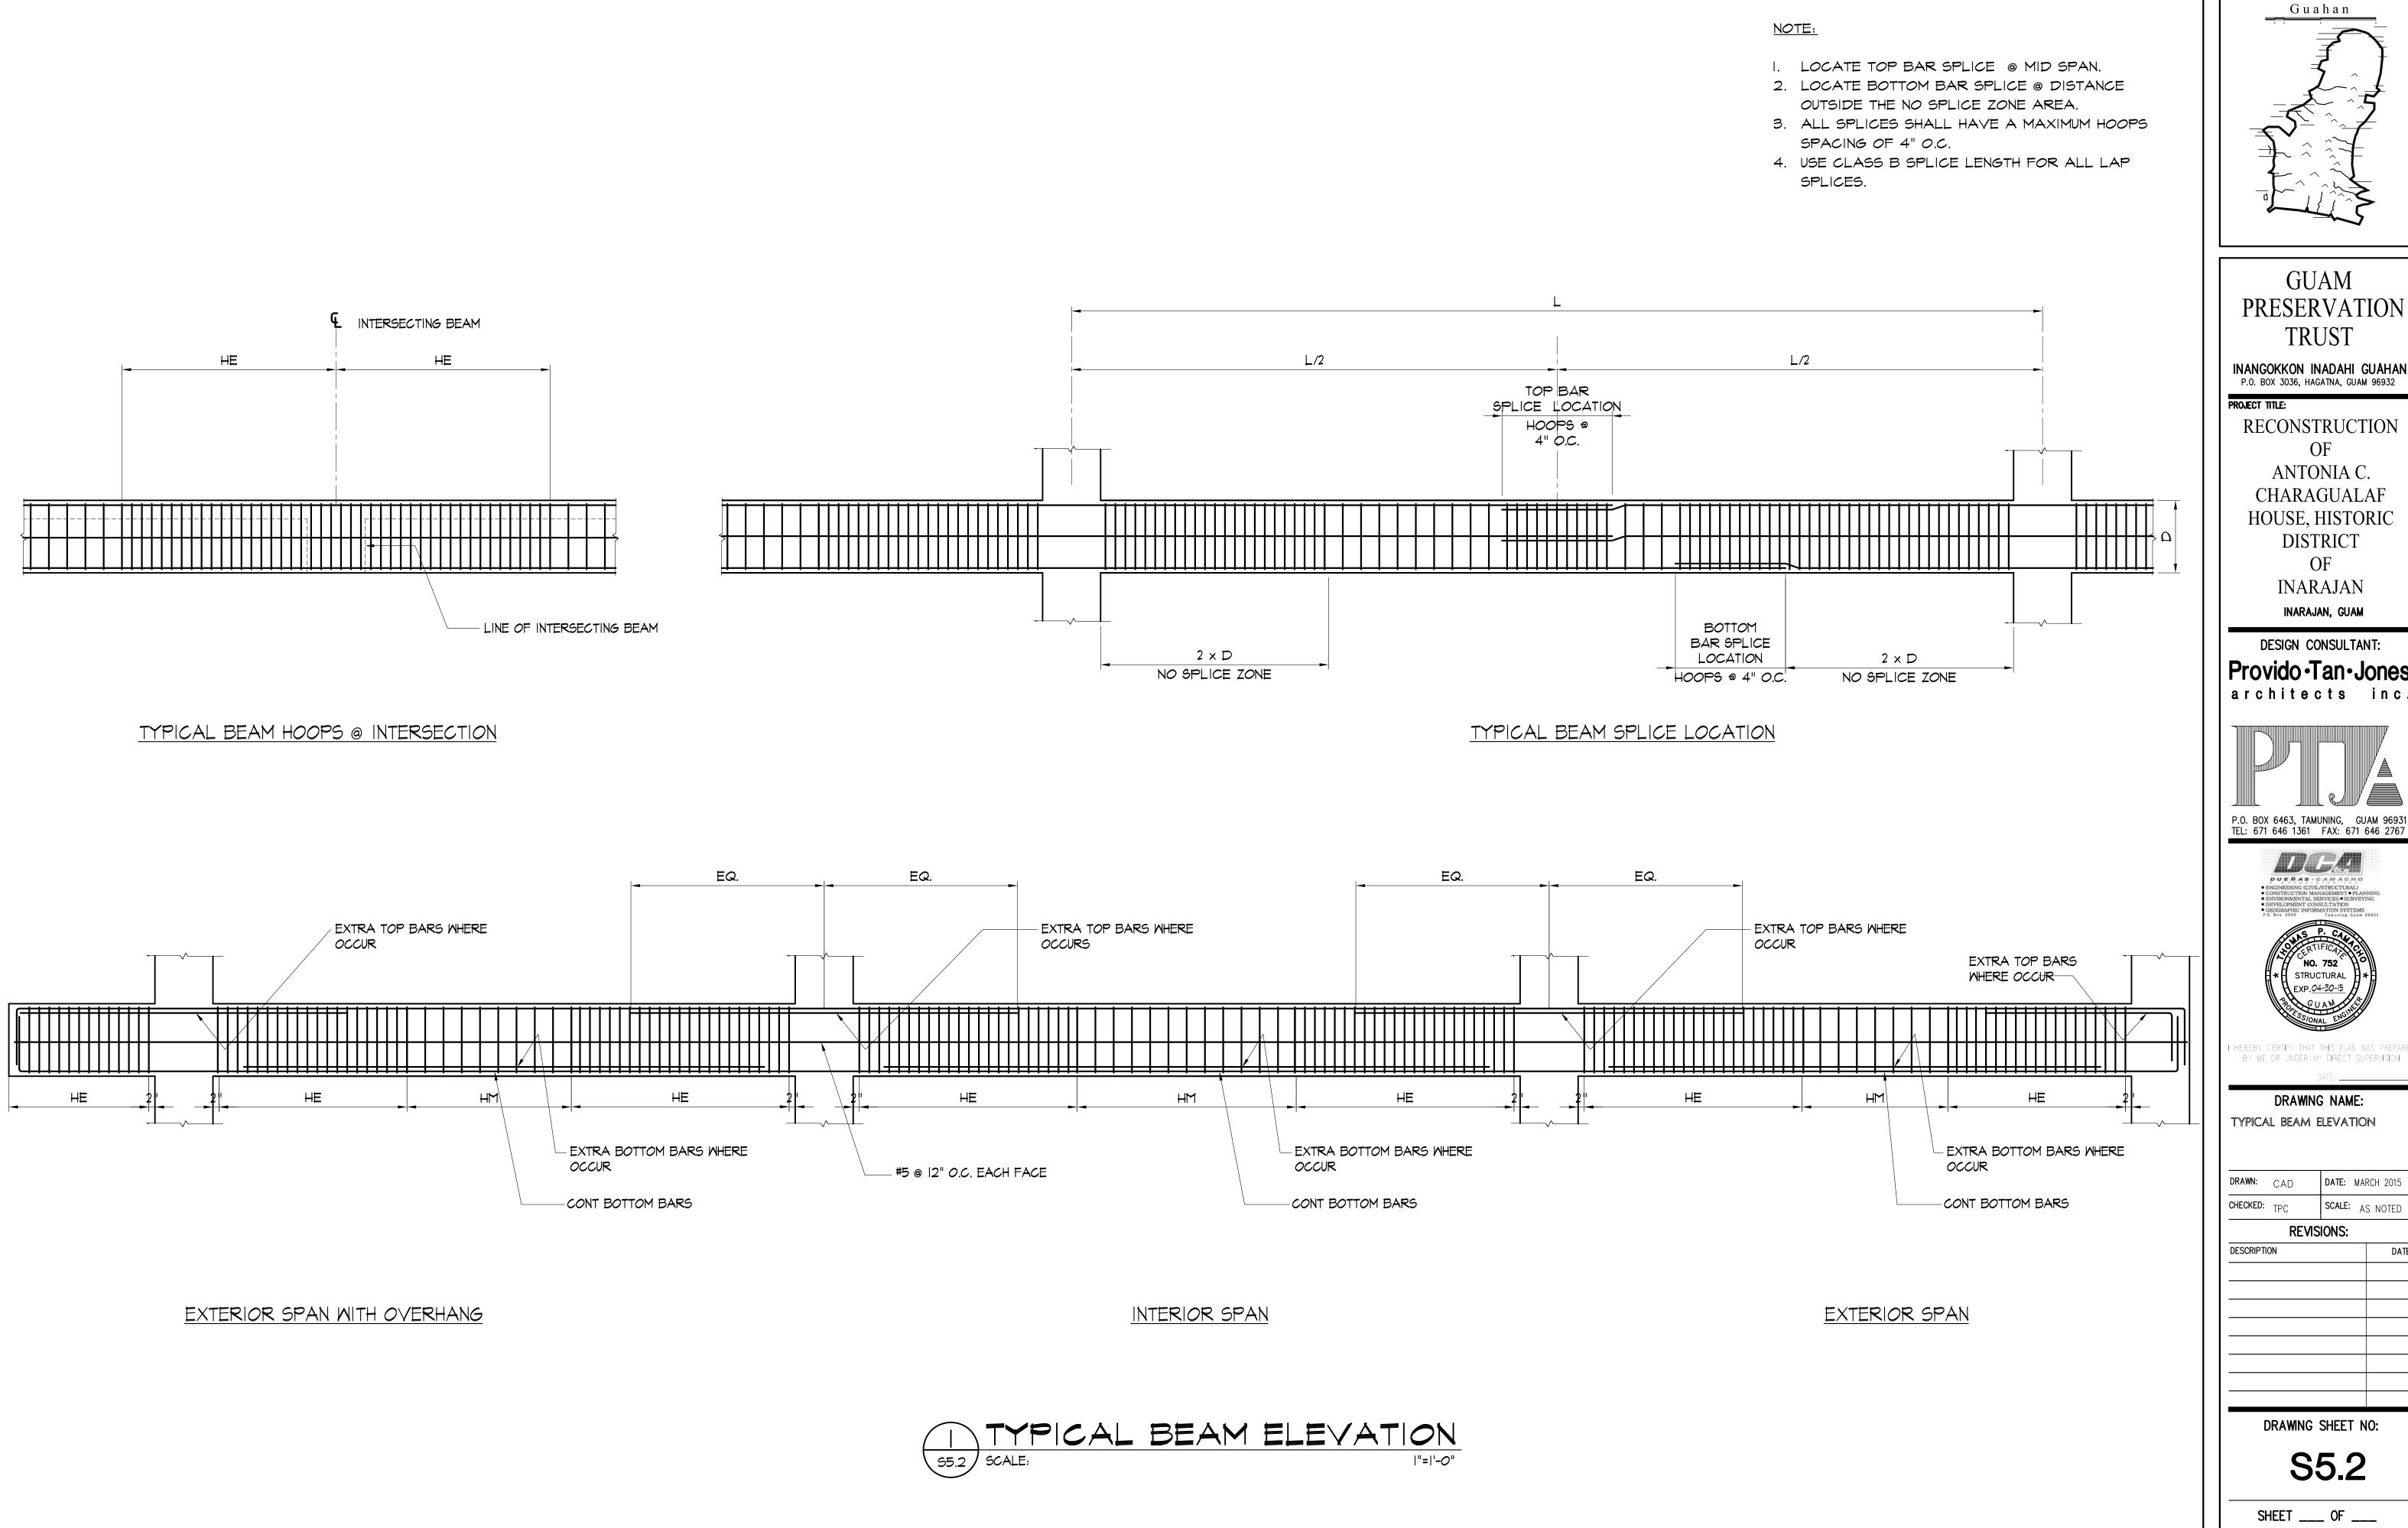

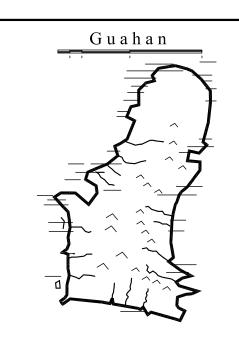

INANGOKKON INADAHI GUAHAN P.O. BOX 3036, HAGATNA, GUAM 96932

RECONSTRUCTION ANTONIA C. CHARAGUALAF HOUSE, HISTORIC DISTRICT

> INARAJAN INARAJAN, GUAM

# DESIGN CONSULTANT:

| Provido · Tan · Jones architects inc.



P.O. BOX 6463, TAMUNING, GUAM 96931 TEL: 671 646 1361 FAX: 671 646 2767




DRAWING NAME:

TYPICAL BEAM ELEVATION

DRAWN: CAD DATE: MARCH 2015 SCALE: AS NOTED

**REVISIONS:** 

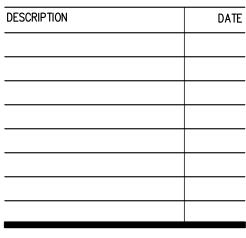

DRAWING SHEET NO:

**S5.2** 

### GENERAL NOTES


- 1. CONFORM TO ALL REQUIREMENTS OF THE BUILDING, PLUMBING AND ELECTRICAL CODES, GOVERNMENT OF GUAM AGENCIES HAVING JURISDICTION, AND OTHER APPLICABLE REGULATIONS FOR THE PROJECT.
- 2. INSTALLATION SHALL BE GUARANTEED TO BE FREE FROM DEFECTS FOR ONE YEAR FROM DATE OF FINAL ACCEPTANCE OF THE PROJECT AS A WHOLE.
- 3. DUCT SIZES NOTED ARE NET INSIDE DIMENSIONS.
- 4. CONTRACTOR SHALL VERIFY ALL FIELD CONDITIONS PRIOR TO BID AND CONSTRUCTION.
- 5. COORDINATE ALL WORK WITH OTHER TRADES TO AVOID INTERFERENCES AND DELAYS.
- 6. PAY FOR ALL PERMIT FEES AND APPLICATIONS.
- 7. PROVIDE ADDITIONAL MATERIALS AND LABOR FOR A COMPLETE OPERABLE SYSTEM AT NO EXTRA COST TO THE OWNER.
- 8. PROVIDE ACCESS PANELS FOR ALL ITEMS UNDER THIS SECTION REQUIRING SERVICING, INSPECTION, MAINTENANCE AND ADJUSTMENT.
- 9. PREPARE SIX (6) SETS OF SHOP DRAWINGS, SUBMITTED TO THE ENGINEER FOR APPROVAL PRIOR TO START OF WORK. PREPARE ONE SET OF REPRODUCIBLE AS—BUILT DRAWINGS SHOWING THE ACTUAL INSTALLED CONDITIONS AND SUBMIT TO THE OWNERS UPON COMPLETION OF WORK.
- 10. CONTRACTOR SHALL OBTAIN ALL NECESSARY INFORMATION FROM THE OWNER TO MAKE ALL FINAL EQUIPMENT CONNECTIONS. FINAL CONNECTIONS SHALL INCLUDE BUT NOT BE LIMITED TO HOT AND COLD WATER SHUT-OFF VALVES, P-TRAPS, VACUUM BREAKERS, UNIONS, WASTE AND INDIRECT WASTE CONNECTIONS, REGULATORS, ETC.
- 11. ALL EXISTING PIPING SHOWN IS BASED ON DRAWINGS MADE AVAILABLE AT THE TIME OF DESIGN, ALL LINE SIZES AND LOCATIONS MUST BE VERIFIED ON THE FIELD.
- 12. OMISSIONS: IT IS THE INTENT OF THE PLANS AND SPECIFICATIONS TO PROVIDE A COMPLETE INSTALLATION. SHOULD THERE BE OMISSIONS, THE CONTRACTOR SHALL CALL THE ATTENTION OF THE ENGINEER TO SUCH OMISSIONS TEN (10) DAYS IN ADVANCE OF THE DATE OF BID OPENING SO THAT THE NECESSARY CORRECTIONS CAN BE MADE.
- 13. THE INSTALLATION SHALL CONFORM TO THE LATEST APPLICABLE INDUSTRY STANDARDS UNLESS SPECIFICALLY NOTED OTHERWISE.
- 14. ADDITIONAL WORK: THE DESIGN IS BASED ON EQUIPMENT AS DESCRIBED IN THE DRAWINGS. ANY CHANGE IN ELECTRICAL, WIRING, CONDUIT, CONNECTIONS, PIPING, CONTROLS, AND OPENINGS REQUIRED BY ALTERNATE EQUIPMENT SPECIFIED AND SUBMITTED AND APPROVED SHALL BE PAID FOR BY THIS CONTRACTOR.
- 15. PRODUCT DELIVERY, STORAGE AND HANDLING: FURNISH NEW FIXTURES, MATERIALS AND ACCESSORIES BEARING THE MANUFACTURER IDENTIFICATION. COORDINATE DELIVERIES TO AVOID INTERFERENCES OF CONSTRUCTION DELAYS. PROTECT PRODUCTS DURING DELIVERY, STORAGE, INSTALLATIONS, AND THE REMAINDER OF THE CONSTRUCTION PERIOD AFTER INSTALLATION.
- 16. AS-BUILT DRAWINGS: SUBMIT UPON COMPLETION OF THE PROJECT ONE SET OF REPRODUCIBLE DRAWINGS AND THREE SETS OF PRINTS SHOWING AS-BUILT CONDITIONS, CODES, REGULATIONS AND STANDARDS

#### INSTALLATION:

- 1. PREPARATION: VISIT THE WORKSITE AND BECOME FULLY AWARE OF ALL EXISTING CONDITIONS. INVESTIGATE THE CONTRACT DOCUMENTS AND MAKE PROPER PROVISIONS TO AVOID INTERFERENCES OR CONSTRUCTION DELAYS. FURNISH OTHER TRADES WITH INFORMATION TO PROPERLY LOCATE AND SIZE OPENINGS IN THE STRUCTURE REQUIRED FOR THIS WORK. FURNISH ANCHOR BOLTS, SLEEVES, INSERTS AND SUPPORT REQUIRED FOR THIS WORK.
- 2. INSTALLATION: PERFORM WORK USING PERSONNEL SKILLED IN THE TRADE INVOLVED. PROVIDE COMPETENT SUPERVISION. FURNISH NEW EQUIPMENT, MATERIALS, AND ACCESSORIES BEARING THE MANUFACTURER'S IDENTIFICATION, AND CONFORMING TO THE RECOGNIZED COMMERCIAL STANDARDS. PROVIDE EXTRA MATERIALS AND LABOR FOR A COMPLETE OPERABLE SYSTEM AT NO EXTRA COST TO THE OWNER.
- 3. FIELD QUALITY CONTROL: TEST SYSTEMS IN ACCORDANCE WITH APPLICABLE STANDARDS, CODES AND MANUFACTURER'S RECOMMENDATIONS. PERFORM TESTS IN THE PRESENCE OF, AND TO THE SATISFACTION OF INSPECTORS HAVING JURISDICTION OVER THE WORK. ASK FOR FINAL INSPECTION BY THE ENGINEER AFTER ALL TESTS, ADJUSTMENTS AND BALANCING HAS BEEN PERFORMED.
- 4. BALANCING, ADJUSTMENT AND CLEANING: CLEAN UP WORK AREAS AND FIXTURES. ADJUST SYSTEM FOR PROPER OPERATION, READY FOR USE. TOUCH UP WITH MATCHING PAINT ALL DAMAGED FACTORY FINISHES.
- 5. CLEANING AND ADJUSTING: AT THE COMPLETION OF THE WORK, ALL PARTS OF THE INSTALLATION SHALL BE THOROUGHLY CLEANED. PIPE, VALVES, AND FITTINGS SHALL BE CLEANSED OF GREASE AND METAL CUTTINGS, AND SLUDGE THAT MAY HAVE ACCUMULATED BY OPERATION OF THE SYSTEM FOR TESTING. ANY STOPPAGE OR DISCOLORATION OR OTHER DAMAGE TO PARTS OF THE BUILDING, ITS FINISH, OR FURNISHING, DUE TO THE CONTRACTOR FAILURE TO PROPERLY CLEAN THE PIPING SYSTEM SHALL BE REPAIRED BY THE CONTRACTOR WITHOUT COST TO THE OWNER.

	LEC	SEND AND ABBR	EVI	ATIONS
SYMBOL	ABBR.	DESCRIPTION	ABBR.	DESCRIPTION
T		THERMOSTAT AND FAN SWITCH	HZ	HERTZ
			LVG	LEAVING
	۴	DEGREES FAHRENHEIT	OD	OUTSIDE DIAMETER
	ø	DIAMETER	PH	PHASE
	ACD	AIR CONDITIONING DRAIN	RL	REFRIGERANT LIQUID LINE
	A.P.	ACCESS PANEL	RLA	RATED LOAD AMPERES
	втин	BRITISH THERMAL UNITS PER HOUR	RR	RETURN AIR REGISTER
	CFM	CUBIC FEET PER MINUTE	RS	REFRIGERANT SUCTION LINE
	СОМР	COMPRESSOR	SA	SUPPLY AIR
	COND	CONDENSER	SAD	SUPPLY AIR DUCT
	DB	DRY BULB	SP	STATIC PRESSURE
	EAD	EXHAUST AIR DUCT	TSP	TOTAL STATIC PRESSURE
	EVAP	EVAPORATOR	V	VOLTAGE
	EXT	EXTERNAL	WB	WET BULB
	FLA	FULL LOAD AMPERES		

ACC	U-FCU C	OMBIN	NOITAI	I RATII	NGS																
MARK	AREA		CAPACITY UH)	SA	OA	EXT S.P.		ING AIR ATURE (°F)		NG AIR ATURE (°F)		CAL CHARAC	TERISTICS FLA	VOLTS   PHASE   HERTZ			REFRIGERA	NT TUBE S	SIZE ("OD)	WEIGHT	REMARKS
NO.	SERVED -	TOTAL	SENSIBLE	(CFM)	(CFM)	(IN)	DB	WB	DB	WB	COMP RLA	COND	EVAP	VOLIS	FIIASL IILN	12	RS	RL	ACD	(LBS)	NEMAINS
ACCU FCU	FAMILY ROOM	9,600	7,500	338	INFILTRATION	0.75	75.0	62.9	55.0	53.2	4.0	0.6	0.45	115	1 60	)	1/2"	1/4"	1	25 88	DX-SPLIT SYSTEM WITH HI-WALL TYPE DUCTLESS FAN COIL UNIT.
ACCU FCU 2	BEDROOM	4,600	3,500	160	INFILTRATION	0.75	75.0	62.5	54.7	52.6	4.0	0.6	0.3	115	1 60	)	1/2"	1/4"	1	19 88	DX-SPLIT SYSTEM WITH HI-WALL TYPE DUCTLESS FAN COIL UNIT.
ACCU FCU	LIVING	23,700	19,000	1,015	INFILTRATION	0.75	75.0	62.3	55.7	54.3	8.4	0.65	0.38	208	1 60	)	5/8"	3/8"	1	39 141	DX-SPLIT SYSTEM WITH HI-WALL TYPE DUCTLESS FAN COIL UNIT.

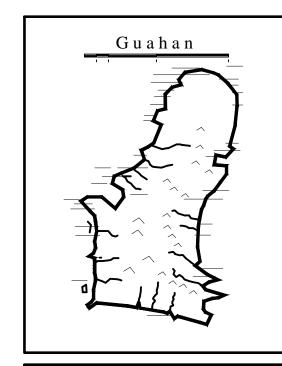

## GUAM PRESERVATION TRUST


INANGOKKON INADAHI GUAHAN P.O. BOX 3036, HAGATNA, GUAM 96932

PROJECT TITLE:

REHABILITATION
of
ANTONIA C.
CHARGUALAF
HOUSE,

HISTORIC DISTRICT OF INARAJAN, INARAJAN, GUAM

Provido Tan Jones
architects inc.

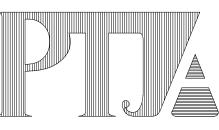

P.O. BOX 6463, TAMUNING, GUAM 96931 TEL: 671 646 1361 FAX: 671 646 2767

*\\\\\\* 



PTJA PROJECT NO: GPT.03

THIS WORK WAS DONE BY ME OR UNDER MY DIRECT SUPERVISION EXPIRATION DATE: APR, 2014

DRAWING NAME:

GENERAL NOTES

LEGEND AND ABBREVIATIONS

EQUIPMENT SCHEDULE


DRAWN:	EN	DATE:	NOVEMBER 201
CHECKED:	MN	SCALE:	AS NOTE
	REVIS	IONS:	


DESCRIPTION

DATE


DRAWING SHEET NO:

M1.0

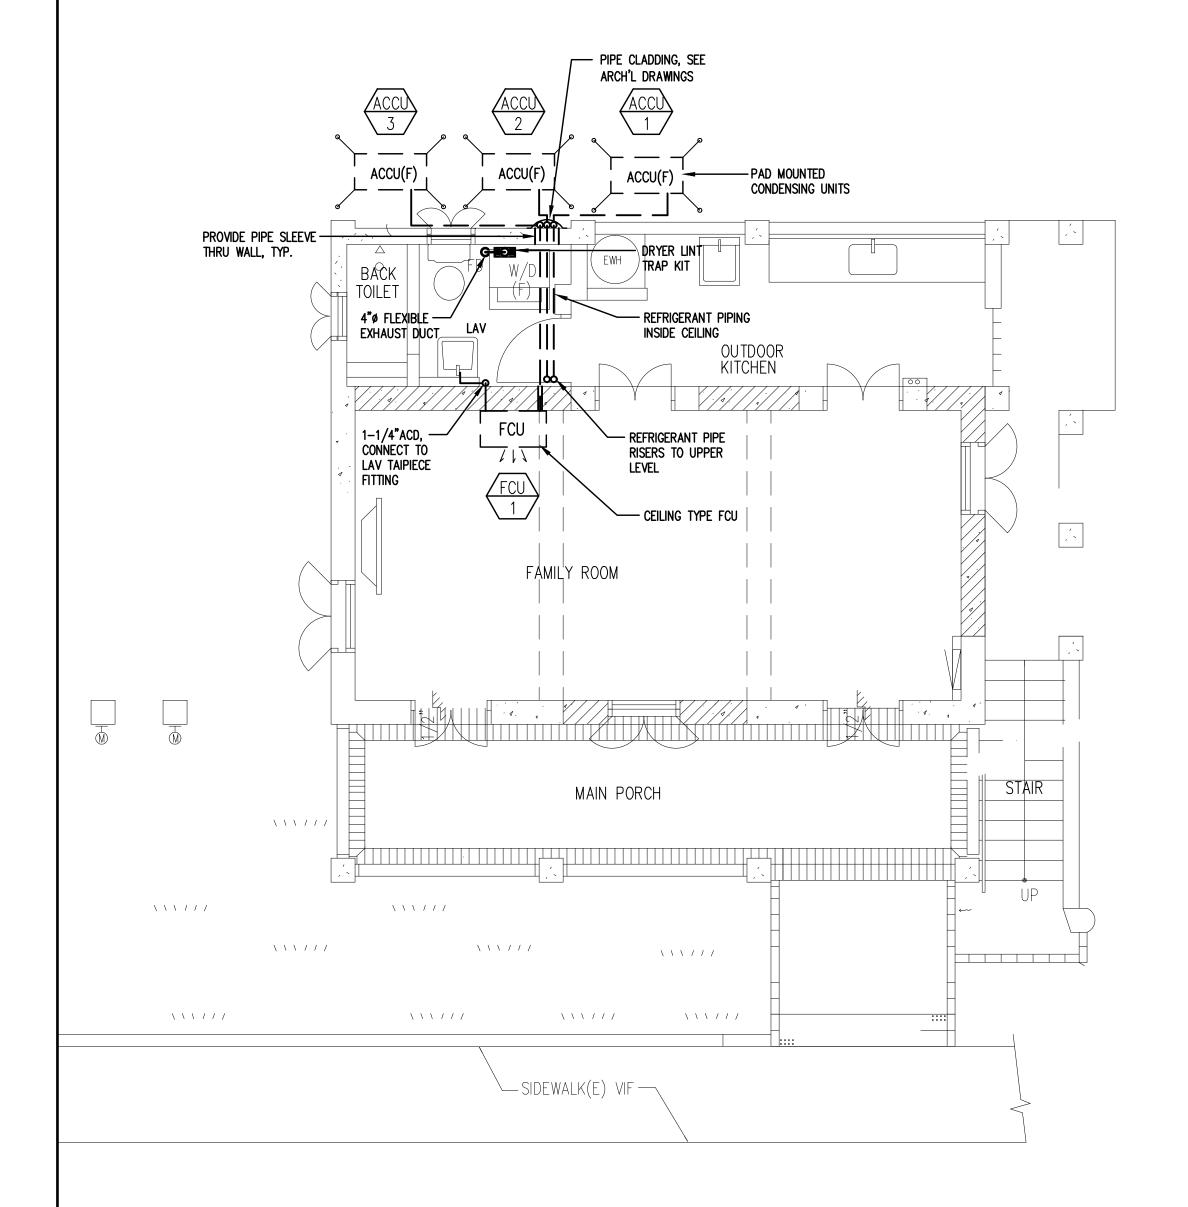

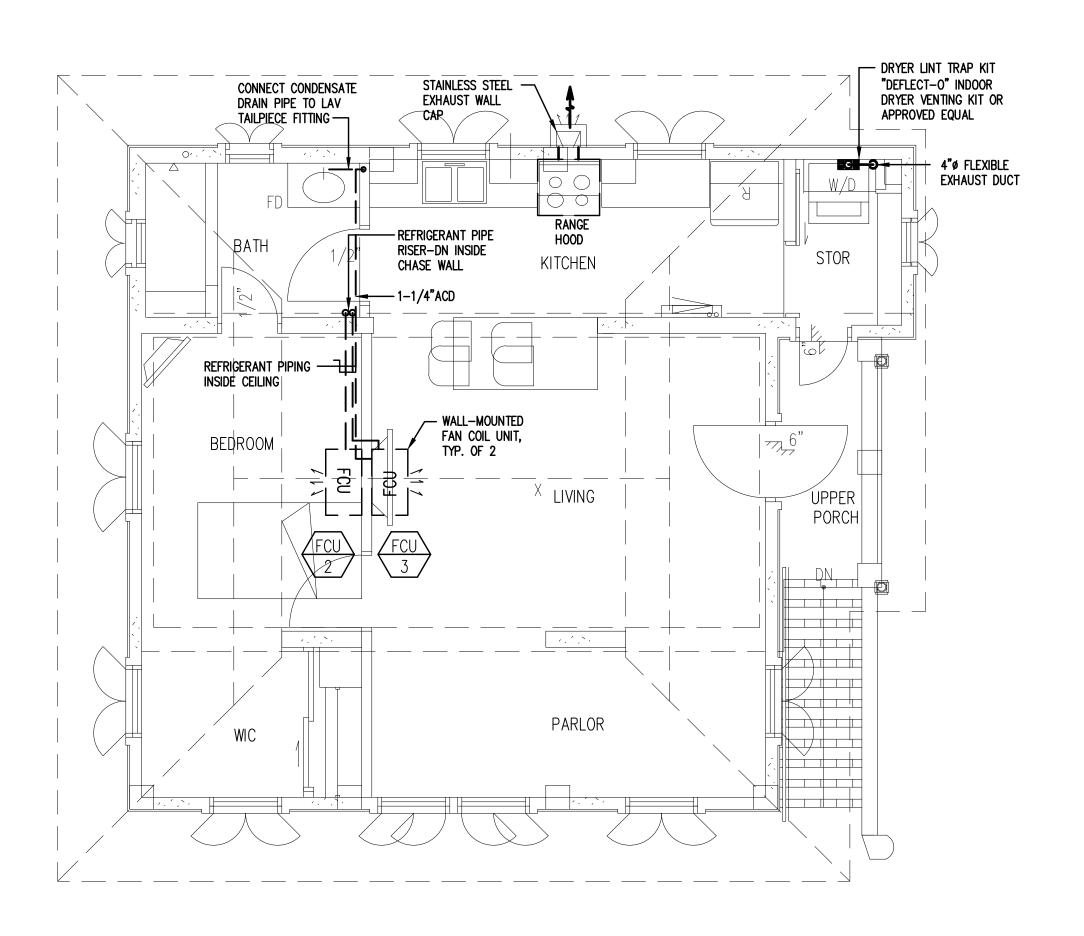




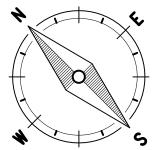

MECHANICAL PLAN@ UPPER LEVEL

M2.0 SCALE:

1/4" = 1' - 0"

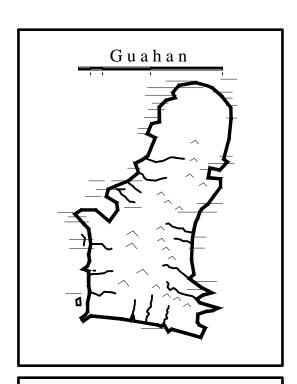

GUAM PRESERVATION TRUST


INANGOKKON INADAHI GUAHAN P.O. BOX 3036, HAGATNA, GUAM 96932

PROJECT TITLE:

REHABILITATION
of
ANTONIA C.
CHARGUALAF
HOUSE,


HISTORIC DISTRICT OF INARAJAN, INARAJAN, GUAM

Provido Tan Jones
architects inc.

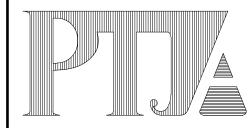

P.O. BOX 6463, TAMUNING, GUAM 96931 TEL: 671 646 1361 FAX: 671 646 2767

ENGINEERING SERVICES, LLC

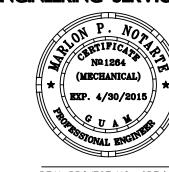

PTJA PROJECT NO: GPT.03

THIS WORK WAS DONE BY ME OR UNDER MY DIRECT SUPERVISION EXPIRATION DATE: APR, 2014

DRAWING NAME:

MECHANICAL PLAN @

BODEGA/GROUND LEVEL

MECHANICAL PLAN @ UPPER LEVEL

CHECKED: EN DATE: NOVEMBER 2014


CHECKED: MN SCALE: AS NOTED


REVISIONS:


DESCRIPTION [


DRAWING SHEET NO:

M2.0

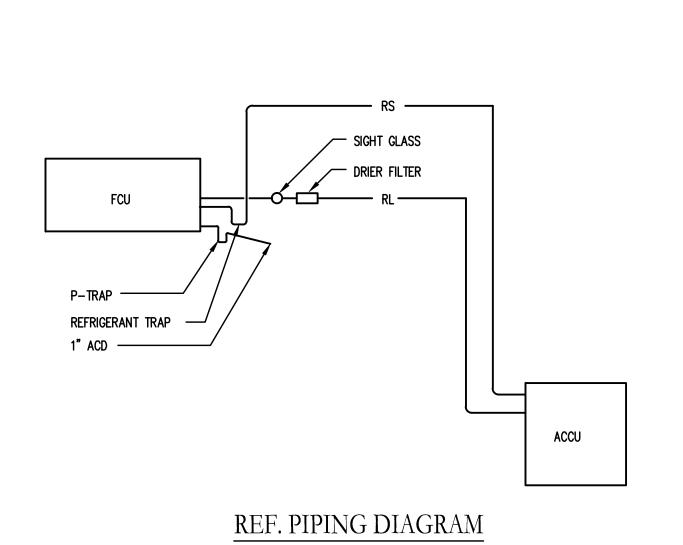

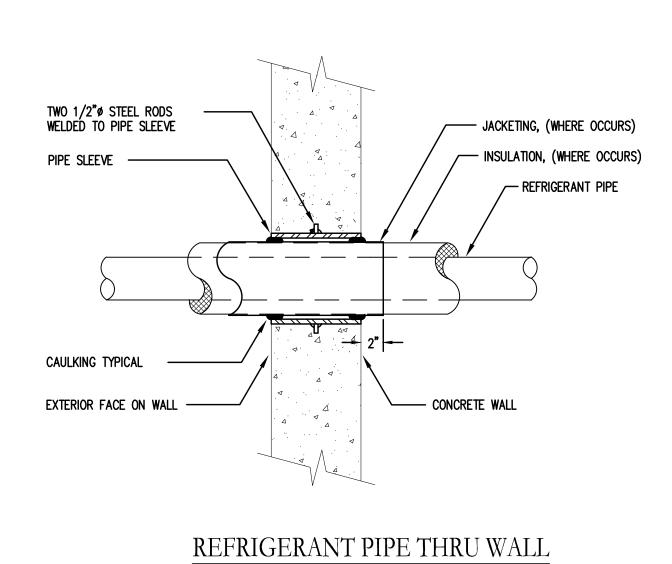


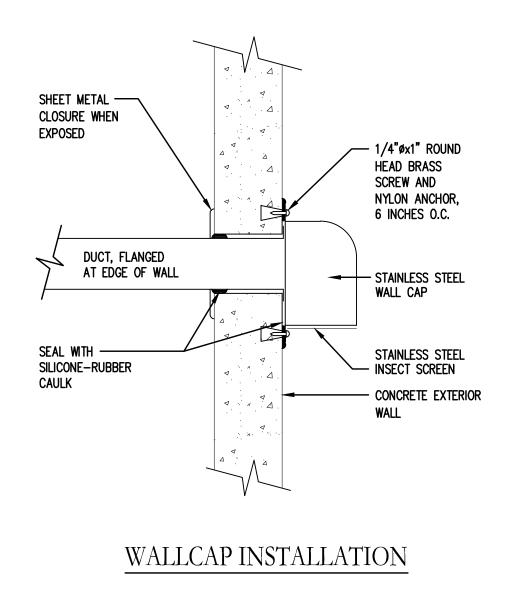

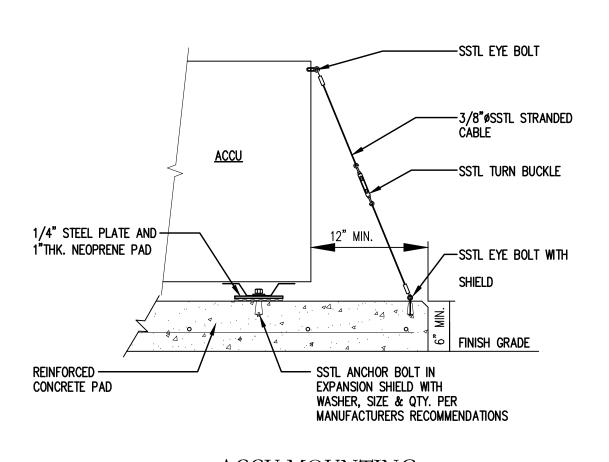

ACCU MOUNTING



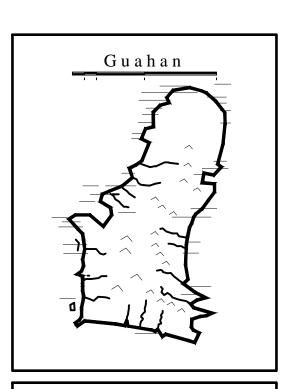


**GUAM** PRESERVATION TRUST

INANGOKKON INADAHI GUAHAN P.O. BOX 3036, HAGATNA, GUAM 96932

REHABILITATION ANTONIA C. CHARGUALAF HOUSE,

> HISTORIC DISTRICT OF INARAJAN, INARAJAN, GUAM

DESIGN CONSULTANT: Provido · Tan · Jones architects inc.

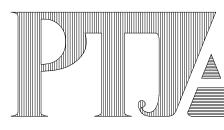

P.O. BOX 6463, TAMUNING, GUAM 96931 TEL: 671 646 1361 FAX: 671 646 2767



PTJA PROJECT NO: GPT.03 THIS WORK WAS DONE BY ME OR UNDER MY DIRECT SUPERVISION EXPIRATION DATE: APR, 2014

DRAWING NAME:

MISCELLANEOUS DETAILS

EN DATE: NOVEMBER 2014 MN **SCALE:** AS NOTED **REVISIONS:** 

DESCRIPTION

DRAWING SHEET NO:

### PLUMBING NOTES:

- 1. ALL PLUMBING WORKS SHALL CONFORM TO THE INTERNATIONAL PLUMBING CODE LATEST EDITION, THE CONTRACT DOCUMENTS AND REGULATIONS OF THE
- GOVERNMENT OF GUAM.


  2. NO PIPING SYSTEM SHALL BE BURIED OR CONCEALED UNTIL INSPECTED, TESTED AND ACCEPTED BY THE OWNER'S ENGINEER. ALL PIPING SHALL BE TESTED FOR
- 3. WATER PIPING BELOW GRADE: UNDERGROUND COPPER PIPE & FITTINGS FOR DOMESTIC WATER SUPPLY SHALL BE CORROSION PROTECTED WITH SPIRAL WRAP, 20 MIL POLYETHYLENE TAPE, LAPPED ONE HALF THE WIDTH OF TAPE, DOUBLE THICKNESS APPLICATION.
- 4. ALL HORIZONTAL VENT LOOP SHALL BE SLOPED SO AS TO ALLOW MOISTURE TO DRAIN BACK TO WASTE PIPE.
- 5. ALL WASTE LINES OR PIPING SHALL HAVE A SLOPE OF 1/4" PER FOOT.
- 6. WASTE PIPING SHALL NOT BE LESS THAN 36" AWAY FROM BUILDING WALL FOOTINGS.
  7. PROVIDE PIPE SLEEVES FOR PIPES PASSING THRU WALLS AND FOUNDATIONS.
- 8. ALL GROUND CLEANOUTS (COTG) SHALL BE PROVIDED WITH 12"x12"x4" THK CONCRETE COLLAR. COTG SHALL NOT BE MORE THAN 100'-0" APART.
- 9. VTR'S SHALL BE EXTENDED AT LEAST 18" ABOVE ROOF SLAB.
  10. PROVIDE AND SECURE DIELECTRIC UNION ON CONNECTIONS BETWEEN COPPER AND
- METALLIC PIPES.

  11. TEST ALL PIPING PRIOR TO COVERING.
- 12. USE LEAD—FREE MATERIAL AND/OR SOLDER FLUX FOR ALL POTABLE WATER.
- 13. CONTRACTOR/OWNER MUST DISINFECT/CHLORINATE ALL POTABLE WATER PIPING SYSTEM PRIOR TO USE OF WATER FOR HUMAN CONSUMPTION OR TO OCCUPY THE BUILDING.
- 14. DISINFECTION AND CHLORINATION MUST BE COORDINATED WITH GEPA STAFF. SCHEDULE OF DISINFECTION MUST BE DONE 4—WORKING DAYS IN ADVANCE.
- 15. SUBMIT BACTERIOLOGICAL AND LEAD ANALYTICAL TEST RESULTS TO GEPA FOR EVALUATION.
- 16. CHLORINATION AND DISINFECTION METHOD MUST COMPLY WITH AWWA C651-86
- 16. PERSONNEL OVERSEEING DISINFECTION SHALL HAVE A CURRENT GEPA CERTIFICATION.

LEGEND AI	ND ABBREVIATIONS
ABBR	DESCRIPTION
S OR W	SOIL OR WASTE LINE, BELOW GRADE
S OR W	SOIL OR WASTE LINE, ABOVE GRADE
٧	VENT LINE
HW	HOT WATER LINE
GV	GATE VALVE
COTG	CLEAN-OUT TO GROUND/ GRADE
EWH	ELECTRIC WATER HEATER
FC0	FLOOR CLEANOUT
FD	FLOOR DRAIN
GAL	GALLONS
НВ	HOSE BIBB
HZ	HERTZ
KS	KITCHEN SINK
KW	KILOWATT
PTRV	PRESSURE-TEMPERATURE RELIEF VALVE
SH0	SHOWER
SK	SINK
VTR	VENT THRU ROOF
WC	WATER CLOSET
wco	WALL CLEAN-OUT
WHA	WATER HAMMER ARRESTER
WMB	WASHING MACHINE UTILITY BOX

WAT	ER HEATER								
MARK NO.	AREA SERVED	STORAGE CAPACITY	RECOVERY RATE	TEMP. RISE		ELECTRICAL CH	HARACTERISTICS		REMARKS
NO.	SERVED	(GALS)	(GPH)	(°F)	kW	VOLTS	PHASE	HERTZ	
EWH 1	KITCHEN, LAUNDRY ,TOILET AND SHOWER	40	20.7	90	4.5	240	1	60	"AMERICAN WATER HEATER" MODEL E123-40R-045DH OR APPROVED EQUAL

			PLU	MBII	NG F	FIXTURE SCHEDULE
SYMBOL	DESCRIPTION	CW	HW	WASTE	VENT	MANUFACTURER/SPECIFICATIONS
WC	WATER CLOSET, FLUSH TANK	1/2"	_	4"	2"	"AMERICAN STANDARD" CHAMPION 4 ELONGATED RIGHT HEIGHT ONE-PIECE TOILET; VITREOUS CHINA; 1.6 GPF; WHITE; CHROME TRIP LEVER; EVERCLEAN ELONGATED SEAT WITH COVER AND SLOW CLOSE SNAP-OFF HINGES.
LAV-1	LAVATORY, WALL-HUNG	1/2"	1/2"	2"	2"	"AMERICAN STANDARD" DECLYN 0321.075; VITREOUS CHINA; WHITE; WITH MARQUETTE 7764EBF DUAL CONTROL CENTERSE LAVATORY FAUCET; BRONZE FINISH METAL LEVER HANDLES; 1.5 GPM MAXIMUM FLOWRATE.
LAV-2	LAVATORY-VESSEL	1/2"	1/2"	2"	2"	POLARIS SINKS PO24 STAINLESS STEEL SINK, BRUSHED SATIN; WITH SIGNATURE HARDWARE SKU 920305 11" ROTUNDA SINGLE HOLE CURVED SPOUT VESSEL FAUCET, SATIN NICKEL.
SHO	BATH/SHOWER ASEEMBLY	1/2"	1/2"	2"	2"	"AMERICAN STANDARD" 9027.502.181 SINGLE HANDLE TUB & SHOWER FAUCET; WASHERLESS CERAMIC DISK VALVE CARTRIDGE WITH VOLUME & TEMP. CONTROL; CAST BRASS VALVE BODY; HOT LIMIT SAFETY STOP; PRESSURE BALANCING CARTRIDGE; LEVER HANDLE; 2 GPM FLOW RESTRICTOR; ESTATE BRONZE FINISH.
KS-1	KITCHEN SINK, 2-COMPARTMENT	1/2"	1/2"	2"	2"	"ELKAY" DPA23322 DAYTON PREMIUM DOUBLE BOWL SINK WITH STRAINER DRAIN ASSEMBLY; STAINLESS STEEL; WITH "AMERICAN STANDARD" PORTSMOUTH 4285.501 TWO-HANDLE KITCHEN FAUCET; OIL-RUBBED BRONZE FINISH; METAL ESCUTCHEON PLATE; METAL LEVER HANDLES; 2.2 GPM MAXIMUM FLOWRATE; WITH GE 3/4 HORSEPOWER CONTINUOUS FEED DISPOSER GFC1020F
KS-2	KITCHEN SINK, 1-COMPARTMENT	1/2"	1/2"	2"	2"	"ELKAY" NLXS3322104 NEPTUNE SINGLE BOWL SINK WITH STRAINER DRAIN ASSEMBLY; STAINLESS STEEL; WITH "AMERICAN STANDARD" MONTEREY 6409.180 TWO—HANDLE KITCHEN FAUCET WITH HOSE SPRAY; OIL—RUBBED BRONZE FINISH; METAL ESCUTCHEON PLATE; METAL LEVER HANDLES; 2.2 GPM MAXIMUM FLOWRATE.
FWD	FOOD-WASTE DISPOSER/GRINDER	-	-	_	-	GE 3/4 HORSEPOWER CONTINUOUS FEED DISPOSER GFC1020F.
FD	FLOOR DRAIN	-	_	2"	2"	

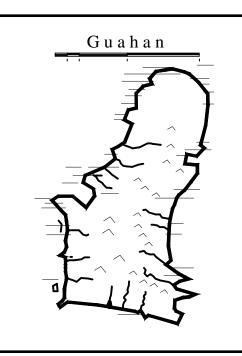

GUAM PRESERVATION TRUST


INANGOKKON INADAHI GUAHAN P.O. BOX 3036, HAGATNA, GUAM 96932

PROJECT TITLE:

REHABILITATION
of
ANTONIA C.
CHARGUALAF
HOUSE,

HISTORIC DISTRICT OF INARAJAN, INARAJAN, GUAM

Provido Tan Jones
architects inc.

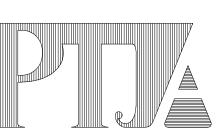

P.O. BOX 6463, TAMUNING, GUAM 96931 TEL: 671 646 1361 FAX: 671 646 2767

*V V* / V ∟ **>** 



PTJA PROJECT NO: GPT.03

THIS WORK WAS DONE BY ME OR UNDER MY DIRECT SUPERVISION EXPIRATION DATE: APR, 2014

DRAWING NAME:
GENERAL NOTES, LEGEND AND
ABBREVIATIONS, EQUIPMENT

SCHEDULE


DRAWN: EN DATE: NOVEMBER 2014
CHECKED: MN SCALE: AS NOTED


REVISIONS:

DESCRIPTION DATE

DRAWING SHEET NO:

P1.0

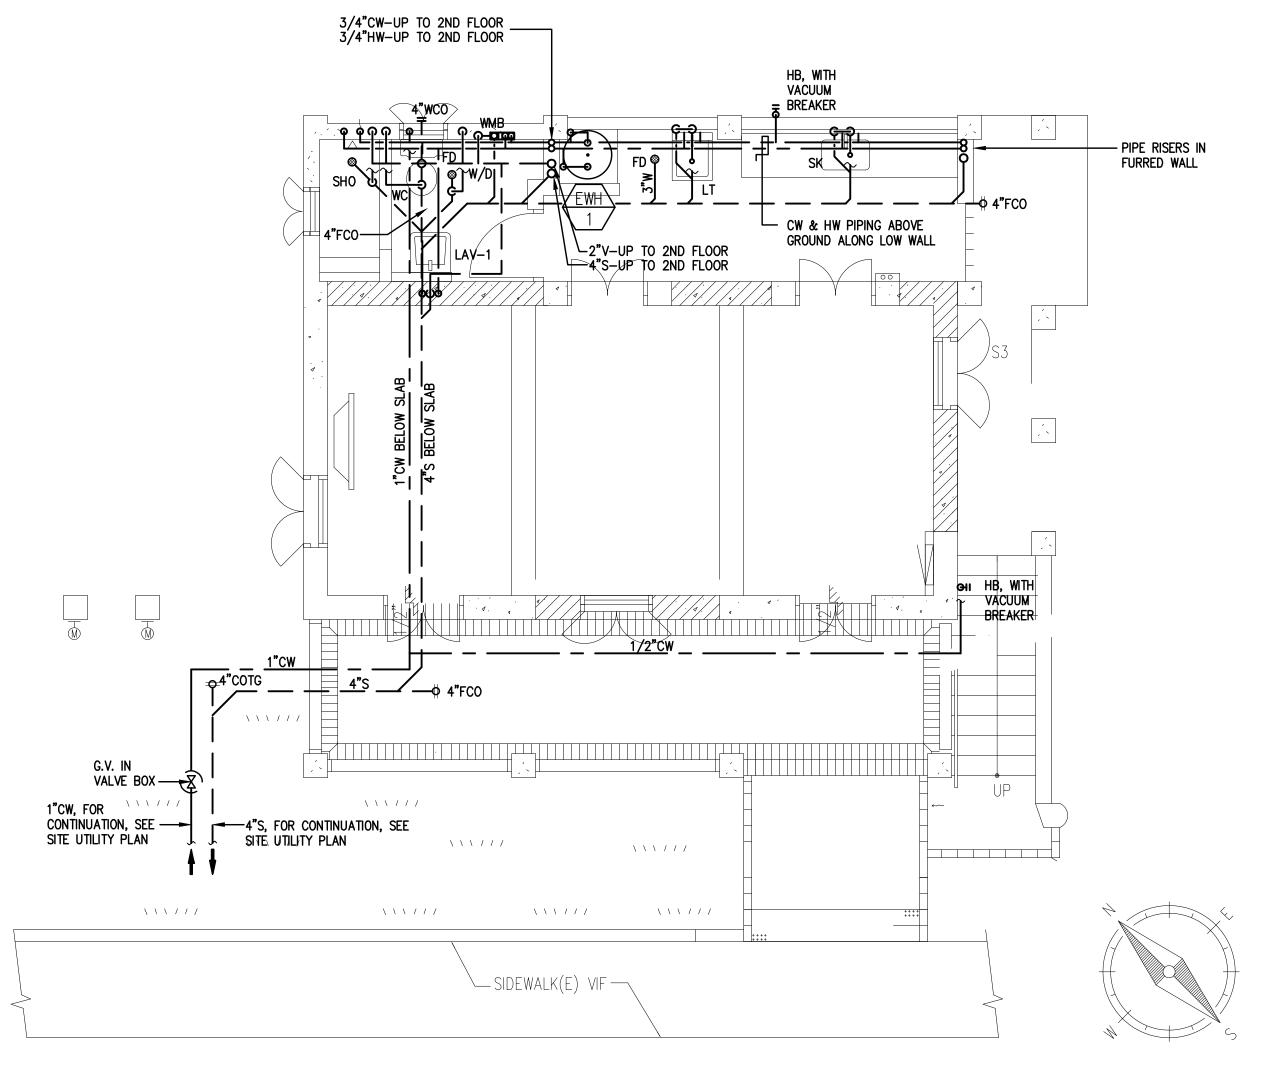

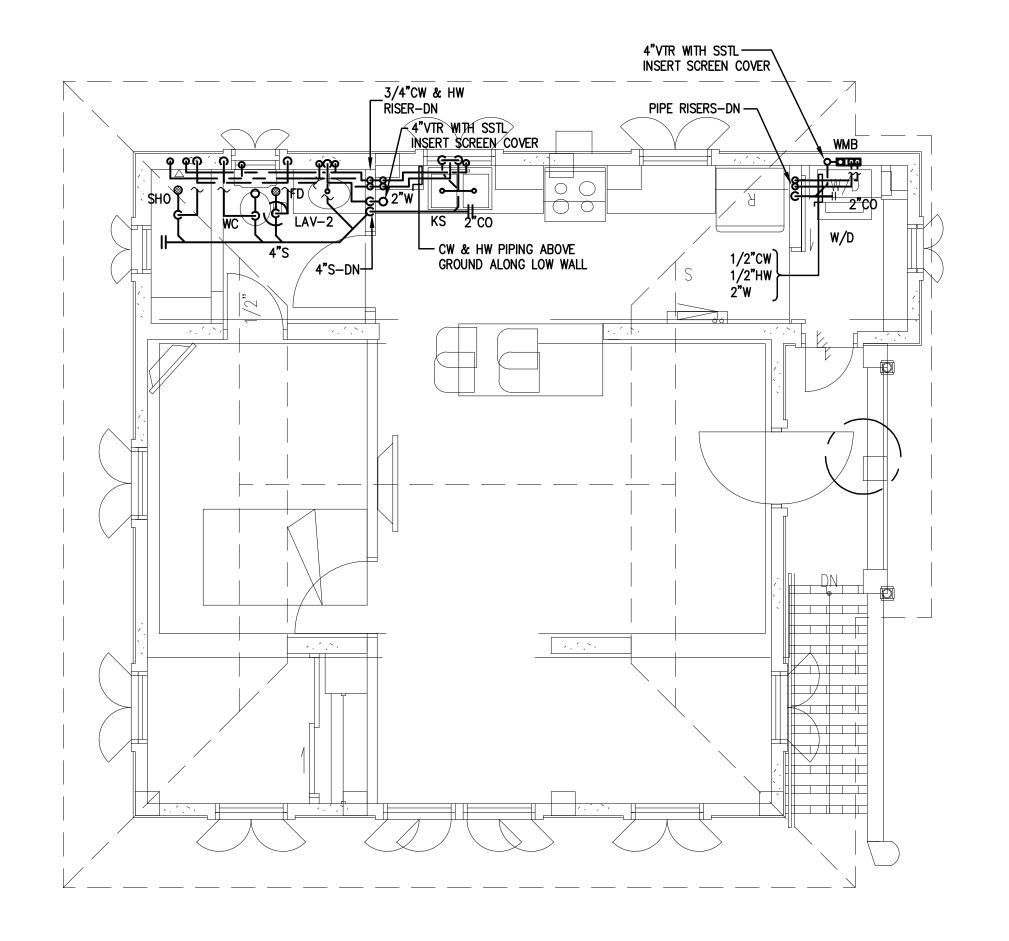


PLUMBING PLAN@ BODEGA/GROUND LEVEL

1/4" = 1' - 0"

PLUMBING PLAN@ UPPER LEVEL

1/4" = 1' - 0"

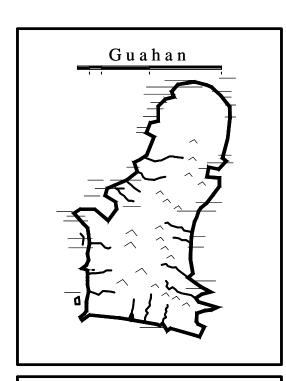

GUAM PRESERVATION TRUST

INANGOKKON INADAHI GUAHAN P.O. BOX 3036, HAGATNA, GUAM 96932

PROJECT TITLE:

REHABILITATION
of
ANTONIA C.
CHARGUALAF
HOUSE,

HISTORIC DISTRICT OF INARAJAN, INARAJAN, GUAM

Provido Tan Jones
architects inc.



P.O. BOX 6463, TAMUNING, GUAM 96931 TEL: 671 646 1361 FAX: 671 646 2767

////\_\_\_



PTJA PROJECT NO: GPT.03

THIS WORK WAS DONE BY ME OR UNDER MY DIRECT SUPERVISION EXPIRATION DATE: APR, 2014

DRAWING NAME:

PLUMBING PLANS


DRAWN: EN DATE: NOVEMBER 2014
CHECKED: MN SCALE: AS NOTED


REVISIONS:
DESCRIPTION DATE

ESCRIPTION

DRAWING SHEET NO:

P2.0

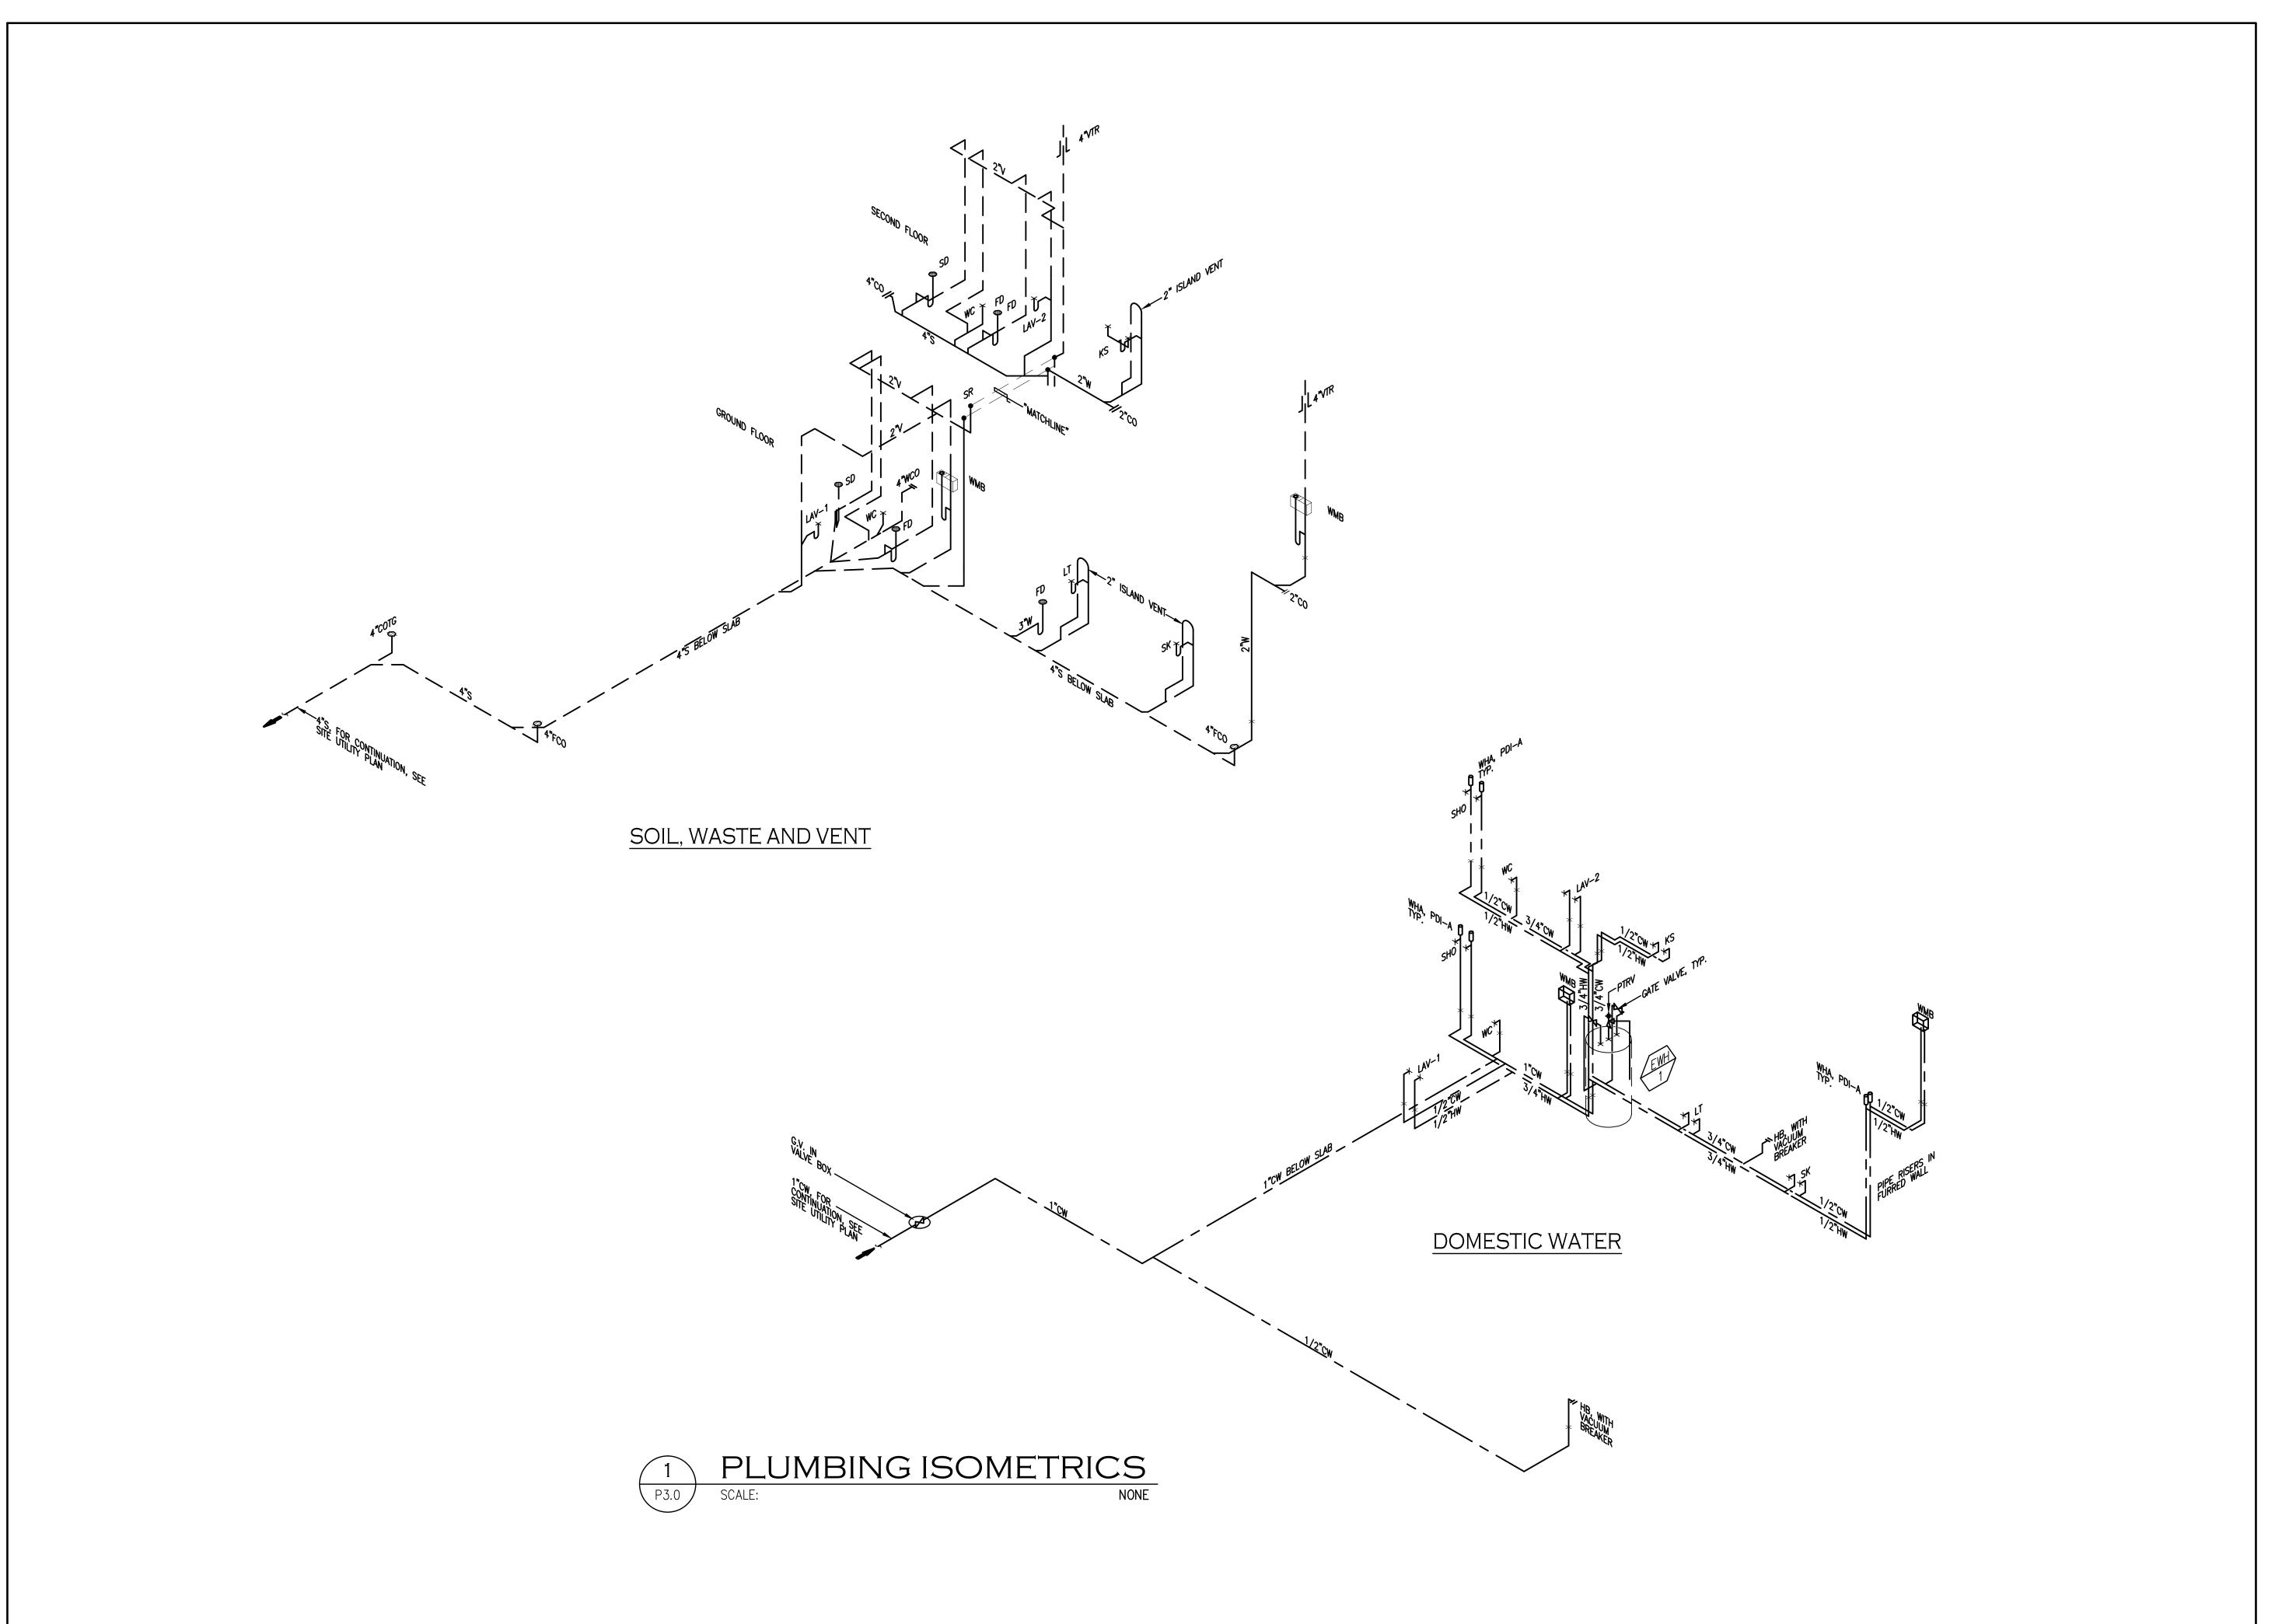

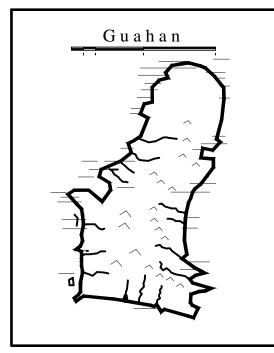

NANGOKKON INADAHI GUAHAN P.O. BOX 3036. HAGATNA. GUAM 96932

JECT TITLE:

REHABILITATION


ANTONIA C. CHARGUALAF HOUSE,

> HISTORIC DISTRICT OF INARAJAN, INARAJAN, GUAM

DESIGN CONSULTANT:

Provido Tan Jones

architects inc.

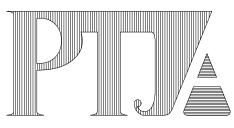

P.O. BOX 6463, TAMUNING, GUAM 96931 TEL: 671 646 1361 FAX: 671 646 2767

ENGINEERING SERVICES, LLC



PTJA PROJECT NO: GPT.03

THIS WORK WAS DONE BY ME OR UNDER MY DIRECT SUPERVISION EXPIRATION DATE: APR, 2014

DRAWING NAME:

PLUMBING ISOMETRICS

DRAWN: EN DATE: NOVEMBER 2014


CHECKED: MN SCALE: AS NOTED


REVISIONS:

DESCRIPTION

DRAWING SHEET NO:

P3.0

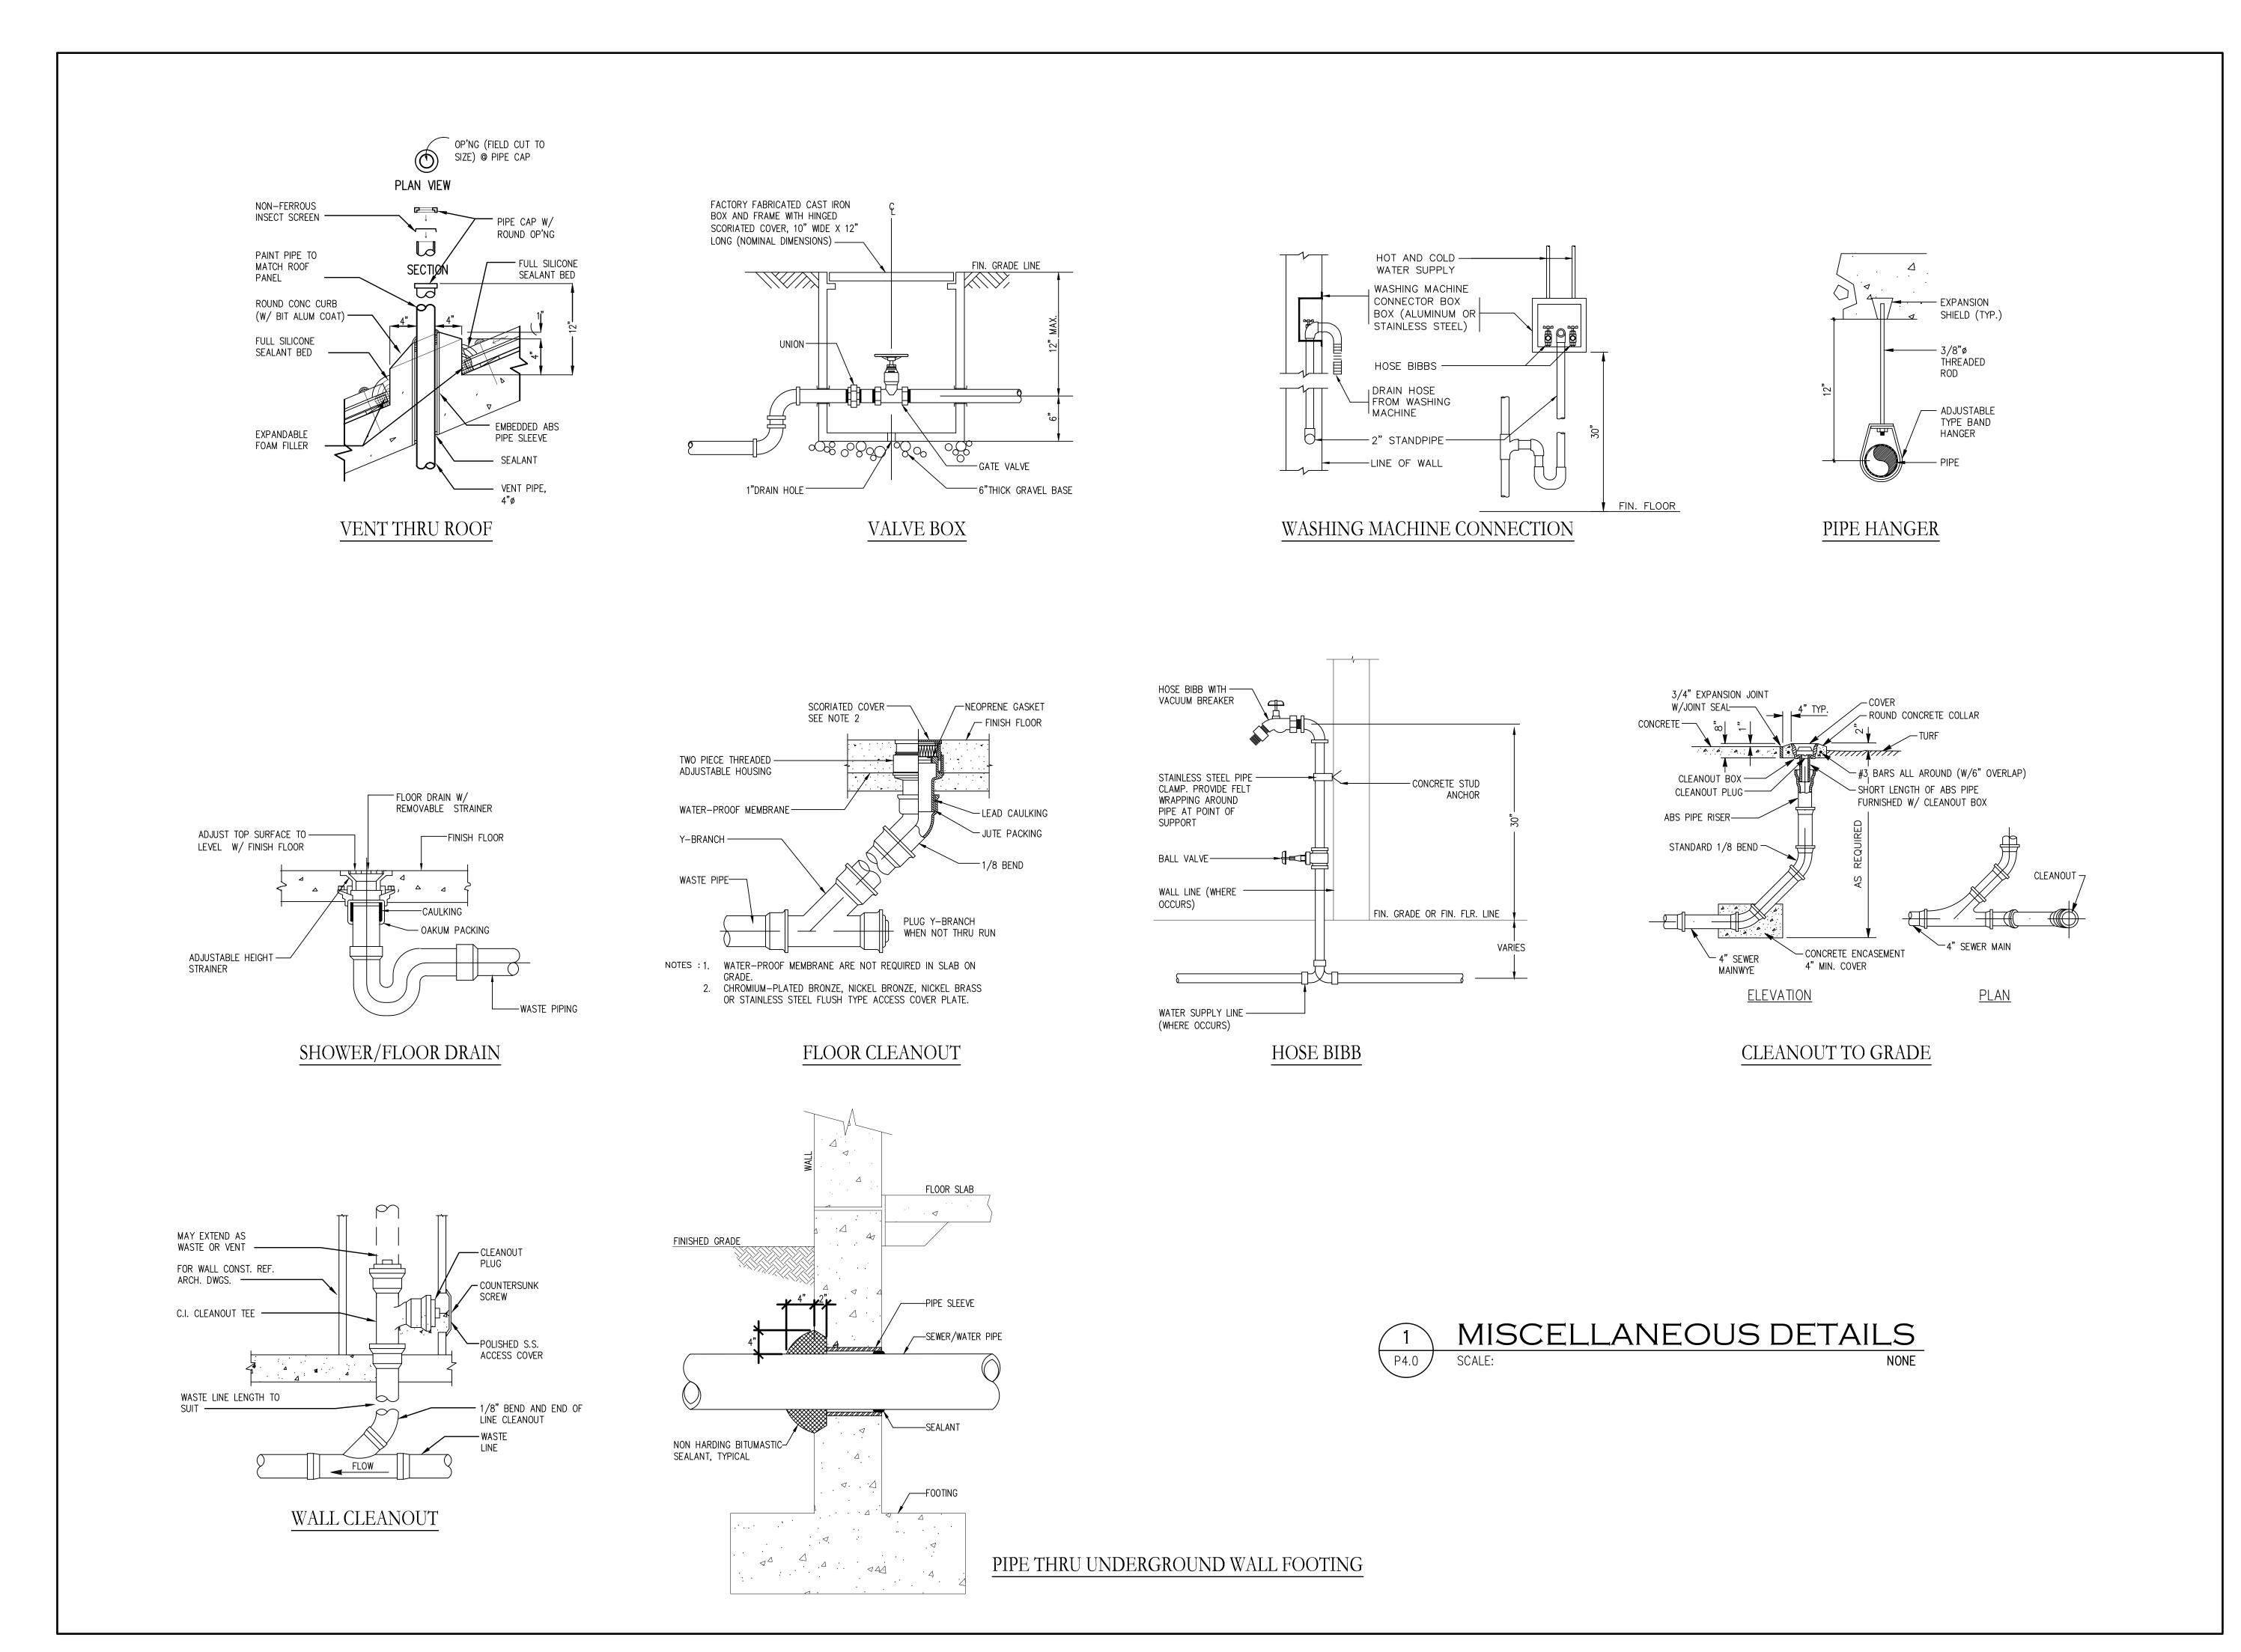

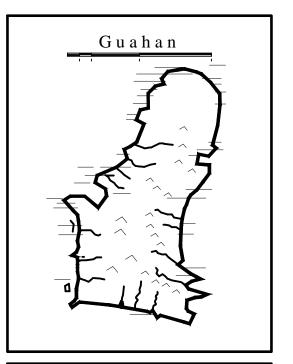


INANGOKKON INADAHI GUAHAN P.O. BOX 3036, HAGATNA, GUAM 96932

PROJECT TITLE:

REHABILITATION
of
ANTONIA C.
CHARGUALAF
HOUSE,

HISTORIC
DISTRICT OF
INARAJAN,
INARAJAN, GUAM

Provido Tan Jones
architects inc.

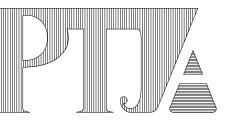

P.O. BOX 6463, TAMUNING, GUAM 96931 TEL: 671 646 1361 FAX: 671 646 2767

ENGINEERING SERVICES, LLC



PTJA PROJECT NO: GPT.03

THIS WORK WAS DONE BY ME OR UNDER MY DIRECT SUPERVISION EXPIRATION DATE: APR, 2014

DRAWNG NAME:

MISCELLANEOUS DETAILS

DRAWN:	EN	DATE: NO	VEMBER 2014
CHECKED:	MN	SCALE:	AS NOTED
	REVIS	IONS:	
DESCRIPTION			DATE

DRAWING SHEET NO:

P4.0

#### GENERAL NOTES

- 1. ELECTRICAL LAYOUT DRAWINGS ARE PARTIALLY DIAGRAMMATIC. REFER TO ARCHITECTURAL, STRUCTURAL, MECHANICAL AND HVAC FOR GUIDANCE ON DIMENSIONS, CEILING HEIGHTS, DOOR SWINGS, ROOM FINISHES, STRUCTURA AND ARCHITECTURAL DETAILS, AND LOCATIONS OF PIPES AND STRUCTURAL STEEL. INSTALL THE ELECTRICAL SYSTEMS WITHOUT INTERFERING WITH PIPES, STRUCTURAL STEEL OR OTHER SYSTEMS. LOCATE LIGHTING SYSTEMS SYMMETRICALLY IN PROPER RELATION TO FINISHED AREAS EXCEPT WHERE DIMENSIONED ON THE DRAWINGS OR LOCATED ON REFLECTED CEILING PLANS. COORDINATE WITH OTHER TRADES FOR PROPER INSTALLATION OF WORK AND FOR TIMELY EXECUTION OF CONSTRUCTION.
- FURNISH ALL LABOR, EQUIPMENT, APPLIANCES, MATERIALS AND PERFORM OPERATIONS REQUIRED FOR COMPLETE INSTALLATION OF SYSTEMS SPECIFIED IN ACCORDANCE WITH DRAWINGS, CODES, ORDINANCES AND TERMS AND CONDITIONS OF CONTRACT.
- 3. COMPLY WITH THE LATEST EDITION OF ALL APPLICABLE CODES, ORDINANCES AND REGULATIONS.
- 4. SYMBOLS IN THE LEGEND ARE APPLICABLE GENERALLY. FOR EXACT REQUIREMENTS, REFER TO THE SCHEDULES, LAYOUTS, AND DETAILS. THE APPEARANCE OF A PARTICULAR SYMBOL DOES NOT NECESSARILY IMPLY THAT THE ITEM IS INCLUDED IN THE CONTRACT.
- PROVIDE ADDITIONAL SUPPORTS FOR SWITCHES, STARTERS, RACEWAYS AND OTHER ELECTRICAL EQUIPMENT WHEREVER THE BUILDING STRUCTURE IS NOT SUITABLE FOR DIRECT MOUNTING.
- VERIFY CEILING SUSPENSION SYSTEMS IN THE VARIOUS AREAS AND PROVIDE THE PROPER MOUNTING ACCESSORIES, TRIMS, ETC. TO SUIT THE PARTICULAR AREA. SUPPORT RACEWAYS WITH APPROVED TYPES OF WALL BRACKETS OR CEILING TRAPEZE HANGER. DO NOT SUSPEND FROM DROPPED CEILING, TIE WIRE OR T-BAR. PROVIDE SAFETY WIRES FOR EACH LIGHTING FIXTURE IN NEW DROPPED CEILING SO THAT IN THE EVENT, OF CEILING FAILURE, NO PART OF THE FIXTURE WILL DROP MORE THAN 12" BELOW NORMAL CEILING HEIGHT
- 7. PROVIDE SEAL FITTINGS IN CONDUITS THAT ENTER CONDITIONED AREAS FROM NON-CONDITIONED AREAS.
- 8. PROPERLY GROUND CONDUIT SYSTEM, OUTLETS, FIXTURES, ETC. IN ACCORDANCE WITH THE NATIONAL ELECTRICAL CODE, SECTION 250. PROVIDE ALL BONDING JUMPERS AND WIRE, GROUNDING BUSHINGS, CLAMPS ETC. REQUIRED FOR COMPLETE GROUNDING. PROVIDE GREEN GROUND WIRE
- 9. CONNECT BRANCH CIRCUIT NEUTRAL TO RECEPTACLE TERMINAL BY MEANS OF A SHORT "PIGTAIL" PERMANENTLY SPLICED TO THE NEUTRAL.
- 10. PROVIDE 3/4" CONDUIT FROM EACH THERMOSTAT TO THE EQUIPMENT THAT IT CONTROLS. SEE MECHANICAL PLANS FOR THERMOSTAT LOCATIONS.
- ALL WIRING SHALL BE COPPER. ALL POWER WIRING #10 AND SMALLER SHALL BE SOLID. #8 AND LARGER MAY BE STRANDED. COLOR CODE ALL
- 12. CONTRACTOR MUST COORDINATE ALL SERVICE WORK WITH GPA. GPA MUST INSPECT AND APPROVE TRENCHING AND CONDUIT INSTALLATION PRIOR TO CONCRETE POUR. PRIOR APPROVAL FROM GPA MUST BE OBTAINED FOR ROUTING OF UNDERGROUND POWERLINE AND TRANSFORMER LOCATION.
- 13. APPLICATION OF POWER MUST BE SUBMITTED 8 MONTHS IN ADVANCE BEFORE ACTUAL SERVICE CONNECTION TO ALLOW FOR DELIVERY OF GPA MATERIALS AND EQUIPMENT.
- 14. THE OWNER MUST GRANT EASEMENT FOR THE ROUTING AND LOCATION OF UNDERGROUND POWER LINES AND EQUIPMENT.
- COORDINATE WITH GPA FOR THE INSPECTION OF TRENCH, CONDUIT LAYOUT, HANDHOLE, RISER, PAD ETC. 48 HOURS ADVANCE NOTICE IS REQUIRED. 16. ALL CONDUIT MUST BE CLEANED AND MANDRELLED IN THE PRESENCE OF GPA
- INSPECTOR AND PROVIDED WITH NYLON PULL ROPE OF 200 LB MIN. PULL STRENGTH
- 17. ALL UNDERGROUND DUCTS, BENDS AND ELBOWS SHALL BE CONCRETE ENCASED THROUGHOUT THE WHOLE ROUTE.
- 18. GPA HANDHOLE, TRANSFORMER AND METER SHALL BE ACCESSIBLE 24HRS A DAY FOR MAINTENANCE AND METER READING.
- 19. ALL ABOVE GROUND GPA CONDUITS SHALL BE RIGID ALUMINUM CONDUIT. ALL BELOW GRADE GPA CONDUIT SHALL BE CONCRETE ENCASED PVC
- 20 ALL ELECTRICAL WORK SHALL BE DONE IN ACCORDANCE WITH THE LATEST EDITIONS OF THE NATIONAL ELECTRICAL CODE (NEC) AND NATIONAL ELECTRICAL
- CONTRACTOR/OWNER SHALL IDENTIFY THE REGISTERED LAND SURVEYOR (RLS) PROPERTY MARKERS/POINTS TO THE GPA INSPECTOR AT THE JOB SITE.
- 22 PROVIDE 3 FEET MIN. CLEARANCE ALL AROUND HANDHOLES, TRANSFORMERS, AND METERING EQUIPMENT FROM FENCES, WALLS, AND STRUCTURES, ETC.
- 23 CONTRACTOR/OWNER SHALL OBTAIN A REGISTERED LAND SURVEYOR TO PROVIDE NEW POLE STAKEOUT AND DOWN-GUY LOCATIONS, IF APPLICABLE. COORDINATE WITH GPA ENGINEERING FOR SPECIFIC REQUIREMENTS.
- 24 CONTRACTOR/OWNER SHALL OBTAIN A REGISTERED LAND SURVEYOR TO PREPARE EASEMENT EXHIBITS FOR GPA POLES, HAND HOLES, TRANSFORMERS, OVERHEAD AND UNDERGROUND POWER LINES AND OTHER ASSOCIATED POWER FACILITIES. COORDINATE WITH GPA ENGINEERING FOR SPECIFIC REQUIREMENTS.
- 25 ALL SURVEY STAKEOUTS, MAPS, AND EASEMENT DOCUMENTS SHALL BE FIELD VERIFY BY THE GPA.
- 26 HANDHOLE AND COVER CONCRETE STRENGTH SHALL BE 3000 PSI
- 27 PROVIDE ADDITIONAL PRIMARY HANDHOLE AFTER THE PRIMARY RISER, IF APPLICABLE.
- 28 PROVIDE PIPE GUARD PROTECTION FOR HANDHOLES AND TRANSFORMERS.
- THESE SHALL BE PLACED 1 FOOT DIAGONAL FROM EACH CORNER. 29 NO CONDUITS SHALL BE INSTALLED ABOVE OR INSIDE ROOF SLAB
- 30 ALL SURFACE MOUNTED CONDUITS SHALL BE EMT. ROMEX IS NOT ALLOWED
- 31 ALL EXTERIOR OUTLETS SHALL BE WP/GFI RATED.
- 32 ELECTRICAL CONDUITS SHALL BE RUN IN A CONCEAL MANNER UNLESS APPROVED BY ARCHITECT OR ELECTRICAL ENGINEER FOR THE SPECIFIC LOCATION. GC SHALL SUBMIT A ONE-LINE CONDUIT LAYOUT PLAN FOR REVIEW. AN EXAMPLE OF AN ONE-LINE CNDUIT LAYOUT PLAN CAN BE SEEN AT MENO HOUSE DRAWINGS, DWG SHEET NO 1/E1.2

#### LEGEND

$\triangle$	REVISION SYMBOL
WP	AS SUBSCRIPT DENOTES "WEATHERPROOF"
GFI	GROUND FAULT CIRCUIT INTERRUPTER

TRANSFORMER MOTOR CONNECTION BRANCH CIRCUIT. I = HOT. | = NEUTRAL, ? = SWITCHED

FLEXIBLE CONDUIT MAGNETIC MOTOR STARTER

DISCONNECT SWITCH - UNFUSED DISCONNECT SWITCH - FUSED COMBINATION MOTOR STARTER - DISCONNECT JUNCTION BOX

DUPLEX CONVENIENCE OUTLET QUADRAPLEX CONVENIENCE OUTLET SINGLE POLE SWITCH

THREE - WAY SWITCH THERMAL OVERLOAD SWITCH, MANUAL STARTER

TELEPHONE OUTLET - WALL CABLE TV OUTLET - WALL CIRCUIT BREAKER

AMP FRAME AMP TRIP CONTACTOR COIL

ROOM NUMBER REFER TO NOTE INDICATED HORSE POWER

EMERGENCY LIGHT, CIRCUIT OR PANEL EXHAUST FAN

NIGHT LIGHT CIRCUIT OR FIXTURE PHOTO CELL LCC LIGHTING CONTROL CONTACTOR

TIME CLOCK NOT IN CONTRACT LIGHTING FIXTURE KEY - SEE SCHEDULE CURRENT TRANSFORMER

EQUIPMENT CONNECTION CALLOUT BATTERY POWERED EMERGENCY FIXTURE BRANCH CIRCUIT PANEL

THERMOSTAT OUTLET @ 6 INCHES ABOVE COUNTERTOP

DUCT DETECTOR, BY MECHANICAL CONDUCTOR FIRE ALARM AUDIO/VISUAL DEVICE


SMOKE DETECTOR FIRE ALARM MANUAL STATION

CAMERA JUNCTION BOX

AUDIO JUNCTION BOX

DATA NETWORK CONNECTION


4 EXTERIOR BOX DETAIL

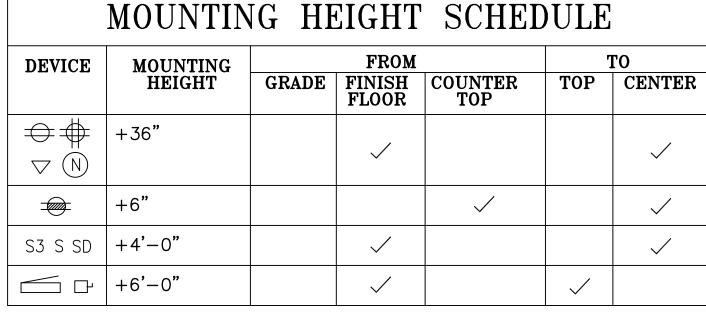


NOTES:

1. ALL DEVICE SYMBOLS ARE FOUND IN LEGEND ON THIS SHEET. 2. UNLESS OTHERWISE NOTED ON PLANS, CONTRACTOR SHALL FOLLOW MOUNTING HEIGHTS AS INDICATED IN THIS SCHEDULE.

### MOUNTING HEIGHT SCHEDULE SCALE

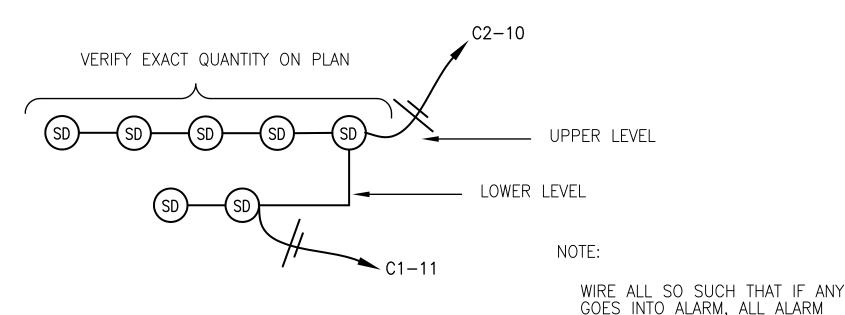


FIRE ALARM DIAGRAM

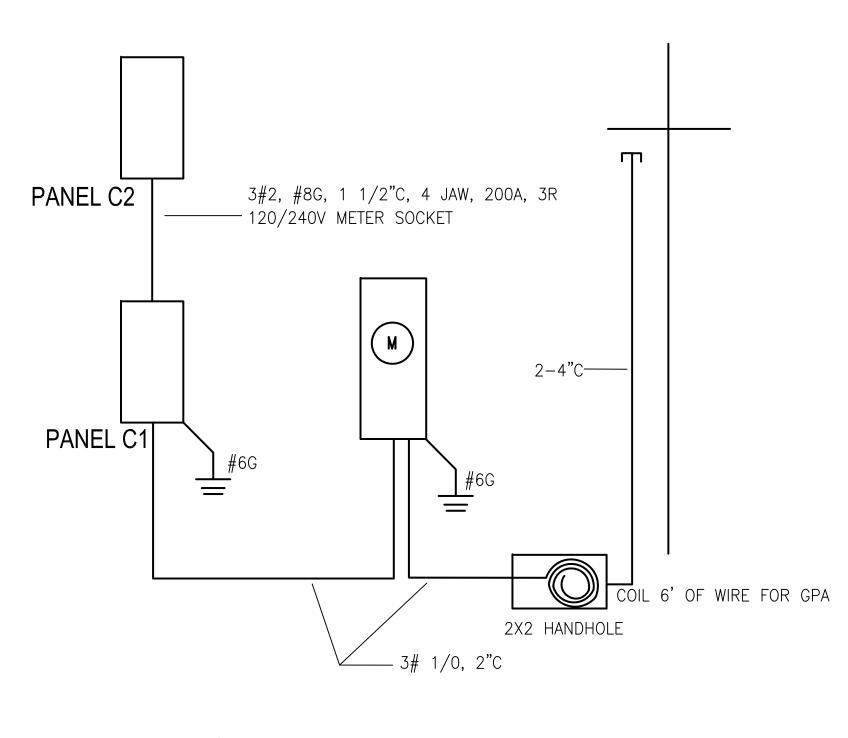




CONCEAL CONDUIT

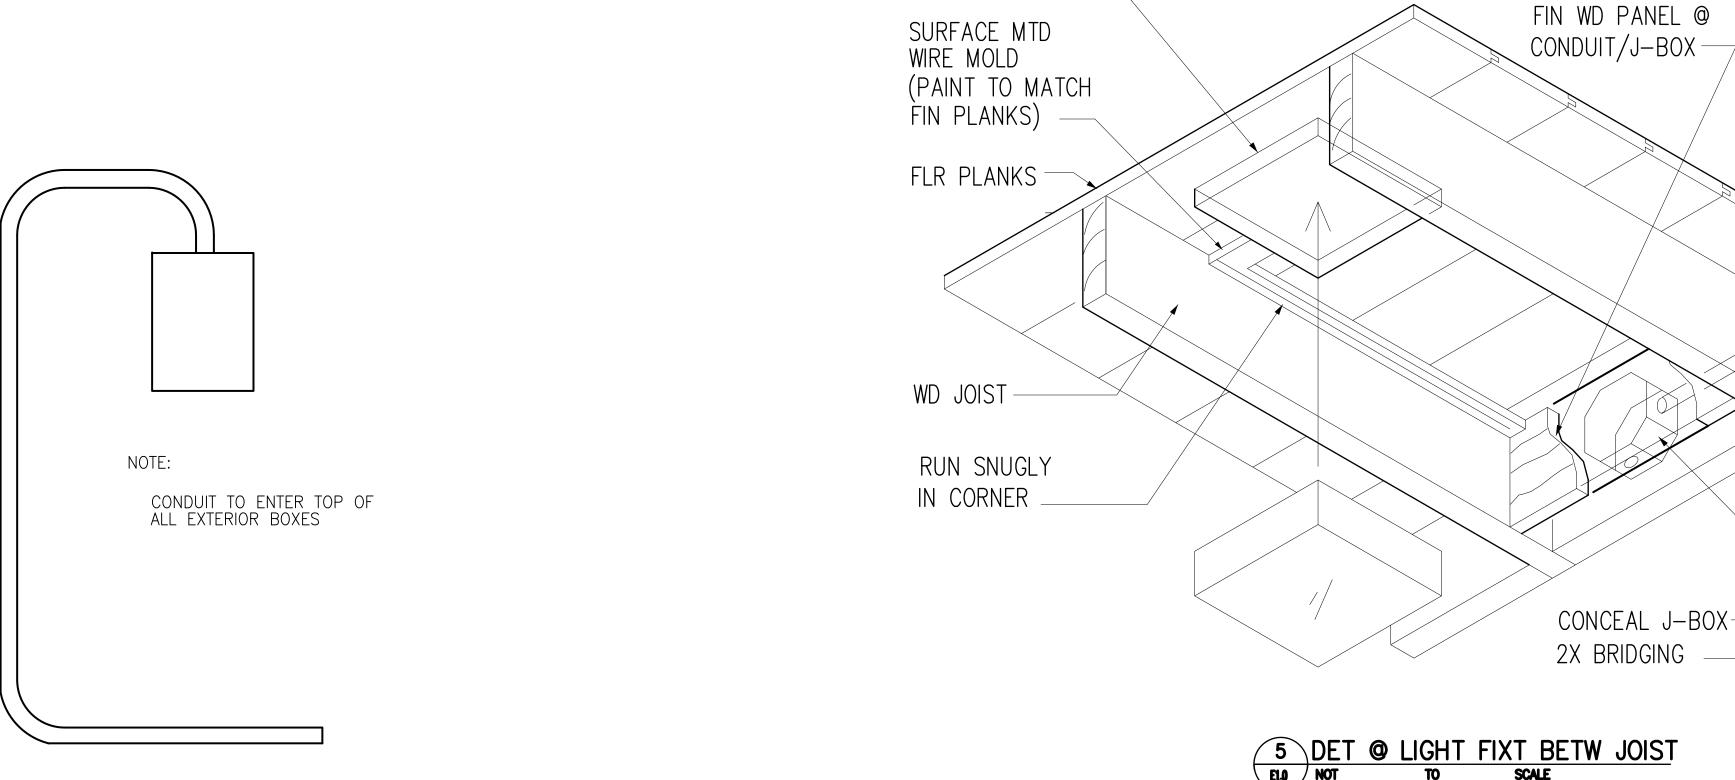

LIGHT FIXT

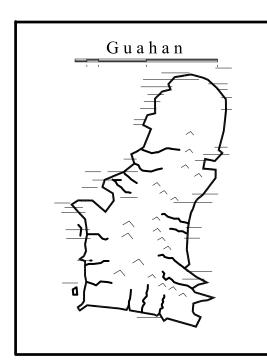

## **GUAM PRESERVATION** TRUST

INANGOKKON INADAHI GUAHAN P.O. BOX 3036, HAGATNA, GUAM 96932


RECONSTRUCTION **ANTONIO** CHARGUALAF HOUSE,

HISTORIC DISTRICT OF INARAJAN, INARAJAN, GUAM

**DESIGN CONSULTANT:** 





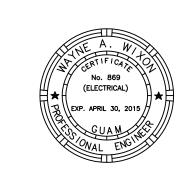

I CERTIFY THAT THIS DRAWING WAS PREPARED BY ME OR UNDER MY DIRECT SUPERVISION.


### DRAWING NAME: GENERAL NOTES & DIAGRAMS

AWN:	TC	DATE:	NΟN	/EMBER	20
ECKED:	WW	SCALE:		AS N	IOT
	REVIS	IONS:			
SCRIPTION					DA <sup>*</sup>
DRA	WING :	SHEE	ΓΝ	10:	

			PAN	IEL "C	1" - 15	0 AMF	P (N)			
		120/240	VOLTS 1					IRFACE		
CIRCUIT DESCRIPTION	WIRE SIZE	VA	AMP	СКТ	PH	СКТ	AMP	VA	WIRE SIZE	CIRCUIT DESCRIPTION
MAIN PORCH REC	12	360	20/1	1	А	2	20/1	1,080	12	FAMILY ROOM REC
KITCHEN REC	12	1,500	20/1	3	В	4	20/1	1,500	10	LIGHTING
ELECTRICAL MATER HEATER	10	2,250	30/2	5	Α	6	20/1	863	12	ACCU-1
ELECTRICAL WATER HEATER	10	2,250	30/2	7	В	8	30/2	2,500	10	WACHED/DDVED
ACCU AREA RECEPTACLE	12	1,500	20/1	9	Α	10	30/2	2,500	10	WASHER/DRYER
SMOKE DETECTOR	12	200	20/1	11	В	12	20/1	1,000	12	GARBAGE DISPOSAL
PANEL C2	2	14,496	100/2	13	Α	14	20/1			SPARE
PANEL GZ	2	12,690	100/2	15	В	16	20/1			SPARE
SPARE			20/1	17	Α	18	20/1			SPARE
SPARE			20/1	19	В	20	20/1			SPARE
SPARE			20/1	21	Α	22	20/1			SPARE
SPARE			20/1	23	В	24	20/1			SPARE
SPARE			20/1	25	Α	26	20/1			SPARE
SPARE			20/1	27	В	28	20/1			SPARE
SPARE			20/1	29	Α	30	20/1			SPARE
SPARE			20/1	31	В	32	20/1			SPARE
SPARE			20/1	33	Α	34	20/1			SPARE
SPARE			20/1	35	В	36	20/1			SPARE
SPARE			20/1	37	Α	38	20/1			SPARE
SPARE			20/1	39	В	40	20/1			SPARE
BUS LOAD "A" =		23,049								
BUS LOAD "B" =		21,640								
TOTAL BUS LOAD (W) =		44,689							+ +	
TOTAL LOAD (A) =		124.1								

	PANEL "C2" - 100 AMP (N)											
		12	0/240 VOLT	S 1 PHASE	3 WIRE	MCB 10,000	AIC SURF	ACE				
CIRCUIT DESCRIPTION	WIRE SIZE	VA	AMP	СКТ	PH	СКТ	AMP	VA	WIRE SIZE	CIRCUIT DESCRIPTION		
BEDROOM REC	12	1,080	20/1	1	А	2	20/1	1,000	12	REFRIDGERATOR		
BATHROOM RECEPTACLE	12	1,500	20/1	3	В	4	20/1	690	12	ACCU-2		
WACHED AND DOVED	10	2,500	20/0	5	А	6	20/2	1,456	12	ACOLL 2		
WASHER AND DRYER	10	2,500	30/2	7	В	8	20/2	1200	12	ACCU-3		
SPARE			20/1	9	А	10	20/1	200	12	SMOKE DETECTOR		
LIGHTING 2ND FLOOR	10	800	20/1	11	В	12	20/1	500	12	GARBAGE DISPOSAL		
KITCHEN RECEPTACLE	12	1,500	20/1	13	А	14	20/1	1,260	12	LIVING ROOM/PARLOR REC		
KITCHEN RECEPTACLE	12	1,500	20/1	15	В	16	50/0	4,000	6	OV/EN		
KITCHEN RECEPTACLE	12	1,500	20/1	17	А	18	50/2	4,000	6	OVEN		
LIGHT AND OVEN HOOD	12	1,500	20/1	19	В	20	20/1			SPARE		
SPARE			20/1	21	А	22	20/1			SPARE		
SPARE			20/1	23	В	24	20/1			SPARE		
SPARE			20/1	25	А	26	20/1			SPARE		
SPARE			20/1	27	В	28	20/1			SPARE		
	1					1						
						1			† †			
	1					†			† †			
BUS LOAD "A" =	†	14,496	<u> </u>			†			† †			
BUS LOAD "B" =	1	14,190				1			† †			
	†		<u> </u>			†		<u> </u>	† †			
OTAL BUS LOAD (W) =	1	28,686				1			† †			
TOTAL LOAD (A) =		79.68				†			1			

			CHARGULAF HOUSE LIGHT	ING FIXTURE SCHEDULE		
SYMBOL	TYPE	DESCRIPTION	LOCATION	MANUFACTURER OR EQ	LAMP	
0 1	F	FLOUR. STRIP LIGHT				
<b>─</b>	F1	FLOUR. STRIP LIGHT			?000 K MATCH INCANDESCENT	
	S	SURF MTD LIGHT	FAMILY, KITCHEN, PARLOR, BEDROOM	PROGRESS APPEAL P3490-20D1 HAMPTON BAY ESDALE 1	2-60 WATT A19 INC	
	S1	SURF MTD LIGHT	BATH, TOILET	CAPITAL LTG 5678BB	2-60 WATT A19 INC	
<b>-</b>	S2	SURF MTD PENDANT LIGHT		VINTAGE HDW & LTG ZA-100 (BRONZE) PENDANT W/ ZR-23 SHADE	1-60 WATT A19 INC	
Ī	S3	SURF MTD EXTERIOR LIGHT	FAMILY, OUTDOOR KITCHEN	BROWNLEE LTG 7155	QUAD TRIPLE FLAT TUBE FLOURESCENT	
	S4					
	S5	SURF MTD UTILITY LIGHT	STORAGE	PROGRESS P5510-31	1-60 WATT A19 INC	
	S6	SURF MTD ADJUST MINI-SPOT		GALAXY 755618 2	2-50W MR16 GU10 120V	
<b>Υ</b>	30	SURF WITD ADJUST WIINI-SPUT	FAMILY	REMCRAFT 317486G	1-50W PAR38 MED 120V	
	R	RECESSED CAN DOWNLIGHT	LIVING, BEDROOM	SEAGULL #11119 W/ #1132AT-71 TRIM OR #11155AT-15 TRIM	1 X 26 WATT 4-PIN CFL	
	R1	RECESSED DOWNLIGHT EXIT			2-50W MR16 GU10 120V	
				VINTAGE HDW & LTG 34C-DK-PRC	1-60W WATT A19 INC	
	W	WALL MTD EXTERIOR LIGHT	ENTRY PORCH	HUDSON VALLEY EDISON 101-OB-599	1-60W WATT A19 INC	
				PROGRESS P5844-31	1-60W WATT A19 INC	
Ю				VINTAGE HDW & LTG 703-RES-DK SCONCE W/ ZR-23 SHADE	1-60W WATT A19 INC	
	W1	WALL MTD LIGHT	VANITY	PROGRESS LTG VICTORY P3880-15	4 COMUMATT A40 INC	
				HUDSON VALLEY DAWSON 4602-0B	1-60W WATT A19 INC	
	W2	WALL MTD EXTERIOR LIGHT		LIGHTS OF AMERICA 9012	(1)27W TWIN TUBE GX23 CFL WATT A19 INC	
	Х	SURF MTD CLG FAN	LIVING ROOM	HUNTER LOW PROFILE III 53125		
	X1	PENDANT MTD CLG FAN W/ 2"-0 STEM (CUT TO FIT)		CASABLANCA UTOPIAN 54037.0		
	X2	PENDANT MTD CLG FAN W/ 12" STEM/SLOPE ADAPTER		HUNTER BRIDGEPORT 53125		

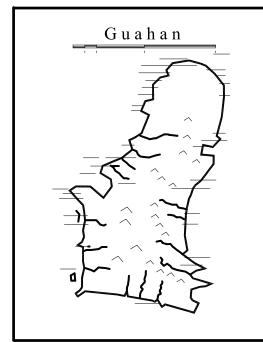

INANGOKKON INADAHI GUÅHAN P.O. BOX 3036, HAGATNA, GUAM 96932

PROJECT TITLE:

RECONSTRUCTION
of
ANTONIO
CHARGUALAF
HOUSE,

HISTORIC DISTRICT OF INARAJAN, INARAJAN, GUAM

DESIGN CONSULTANT:







I CERTIFY THAT THIS DRAWING WAS PREPARED BY ME OR UNDER MY DIRECT SUPERVISION.


DRAWING NAME:


PANELS & LEGEND

DRAWN:	TC	DATE:	NOVEM	BER	20
CHECKED:	WW	SCALE:	: A	AS N	OTE
	REVIS	IONS:			
DESCRIPTION					TAC
			4		
			+		
			+		

DRAWING SHEET NO:

E1.

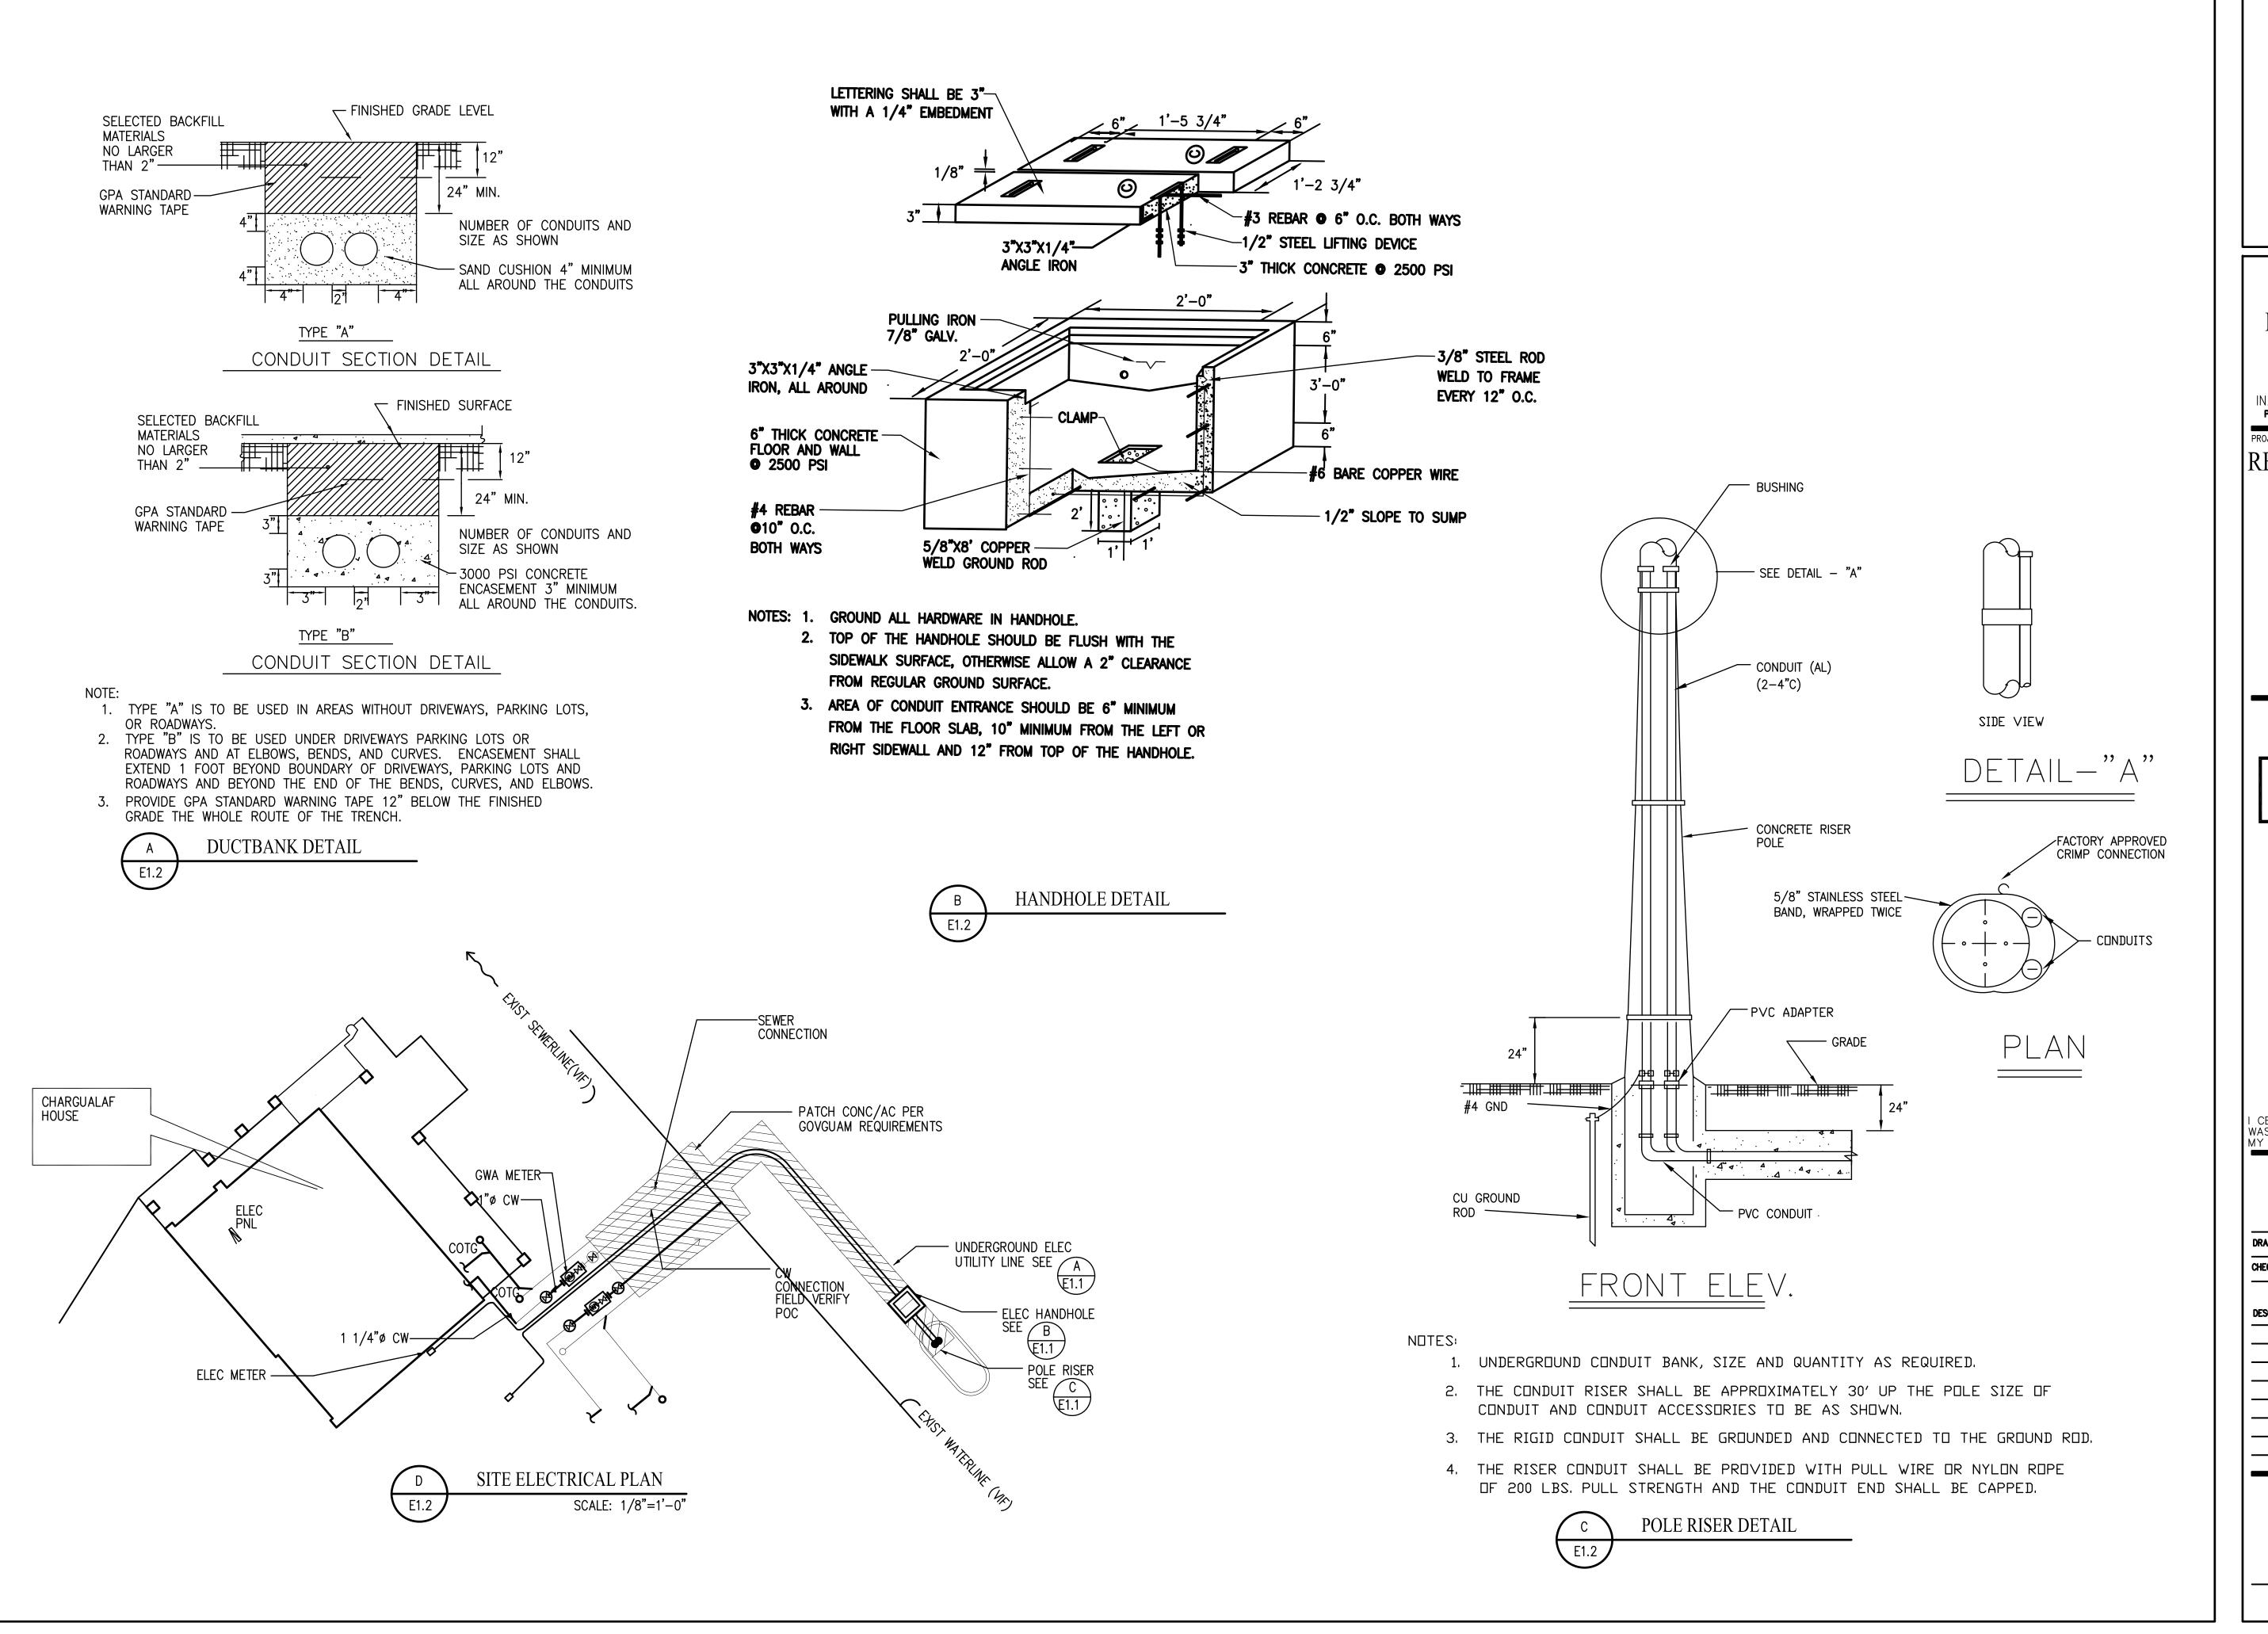

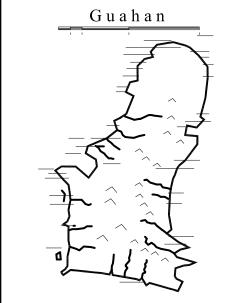

INANGOKKON INADAHI GUÅHAN P.O. BOX 3036, HAGATNA, GUAM 96932

PROJECT TITLE:

RECONSTRUCTION

ANTONIO CHARGUALAF HOUSE,

> HISTORIC DISTRICT OF INARAJAN,

INARAJAN, GUAM

DESIGN CONSULTANT:








I CERTIFY THAT THIS DRAWING WAS PREPARED BY ME OR UNDER MY DIRECT SUPERVISION.


DRAWING NAME:

SITE PLAN AND DETAILS

DRAWN:	TC	DATE:	2014
CHECKED:	WW	SCALE:	AS NOTED
	REVIS	IONS:	
DESCRIPTION			DATE
			<del>                                     </del>
			<del> </del>
			<u> </u>
DRA	WING :	SHEET	NO:

E1.2

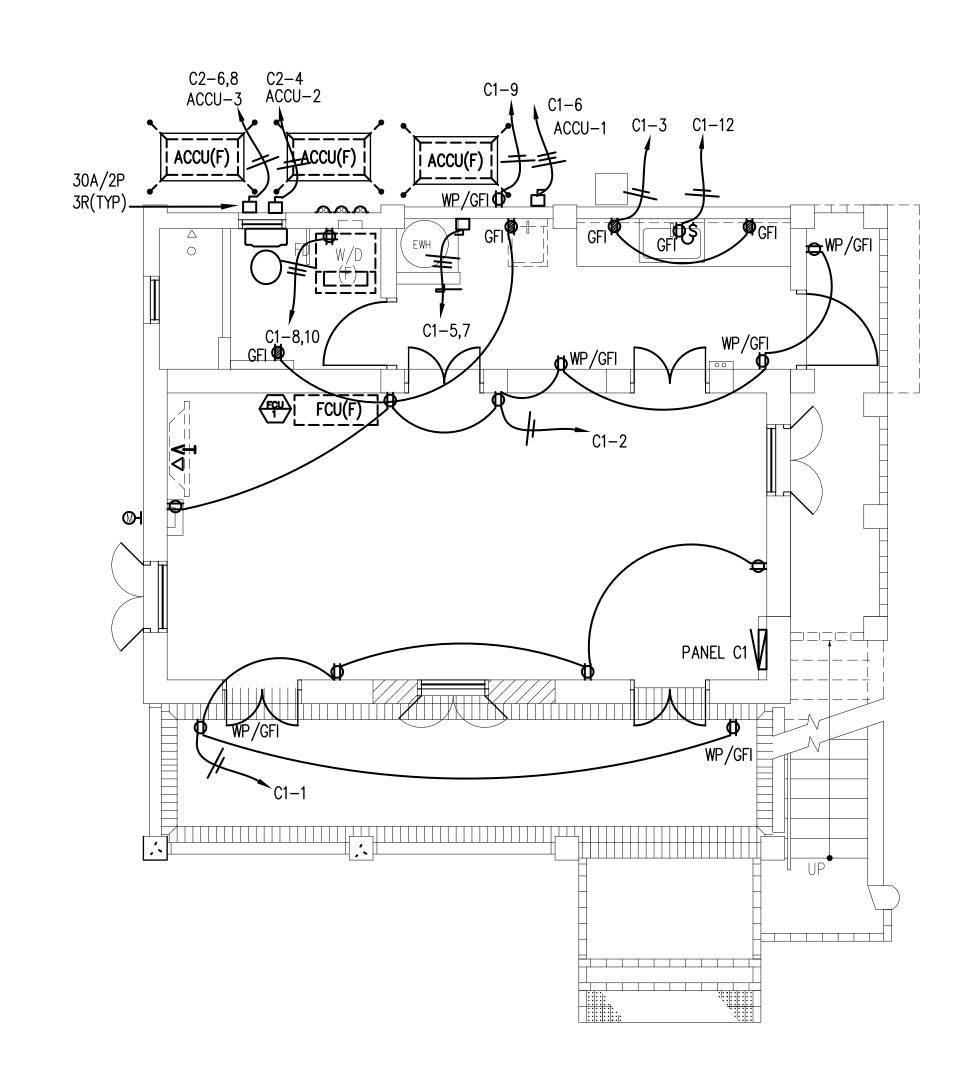


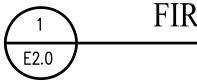

FIRST FLOOR POWER PLAN

SCALE: 1/4" = 1'-0"



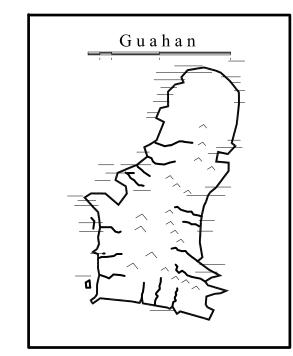

GUAM PRESERVATION TRUST

INANGOKKON INADAHI GUÅHAN P.O. BOX 3036, HAGATNA, GUAM 96932

ROJECT TITLE:

RECONSTRUCTION of ANTONIO CHARGUALAF

HOUSE,

HISTORIC
DISTRICT OF
INARAJAN,
INARAJAN, GUAM

DESIGN CONSULTANT:







I CERTIFY THAT THIS DRAWING WAS PREPARED BY ME OR UNDER MY DIRECT SUPERVISION.


DRAWING NAME:
FIRST FLOOR
POWER PLAN

TC DATE: NOVEMBER 201


CHECKED:	WW	SCALE:	AS NOT
	REVIS	IONS:	
DESCRIPTION			DA

DRAWING SHEET NO:

E2.0

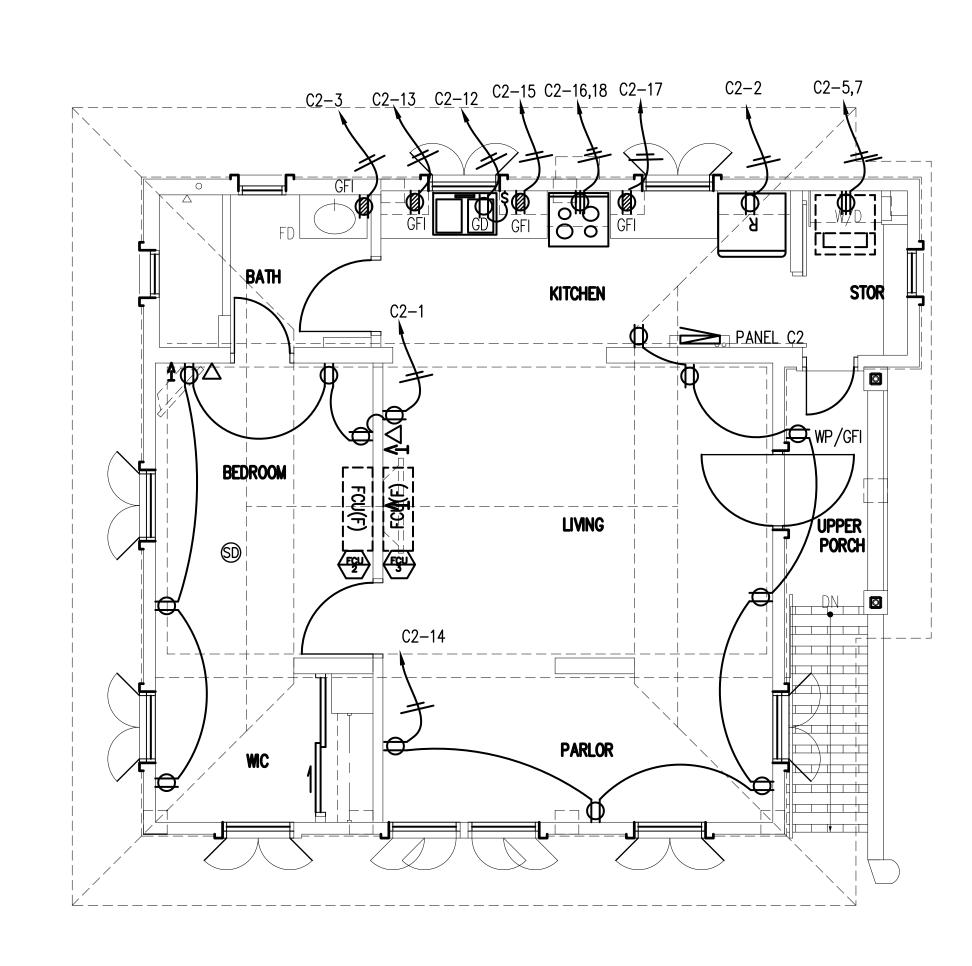



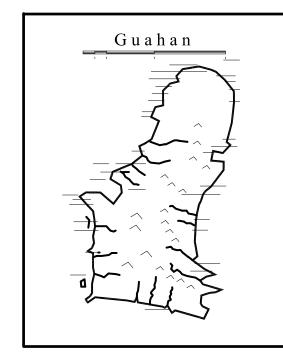

INANGOKKON INADAHI GUÅHAN P.O. BOX 3036, HAGATNA, GUAM 96932


RECONSTRUCTION ANTONIO CHARGUALAF HOUSE,

HISTORIC DISTRICT OF INARAJAN, INARAJAN, GUAM

DESIGN CONSULTANT:






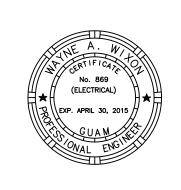


I CERTIFY THAT THIS DRAWING WAS PREPARED BY ME OR UNDER MY DIRECT SUPERVISION.

DRAWING NAME: SECOND FLOOR POWER PLAN

DRAWN:	TC	DATE:	ΝO	VEMBER	201
CHECKED:	WW	SCALE	3	AS N	IOTE
	REVIS	SIONS:			
DESCRIPTION					DATI
				•	
DRA	AWING	SHEE	ΤN	10:	

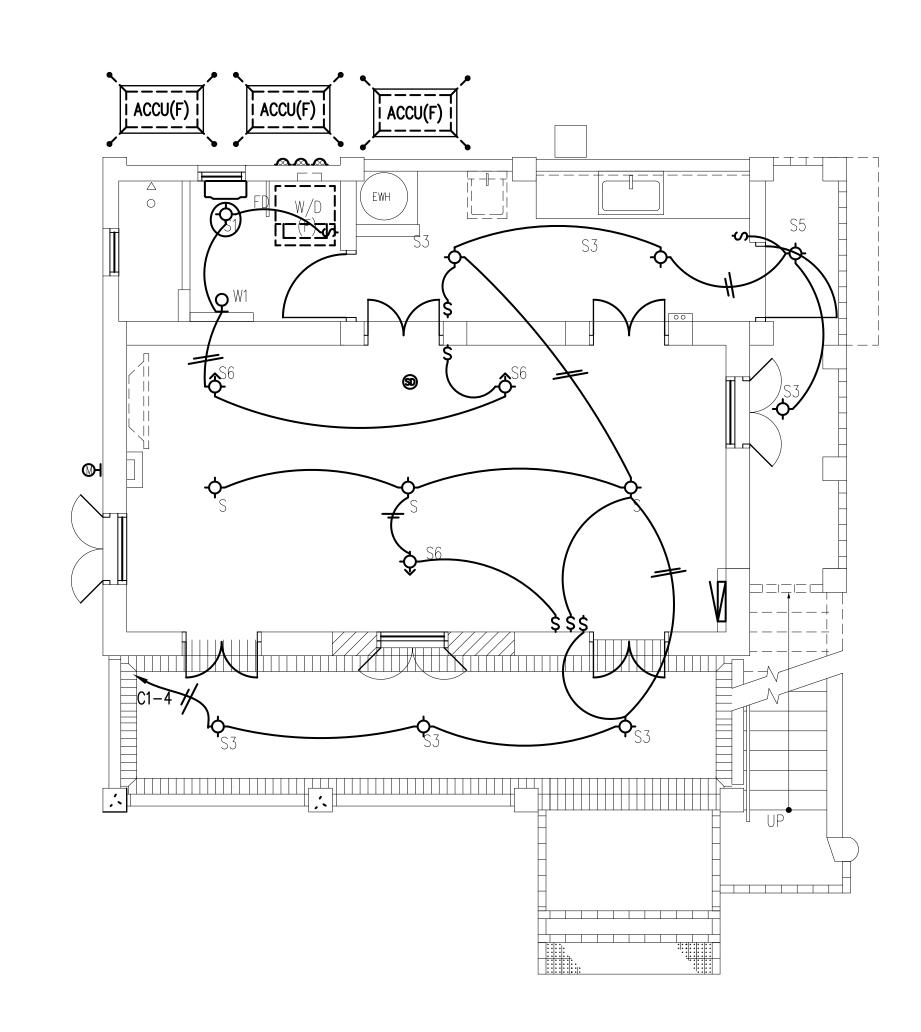



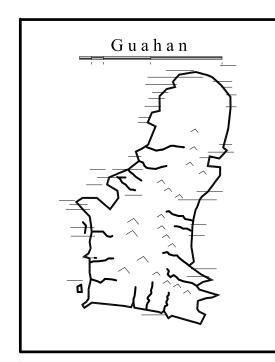

INANGOKKON INADAHI GUÅHAN P.O. BOX 3036, HAGATNA, GUAM 96932

PROJECT TITLE:

RECONSTRUCTION of

ANTONIO CHARGUALAF HOUSE,

HISTORIC DISTRICT OF INARAJAN, INARAJAN, GUAM

DESIGN CONSULTANT:








I CERTIFY THAT THIS DRAWING WAS PREPARED BY ME OR UNDER MY DIRECT SUPERVISION.

DRAWING NAME:
FIRST FLOOR LIGHTING


DRAWN:	TC	DATE:	NOVEMBER 20
CHECKED:	WW	SCALE:	: AS NOTE
	REVIS	IONS:	
DESCRIPTION			DAT
			<u> </u>

DRAWING SHEET NO:

E3.0

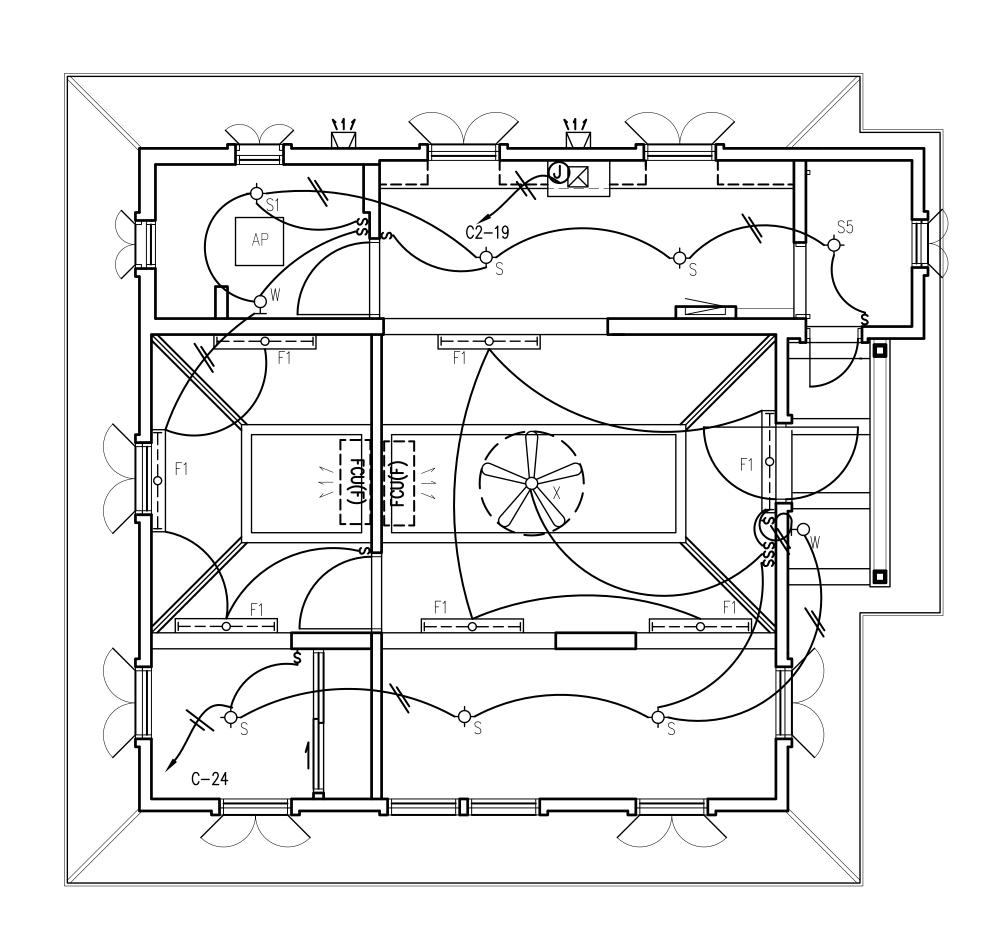



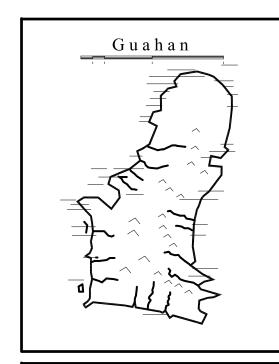

INANGOKKON INADAHI GUÅHAN P.O. BOX 3036, HAGATNA, GUAM 96932

PROJECT TITLE:

RECONSTRUCTION
of
ANTONIO
CHARGUALAF
HOUSE,

HISTORIC DISTRICT OF INARAJAN, INARAJAN, GUAM

DESIGN CONSULTANT:







I CERTIFY THAT THIS DRAWING WAS PREPARED BY ME OR UNDER MY DIRECT SUPERVISION.

DRAWING NAME:
SECOND FLOOR
LIGHTING PLAN

DRAWN:	TC	DATE:	NOVEMBE	₹ 20
CHECKED:	WW	SCALE	: AS	NOT
	REVIS	IONS:		
DESCRIPTION				DA
-				

DRAWING SHEET NO:

E3.1